

JOINT PUBLIC NOTICE

June 22, 2020

United States Army Corps of Engineers
New Orleans District
Regulatory Branch
7400 Leake Avenue
New Orleans, Louisiana 70118

State of Louisiana
Department of Environmental Quality
Water Permits Division
Post Office Box 4313
Baton Rouge, Louisiana 70821-4313

(504) 862-1577
Project Manager
Patricia Clune
Patricia.R.Clune@usace.army.mil
MVN 2019-00524-CE

(225) 219-3225
Project Manager
Elizabeth Hill
WQC Application Number
WQC # WQC 200617-01

Interested parties are hereby notified that a permit application has been received by the New Orleans District of the U.S. Army Corps of Engineers pursuant to: [] Section 10 of the Rivers and Harbors Act of March 3, 1899 (30 Stat. 1151; 33 USC 403); and/or [X] Section 404 of the Clean Water Act (86 Stat. 816; 33 USC 1344).

Application has also been made to the Louisiana Department of Environmental Quality, Water Permits Division, for a Water Quality Certification (WQC) in accordance with statutory authority contained in LRS30:2047 A(3), and provisions of Section 401 of the Clean Water Act (P.L.95-17).

PROPOSED EXPANSION AND MODERNIZATION OF HOLDEN MILL IN LIVINGSTON PARISH

NAME OF APPLICANT: Weyerhaeuser NR Company, c/o FC&E Engineering, LLC., c/o 917 Marquette Road, Brandon, Mississippi 39042

LOCATION OF WORK: In wetlands at the Weyerhaeuser Holden Mill, in Holden Louisiana, Livingston Parish at Latitude: 30.50872, Longitude: -90.63661 within the Tickfaw River basin in hydrological unit (HUC 08070203), as shown in the attached drawings.

CHARACTER OF WORK: The applicant has requested an after-the-fact Department of the Army permit for the authorization to clear, grade, excavate and deposit fill and/or aggregate material to expand and modernize the Holden Mill including the addition of a second continuous dry-fired kiln, expanded access road, process equipment, buildings and log storage area. The project also includes the construction of additional storm water conveyances and the conversion of an existing wet decking pond into a stormwater retention pond. Approximately 13,582 cubic yards of fill will be placed on site to achieve required grade elevations and the excavation of 998 cubic yards material. The proposed project will impact 2.1 acres of wetlands. The applicant stated

that the proposed project was designed to avoid and minimize direct and secondary adverse impacts to the maximum extent practicable.

The comment period for the Department of the Army Permit modification and the Louisiana Department of Environmental Quality WQC will close **20 days** from the date of this joint public notice. Written comments, including suggestions for modifications or objections to the proposed work, stating reasons thereof, are being solicited from anyone having interest in this permit and/or this WQC request and must be mailed so as to be received before or by the last day of the comment period. Letters concerning the Corps of Engineers permit modification application must reference the applicant's name and the Permit Application Number, and be mailed to the Corps of Engineers at the address above, **ATTENTION: REGULATORY BRANCH. Similar letters concerning the Water Quality Certification must reference the applicant's name and the WQC Application number and be mailed to the Louisiana Department of Environmental Quality at the address above.** Individuals or parties may request an extension of time in which to comment on the proposed work by writing or e-mailing the Corps of Engineers Project Manager listed above. Any request must be specific and substantively supportive of the requested extension, and received by this office prior to the end of the initial comment period. The Section Chief will review the request and the requestor will be promptly notified of the decision to grant or deny the request. If granted, the time extension will be continuous to the initial comment period and, inclusive of the initial comment period, will not exceed a total of 30 calendar days.

The application for this proposed project is on file with the Louisiana Department of Environmental Quality and may be examined during weekdays between 8:00 a.m. and 4:30 p.m. Copies may be obtained upon payment of costs of reproduction.

Corps of Engineers Permit Criteria

The decision whether to issue a permit will be based on an evaluation of the probable impacts, including cumulative impacts of the proposed activity on the public interest. That decision will reflect the national concern for both protection and utilization of important resources. The benefit which reasonably may be expected to accrue from the proposal must be balanced against its reasonably foreseeable detriments. All factors which may be relevant to the proposal will be considered including the cumulative effects thereof; among those are conservation, economics, aesthetics, general environmental concerns, wetlands, historic properties, fish and wildlife values, flood hazards, floodplain values, land use, navigation, shoreline erosion and accretion, recreation, water supply and conservation, water quality, energy needs, safety, food and fiber production, mineral needs, considerations of property ownership and, in general, the needs and welfare of the people.

The U.S. Army Corps of Engineers is soliciting comments from the public, federal, state, and local agencies and officials, Indian Tribes, and other interested parties in order to consider and evaluate the impacts of this proposed activity. Any

comments received will be considered by the U.S. Army Corps of Engineers to determine whether to make, modify, condition, or deny a permit for this proposal. To make this decision, comments are used to assess impacts on endangered species, historic properties, water quality, general environmental effects, and other public interest factors listed above. Comments are used in the preparation of an Environmental Assessment and/or an Environmental Impact Statement pursuant to the National Environmental Policy Act. Comments are also used to determine the need for a public hearing and to determine the overall public interest of the proposed activity.

The New Orleans District is unaware of properties listed on the National Register of Historic Places near the proposed work. The possibility exists that the proposed work may damage or destroy presently unknown archeological, scientific, prehistorical, historical sites, or data. Copies of this notice are being sent to the State Archeologist and the State Historic Preservation Officer.

Our initial finding is that the proposed work would not affect any species, nor affect any habitat designated as critical to the survival and recovery of such species, listed as endangered by the U.S. Department of Interior. Utilizing Standard Local Operating Procedure for Endangered Species in Louisiana (SLOPES), dated October 22, 2014, between the U.S. Army Corps of Engineers, New Orleans and U.S. Fish and Wildlife Service, Ecological Services Office, the Corps has determined that the proposed activity would have no effect on any listed species.


This notice initiates the Essential Fish Habitat (EFH) consultation requirements of the Magnuson-Stevens Fishery Conservation and Management Act. The applicant's proposal would not result in the destruction or alteration of EFH utilized by various life stages of red drum and penaeid shrimp. Our initial determination is that the proposed action would not have a substantial adverse impact on EFH or federally managed fisheries in the Gulf of Mexico. Our final determination relative to project impacts and the need for mitigation measures is subject to review by and coordination with the National Marine Fisheries Service.

If the proposed work involves deposits of dredged or fill material into navigable waters, the evaluation of the probable impacts will include the application of guidelines established by the Administrator of the Environmental Protection Agency. Also, a certification that the proposed activity will not violate applicable water quality standards has been submitted to the Department of Environmental Quality, Office of Environmental Services under permit number 200617-01.

Any person may request, in writing, within the comment period specified in this notice, that a public hearing be held to consider this application. Requests for public hearings shall state, with particularity, the reasons for holding a public hearing. You are requested to communicate the information contained in this notice to any other parties whom you deem likely to have interest in the matter.

John M Herman
Chief, Central Evaluation Section
Regulatory Branch

Enclosure

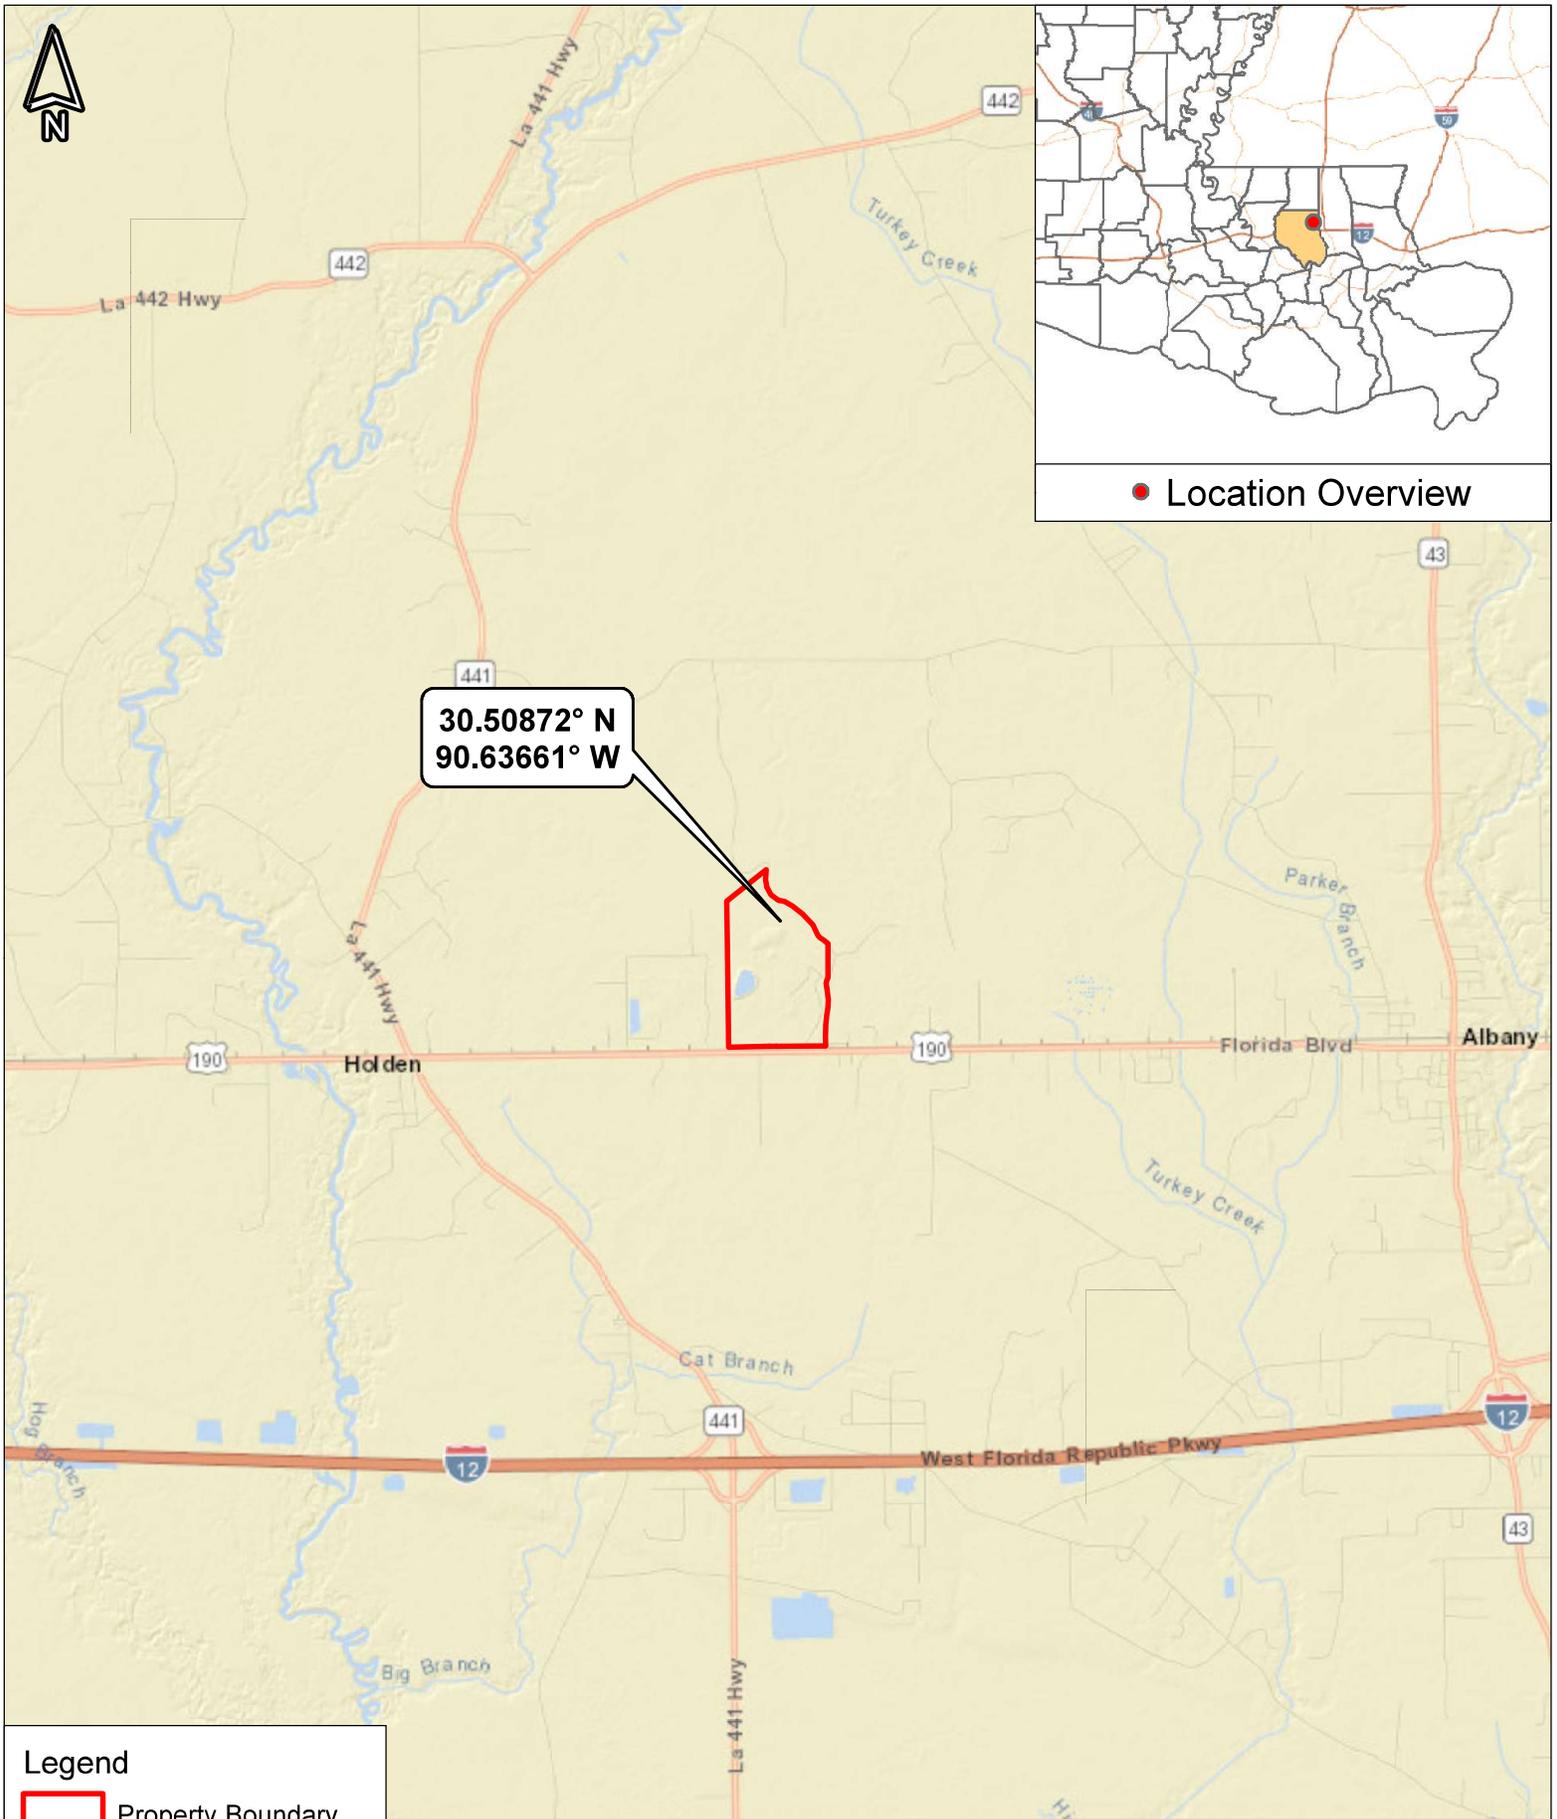

30.50872° N
90.63661° W

● Location Overview

Legend


 Property Boundary



Weyerhaeuser
17391 Florida Blvd
Holden, LA 70744



Figure No.	1
Figure Name	Site Location Map
Purpose	404 Permit Application
Drawn By	jsmith
Date Drawn	05/04/2020

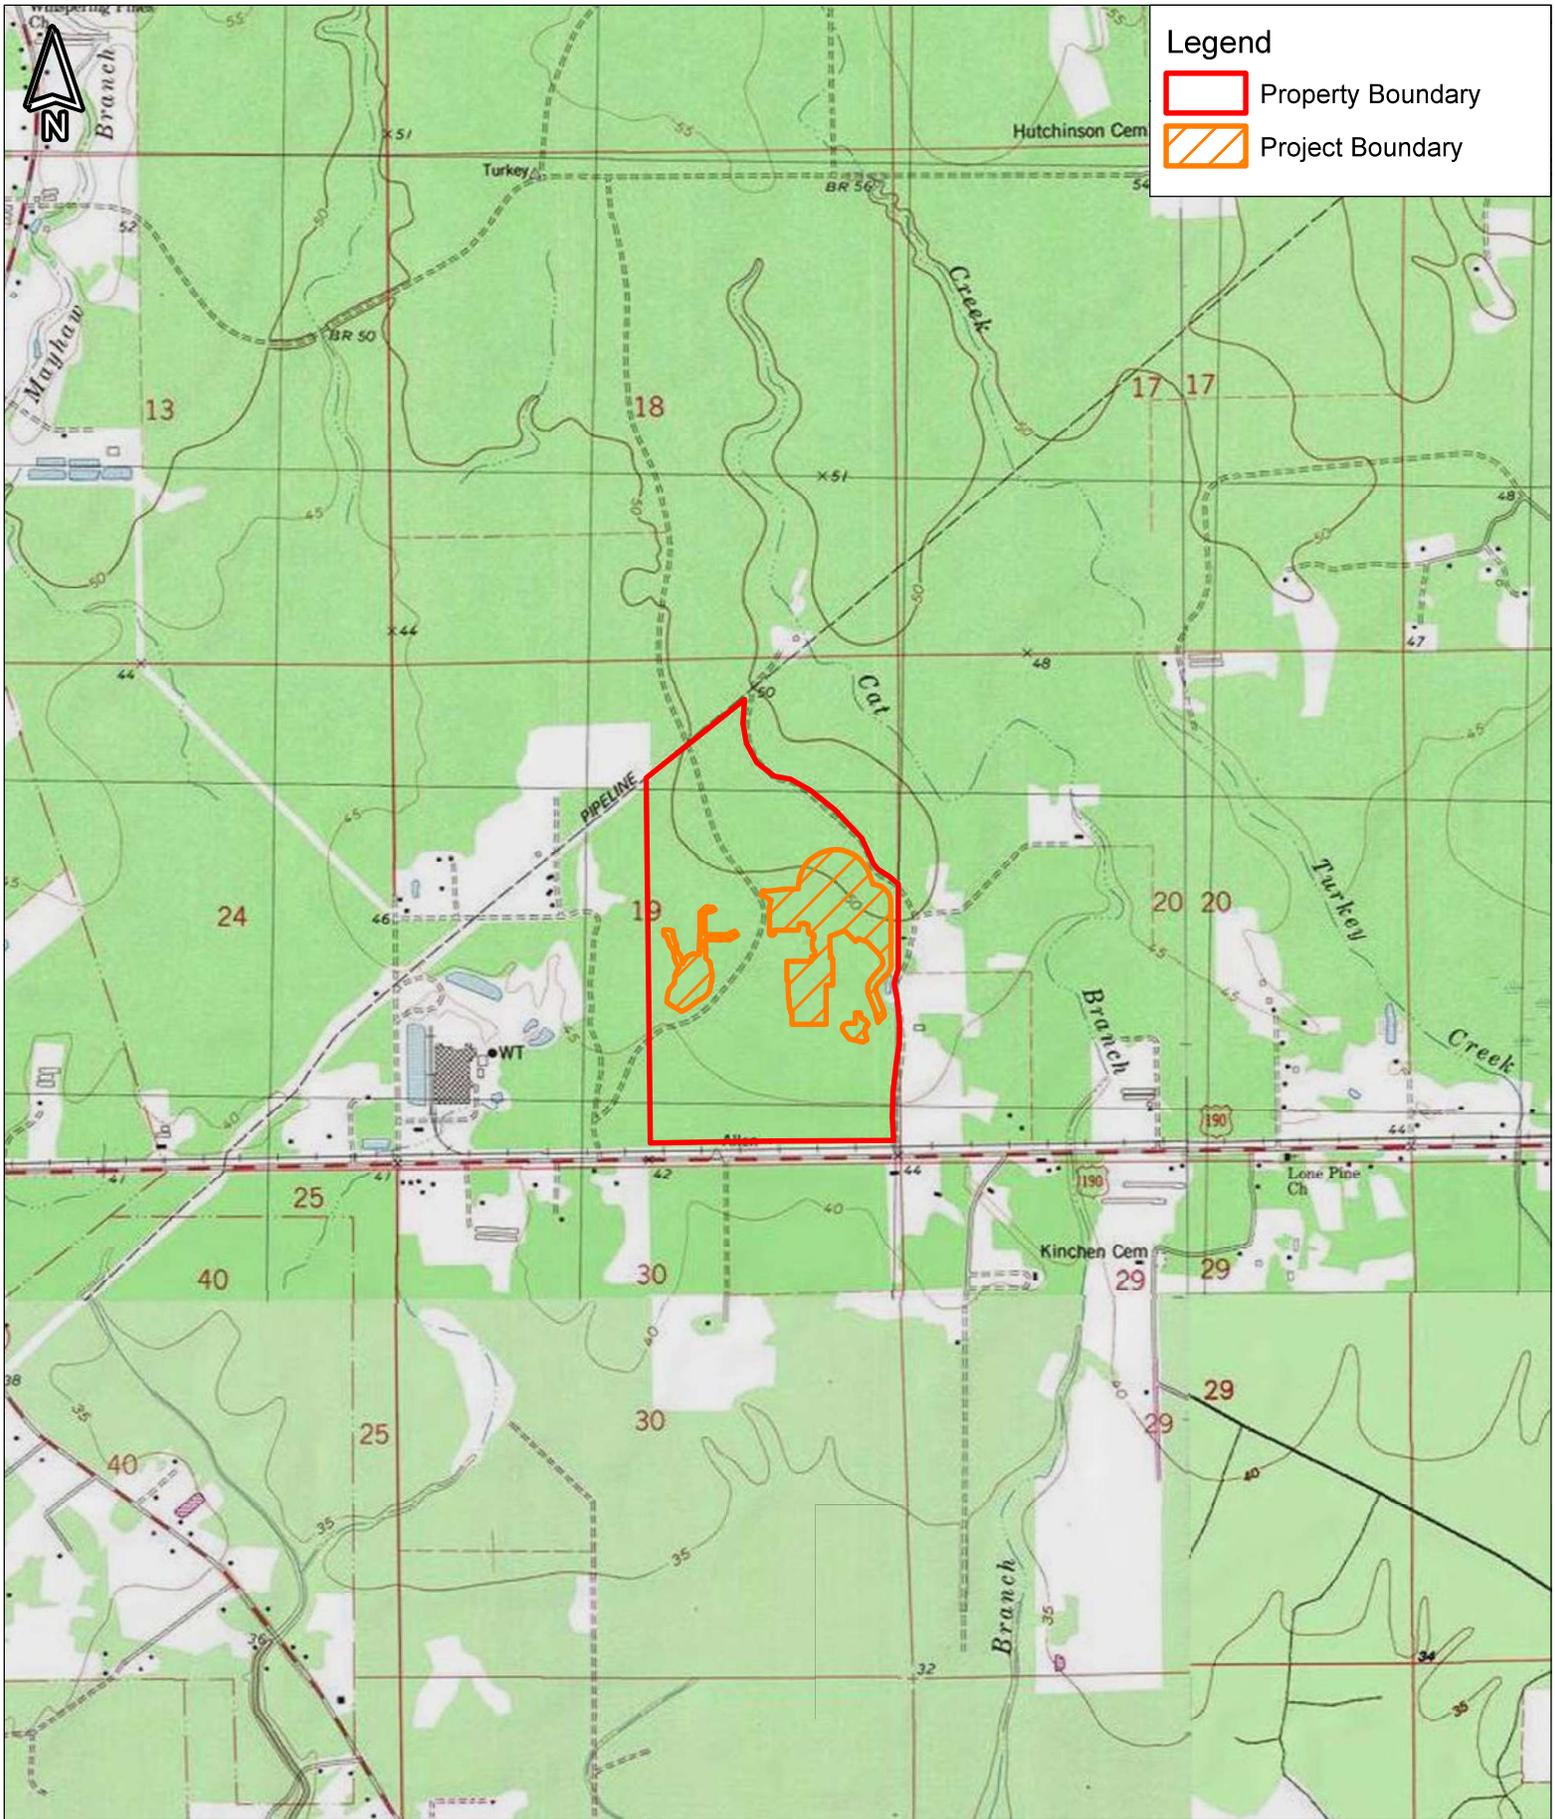

Legend

- Property Boundary
- Project Boundary




FC&E
Engineering, LLC
Water ■ Soils ■ Air ■ Compliance

Weyerhaeuser
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Holden, LA 70744

0 1,000 2,000 4,000
Feet

Figure No.	2
Figure Name	USGS Quad Map
Purpose	404 Permit Application
Drawn By	jsmith
Date Drawn	05/04/2020

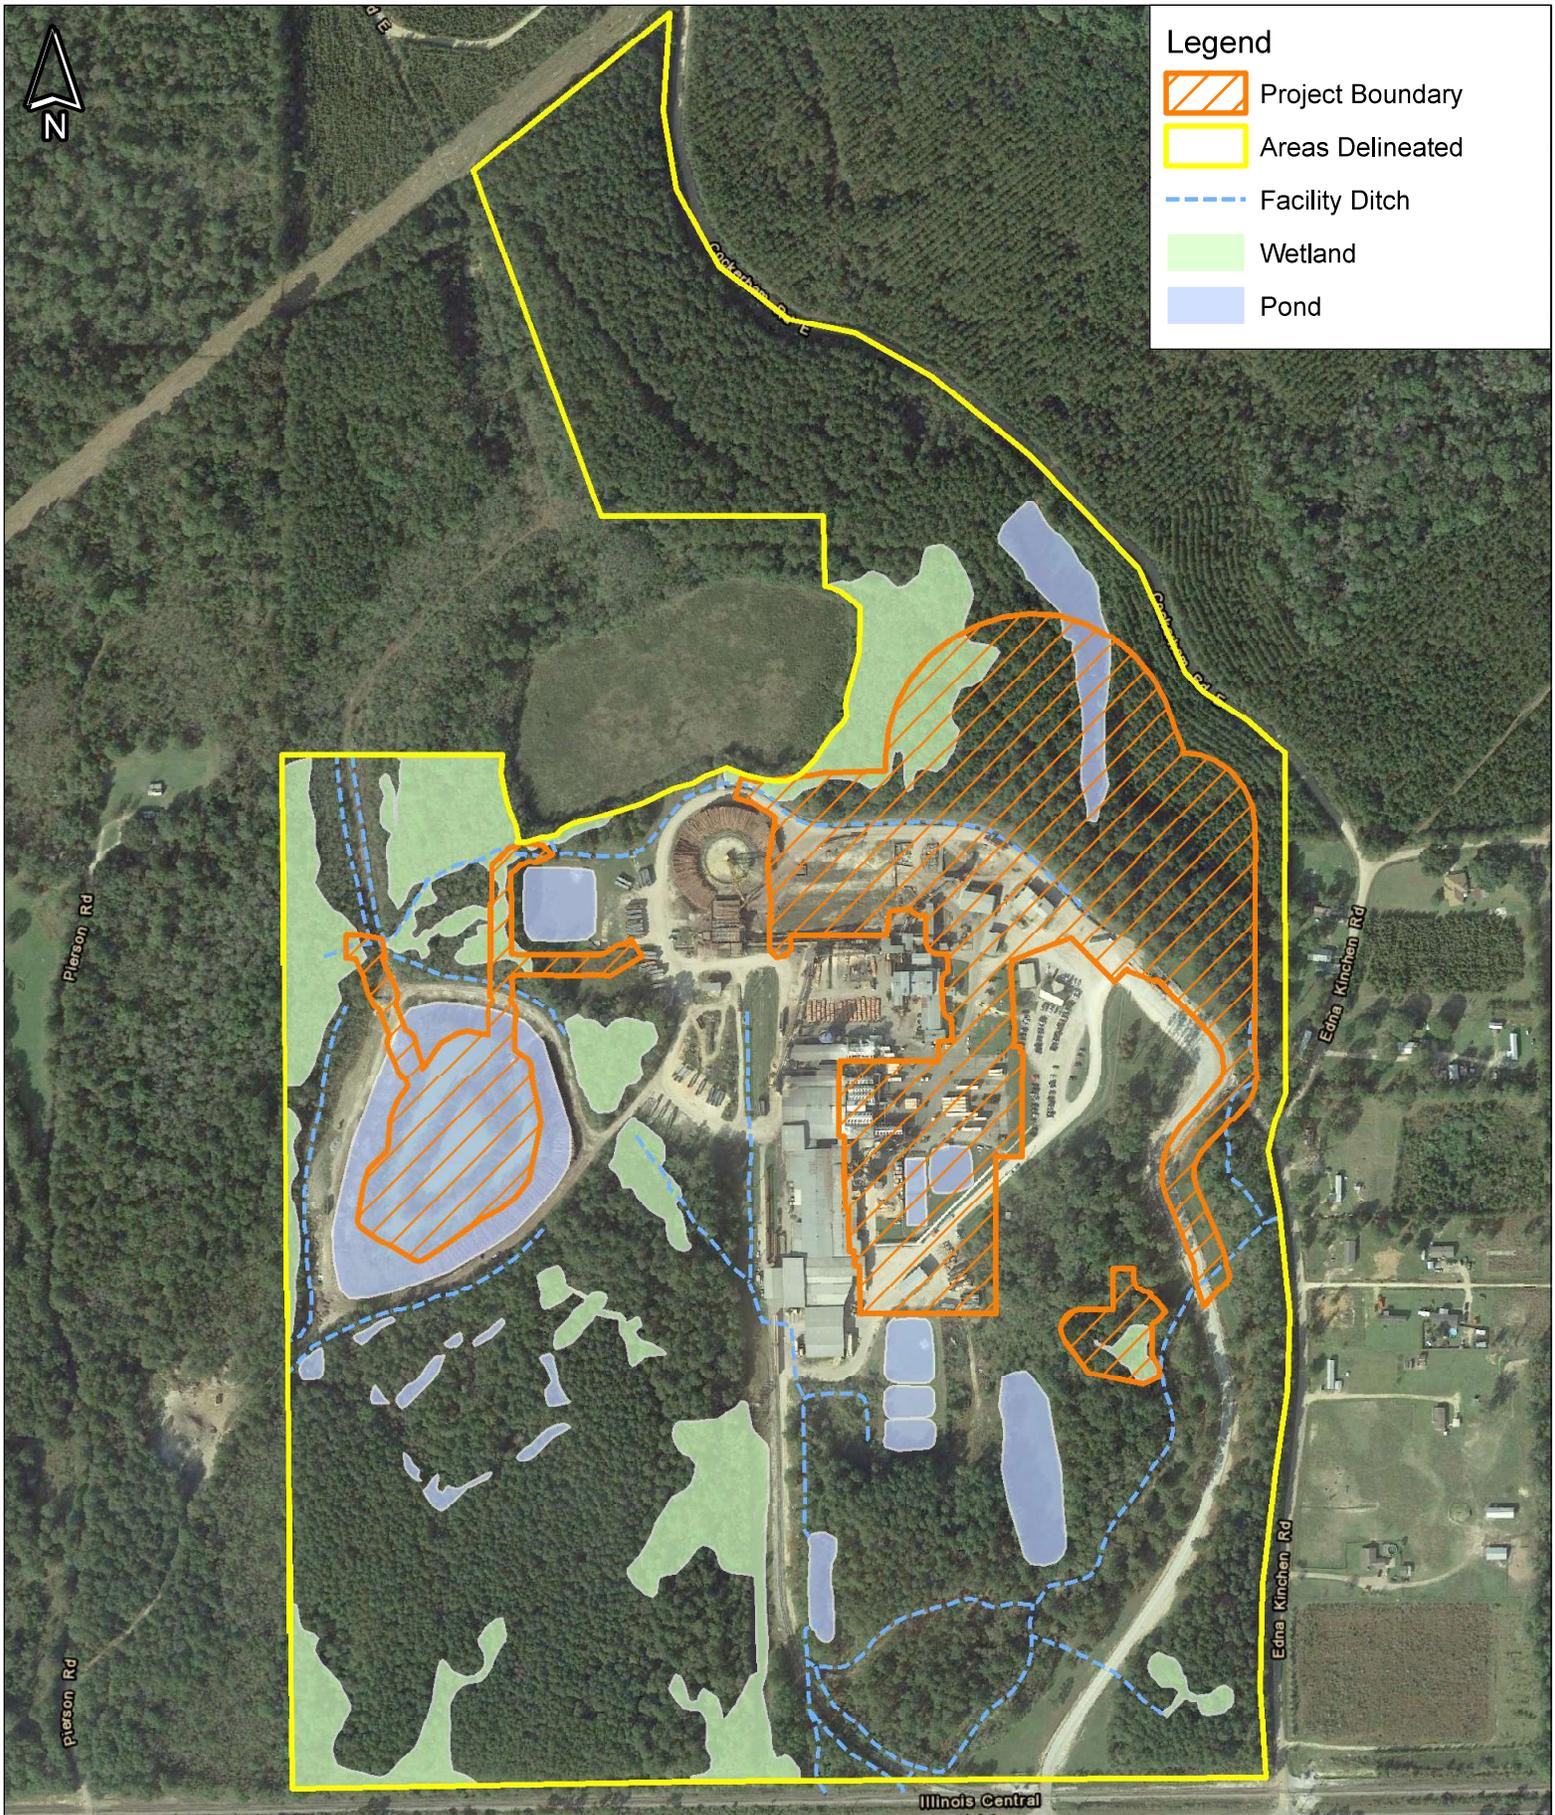

Legend

-  Project Boundary
-  Areas Delineated
-  Facility Ditch
-  Wetland
-  Pond



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0 250 500 1,000
Feet

Figure No.	4
Figure Name	Wetland Map
Purpose	404 Permit Application
Drawn By	jsmith
Date Drawn	05/04/2020



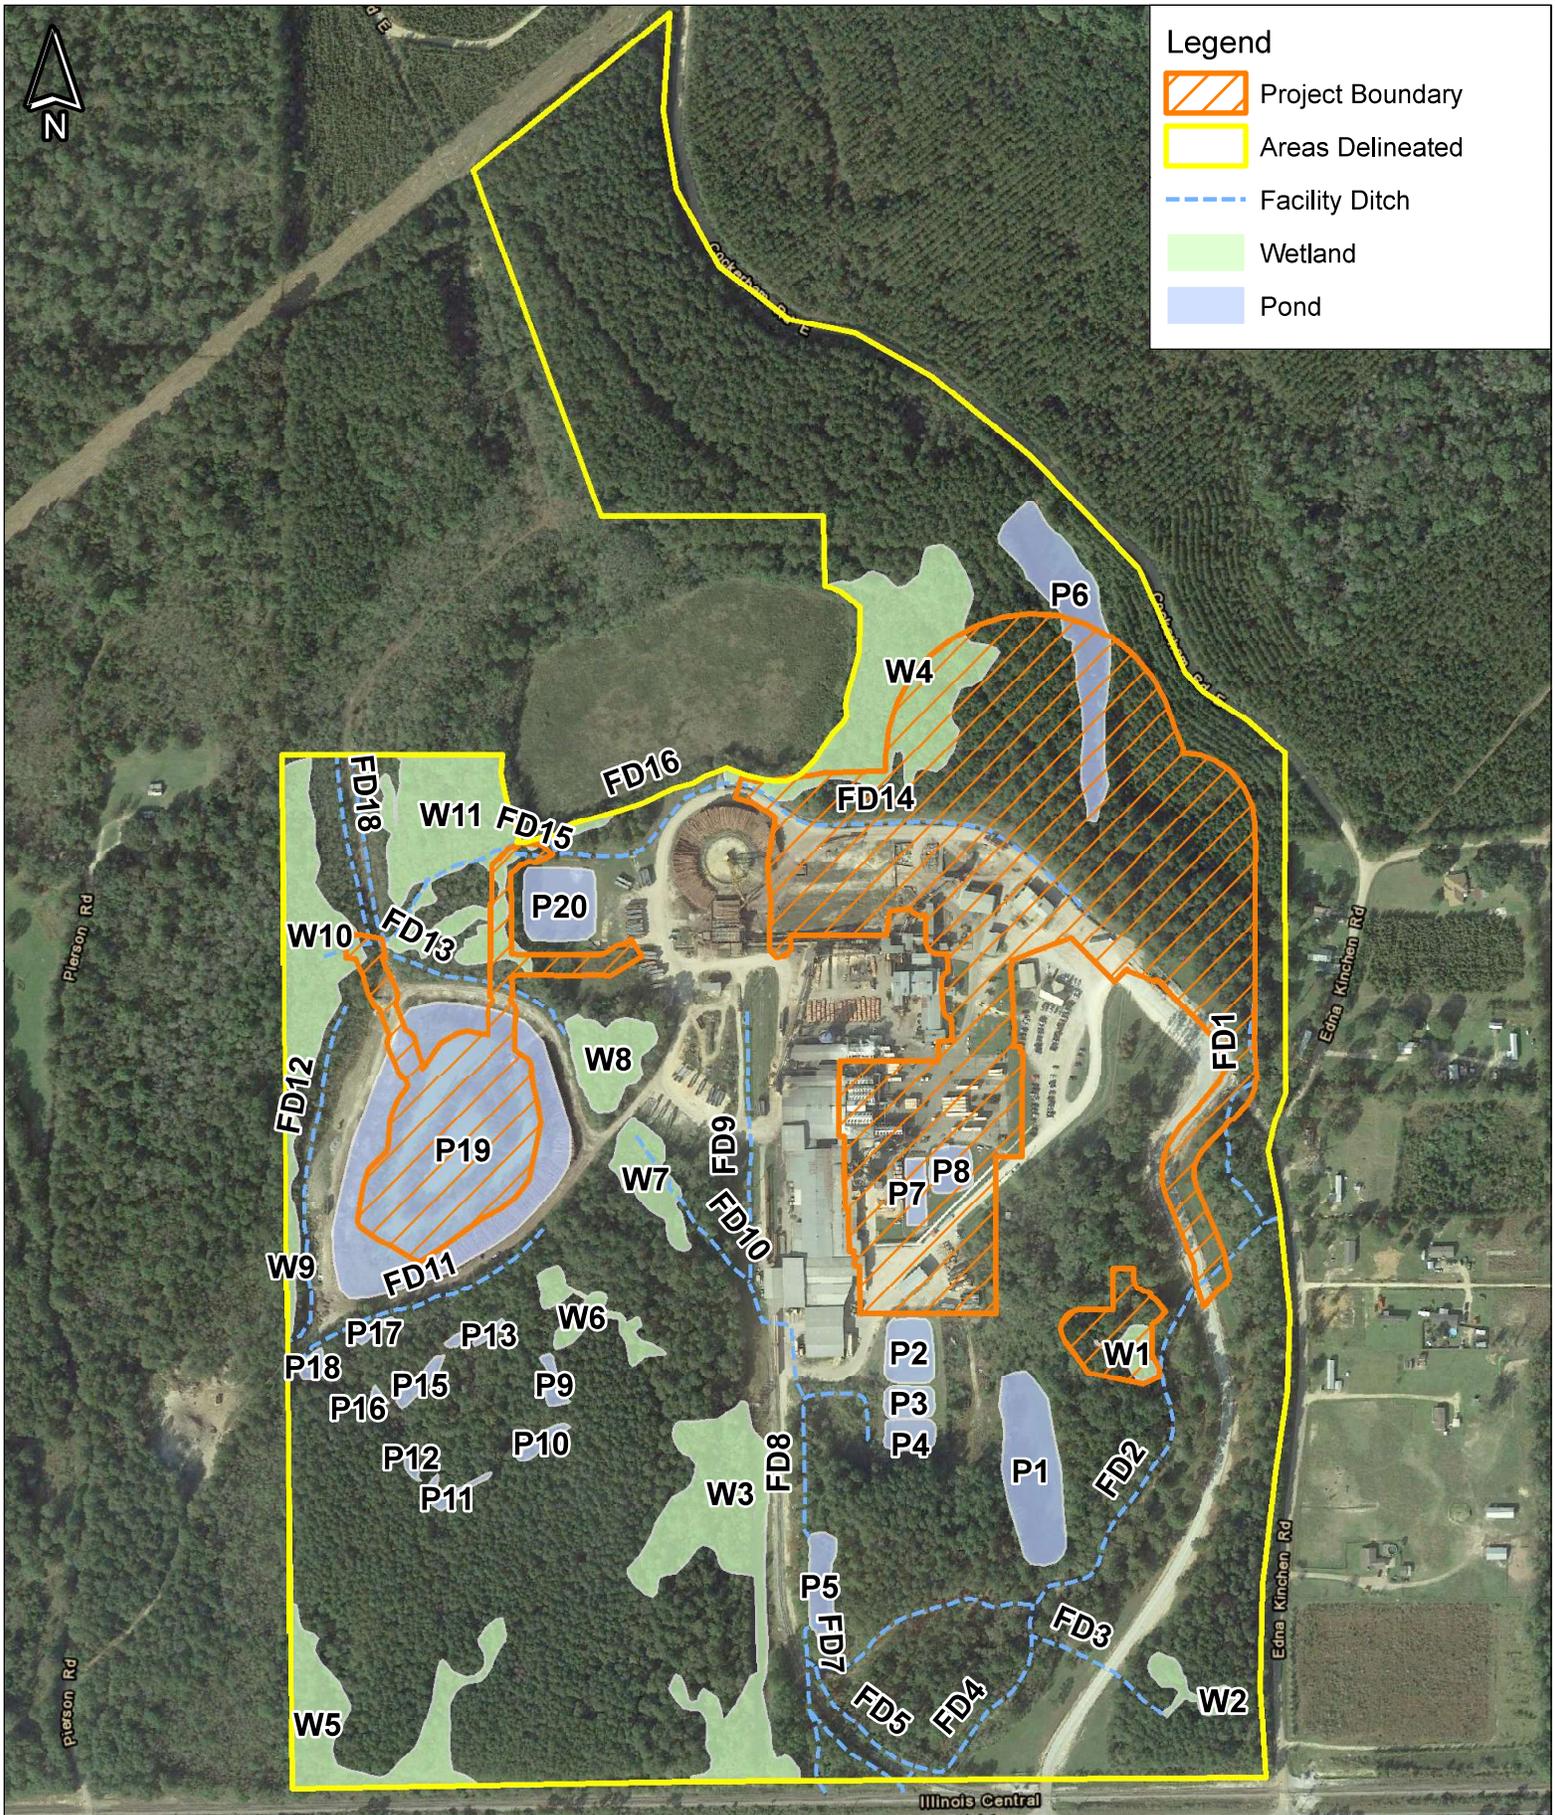


Figure No.	5
Figure Name	Wetland Map
Purpose	404 Permit Application
Drawn By	jsmith
Date Drawn	05/04/2020

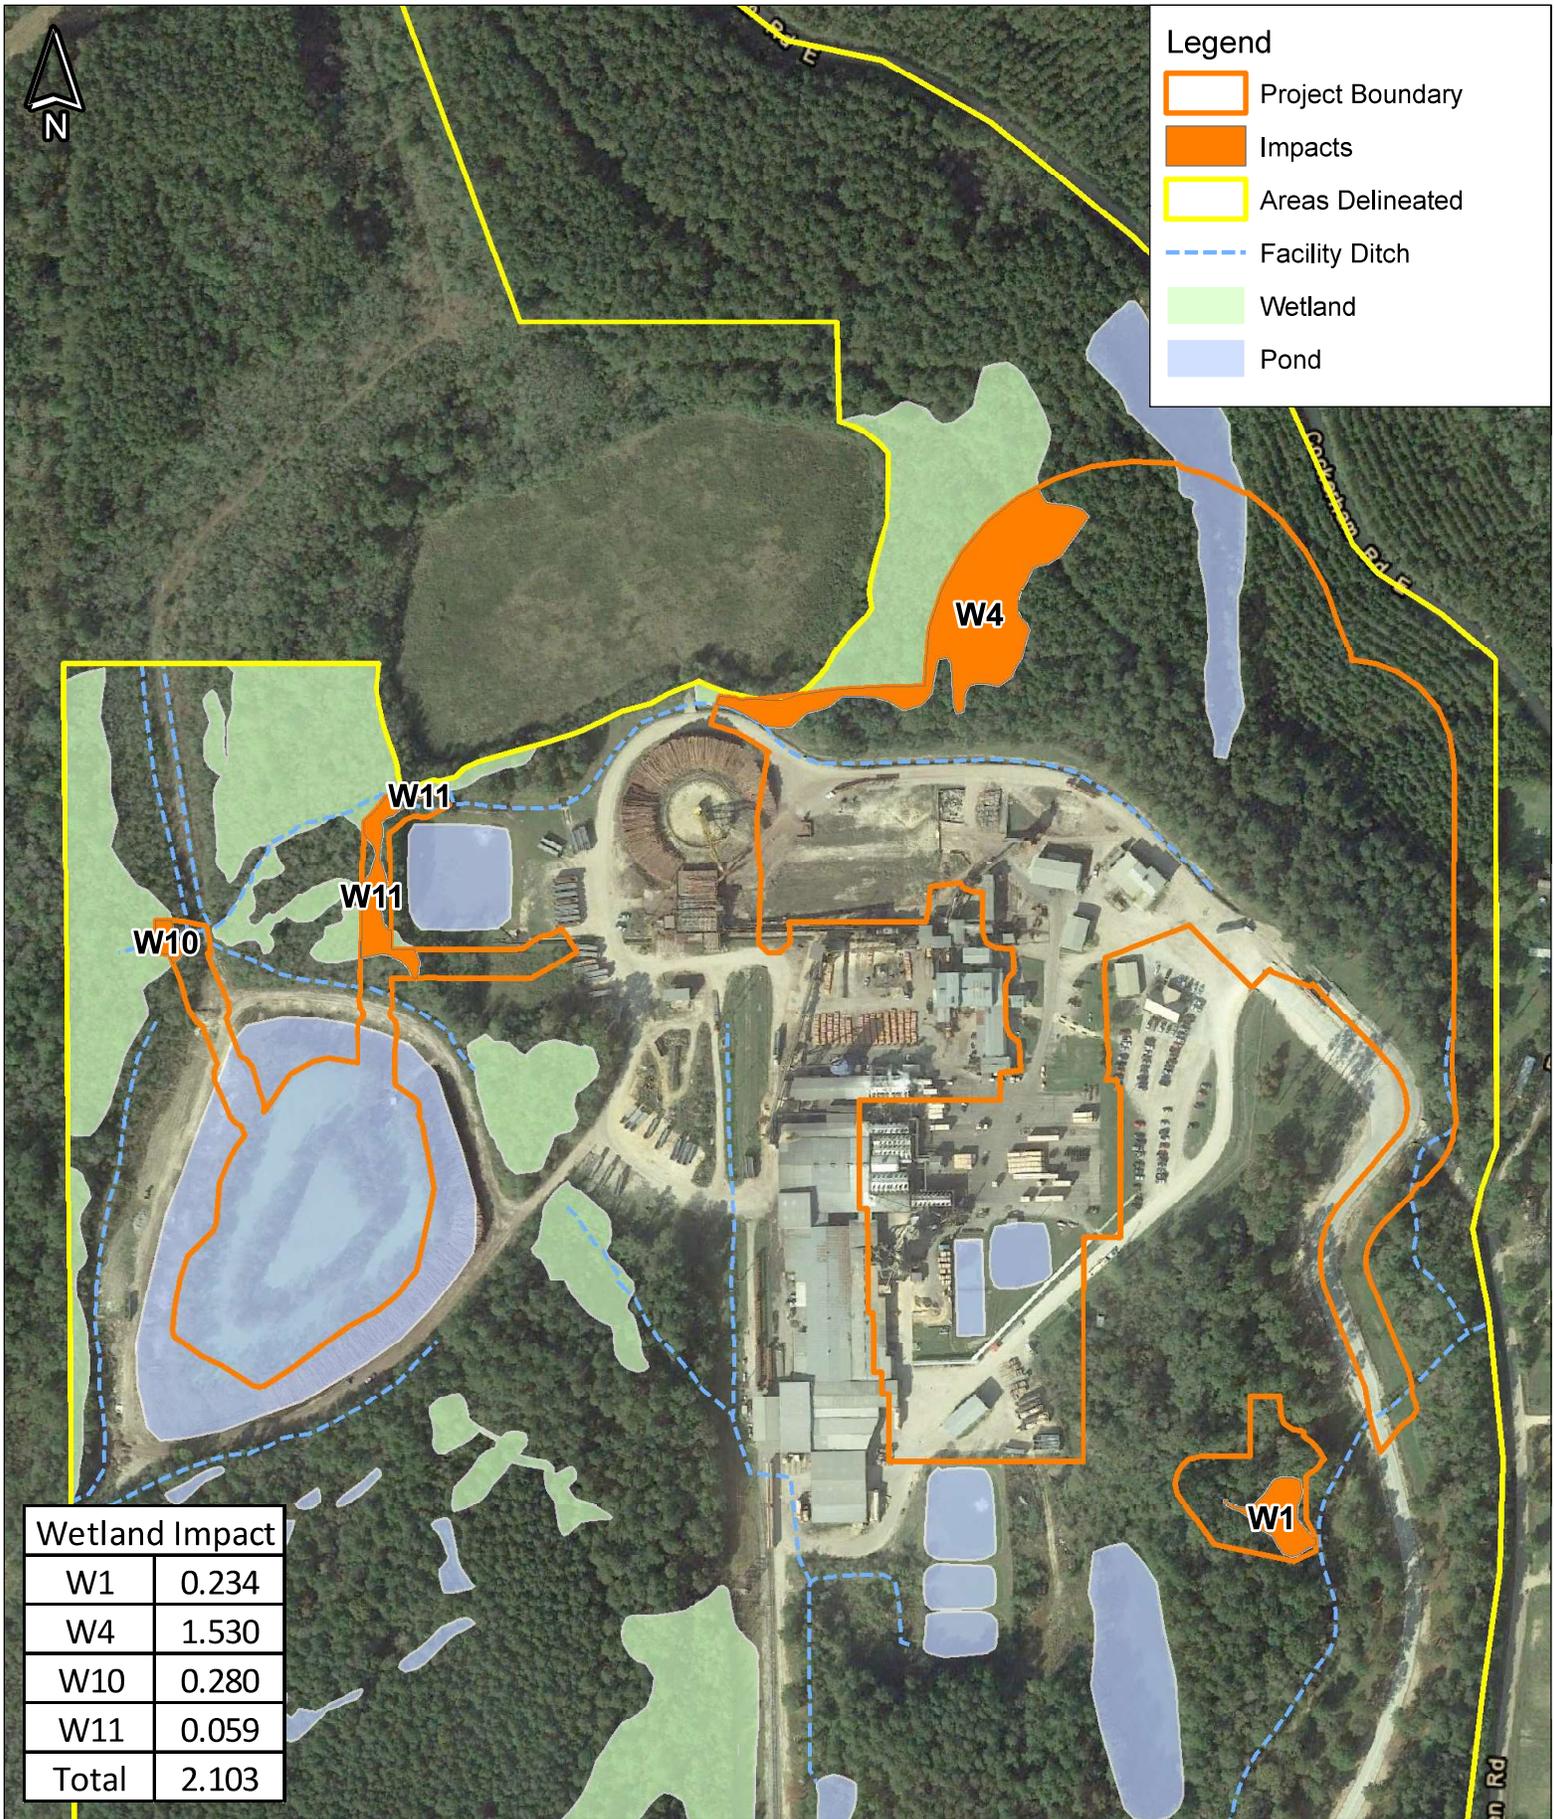

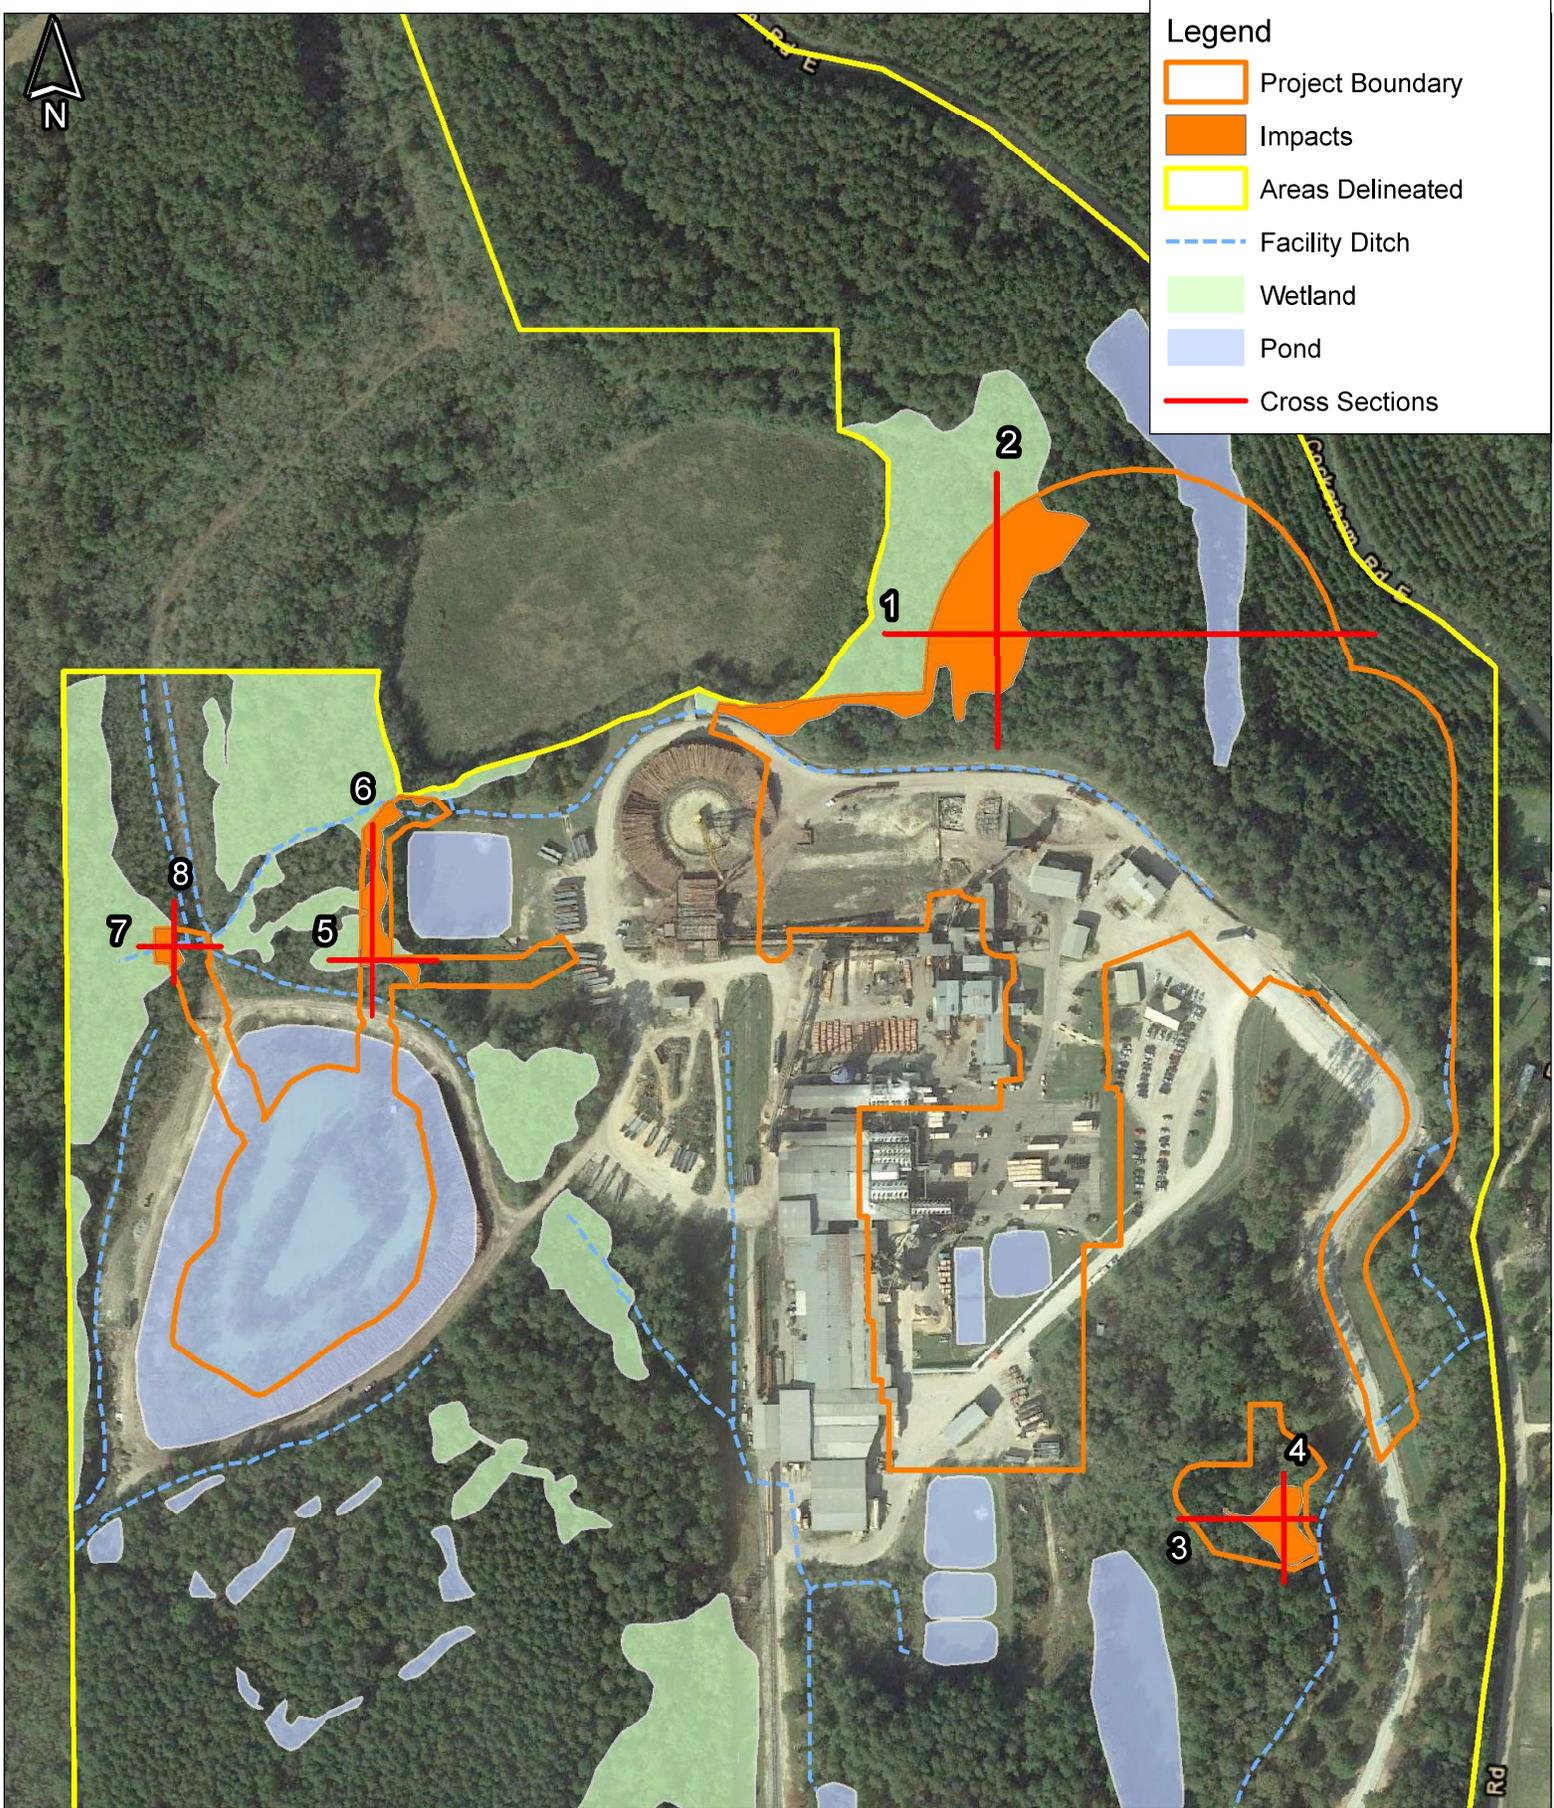


Legend	
	Project Boundary
	Impacts
	Areas Delineated
	Facility Ditch
	Wetland
	Pond
	Cross Sections

<p>FC&E Engineering, LLC Water ■ Soils ■ Air ■ Compliance</p>	<p>Weyerhaeuser 17391 Florida Blvd Holden, LA 70744</p>	<p>Figure No. 7</p>
	<p>0 175 350 700 Feet</p>	<p>Figure Name Cross Section Map</p>
		<p>Purpose 404 Permit Application</p>
		<p>Drawn By jsmith</p>
		<p>Date Drawn 05/04/2020</p>


Legend

- Existing Grade
- Proposed Grade

Alignment 1 PROFILE

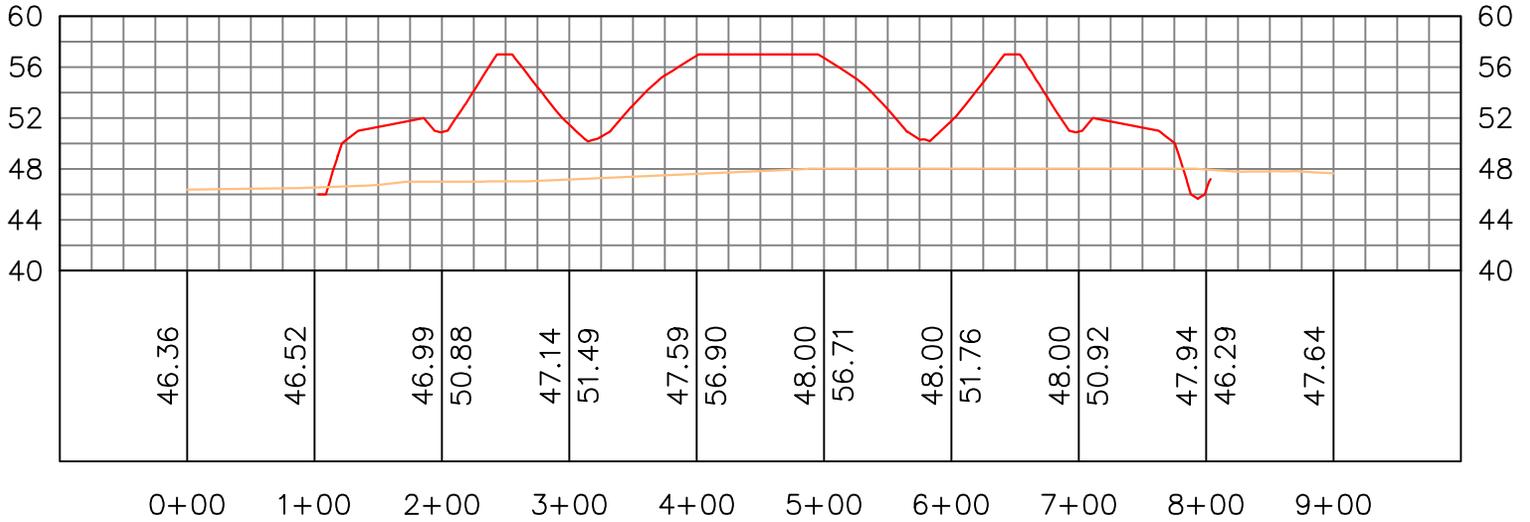

Alignment 2 PROFILE

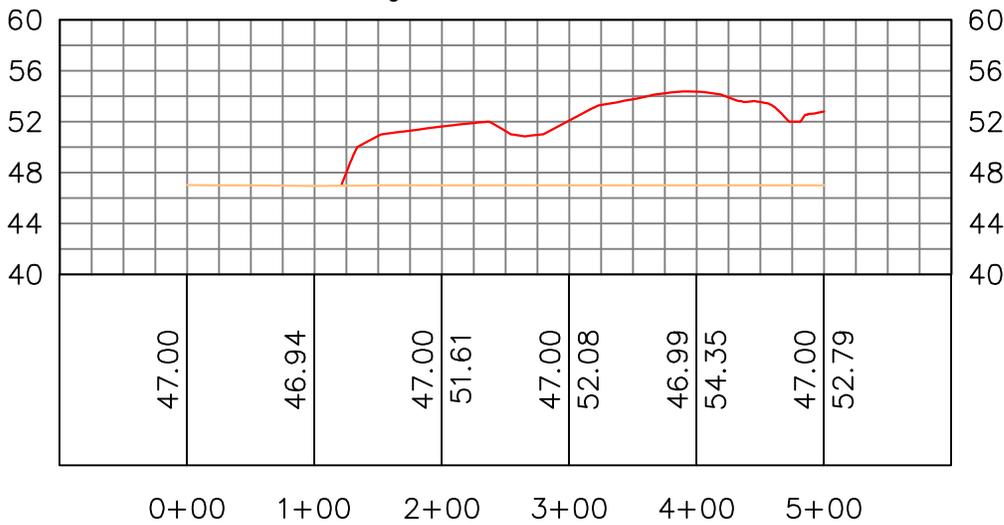


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Figure No.	8
Figure Name	Cross Section
Purpose	404 Permit Application
Drawn By	jsmith
Date Drawn	05/04/2020


Legend

- Existing Grade
- Proposed Grade


Alignment 3 PROFILE

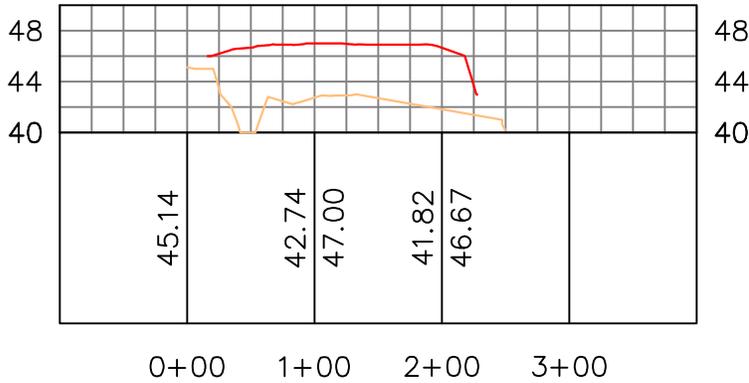


Alignment 4 PROFILE

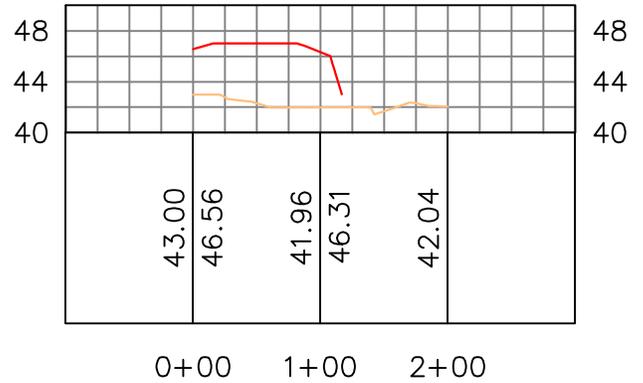


Alignment 5 PROFILE

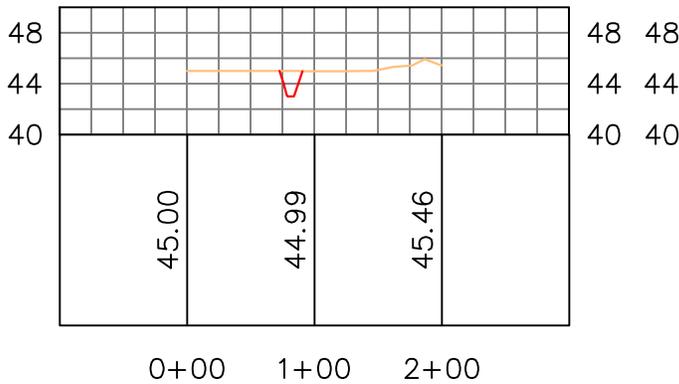


Alignment 6 PROFILE

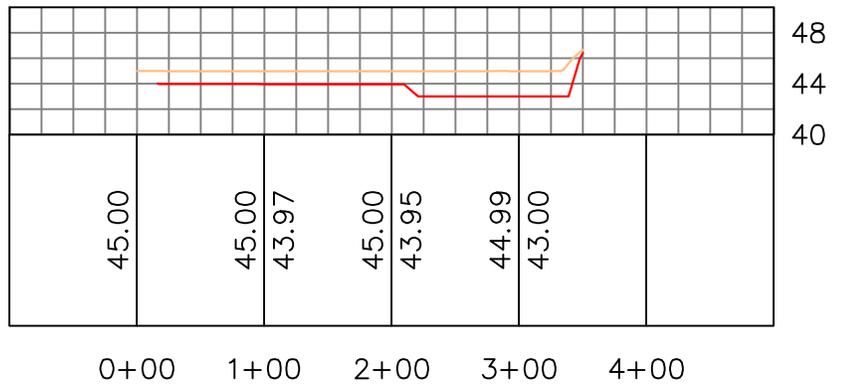

Alignment 7 PROFILE

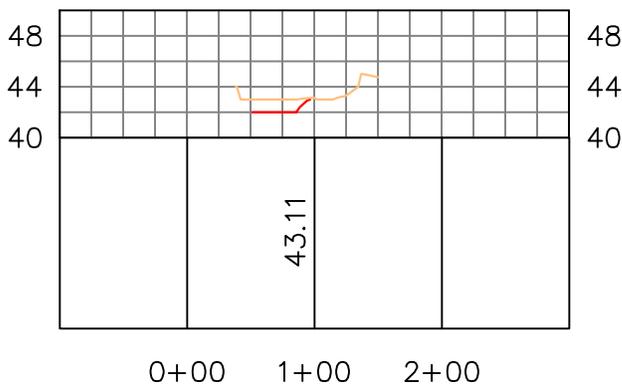

Alignment 8 PROFILE

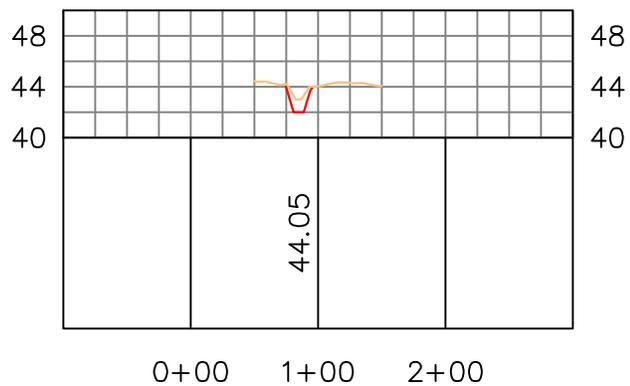


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Figure No.	9
Figure Name	Cross Section
Purpose	404 Permit Application
Drawn By	jsmith
Date Drawn	05/04/2020



Legend

- Property Boundary
- Alternative Property

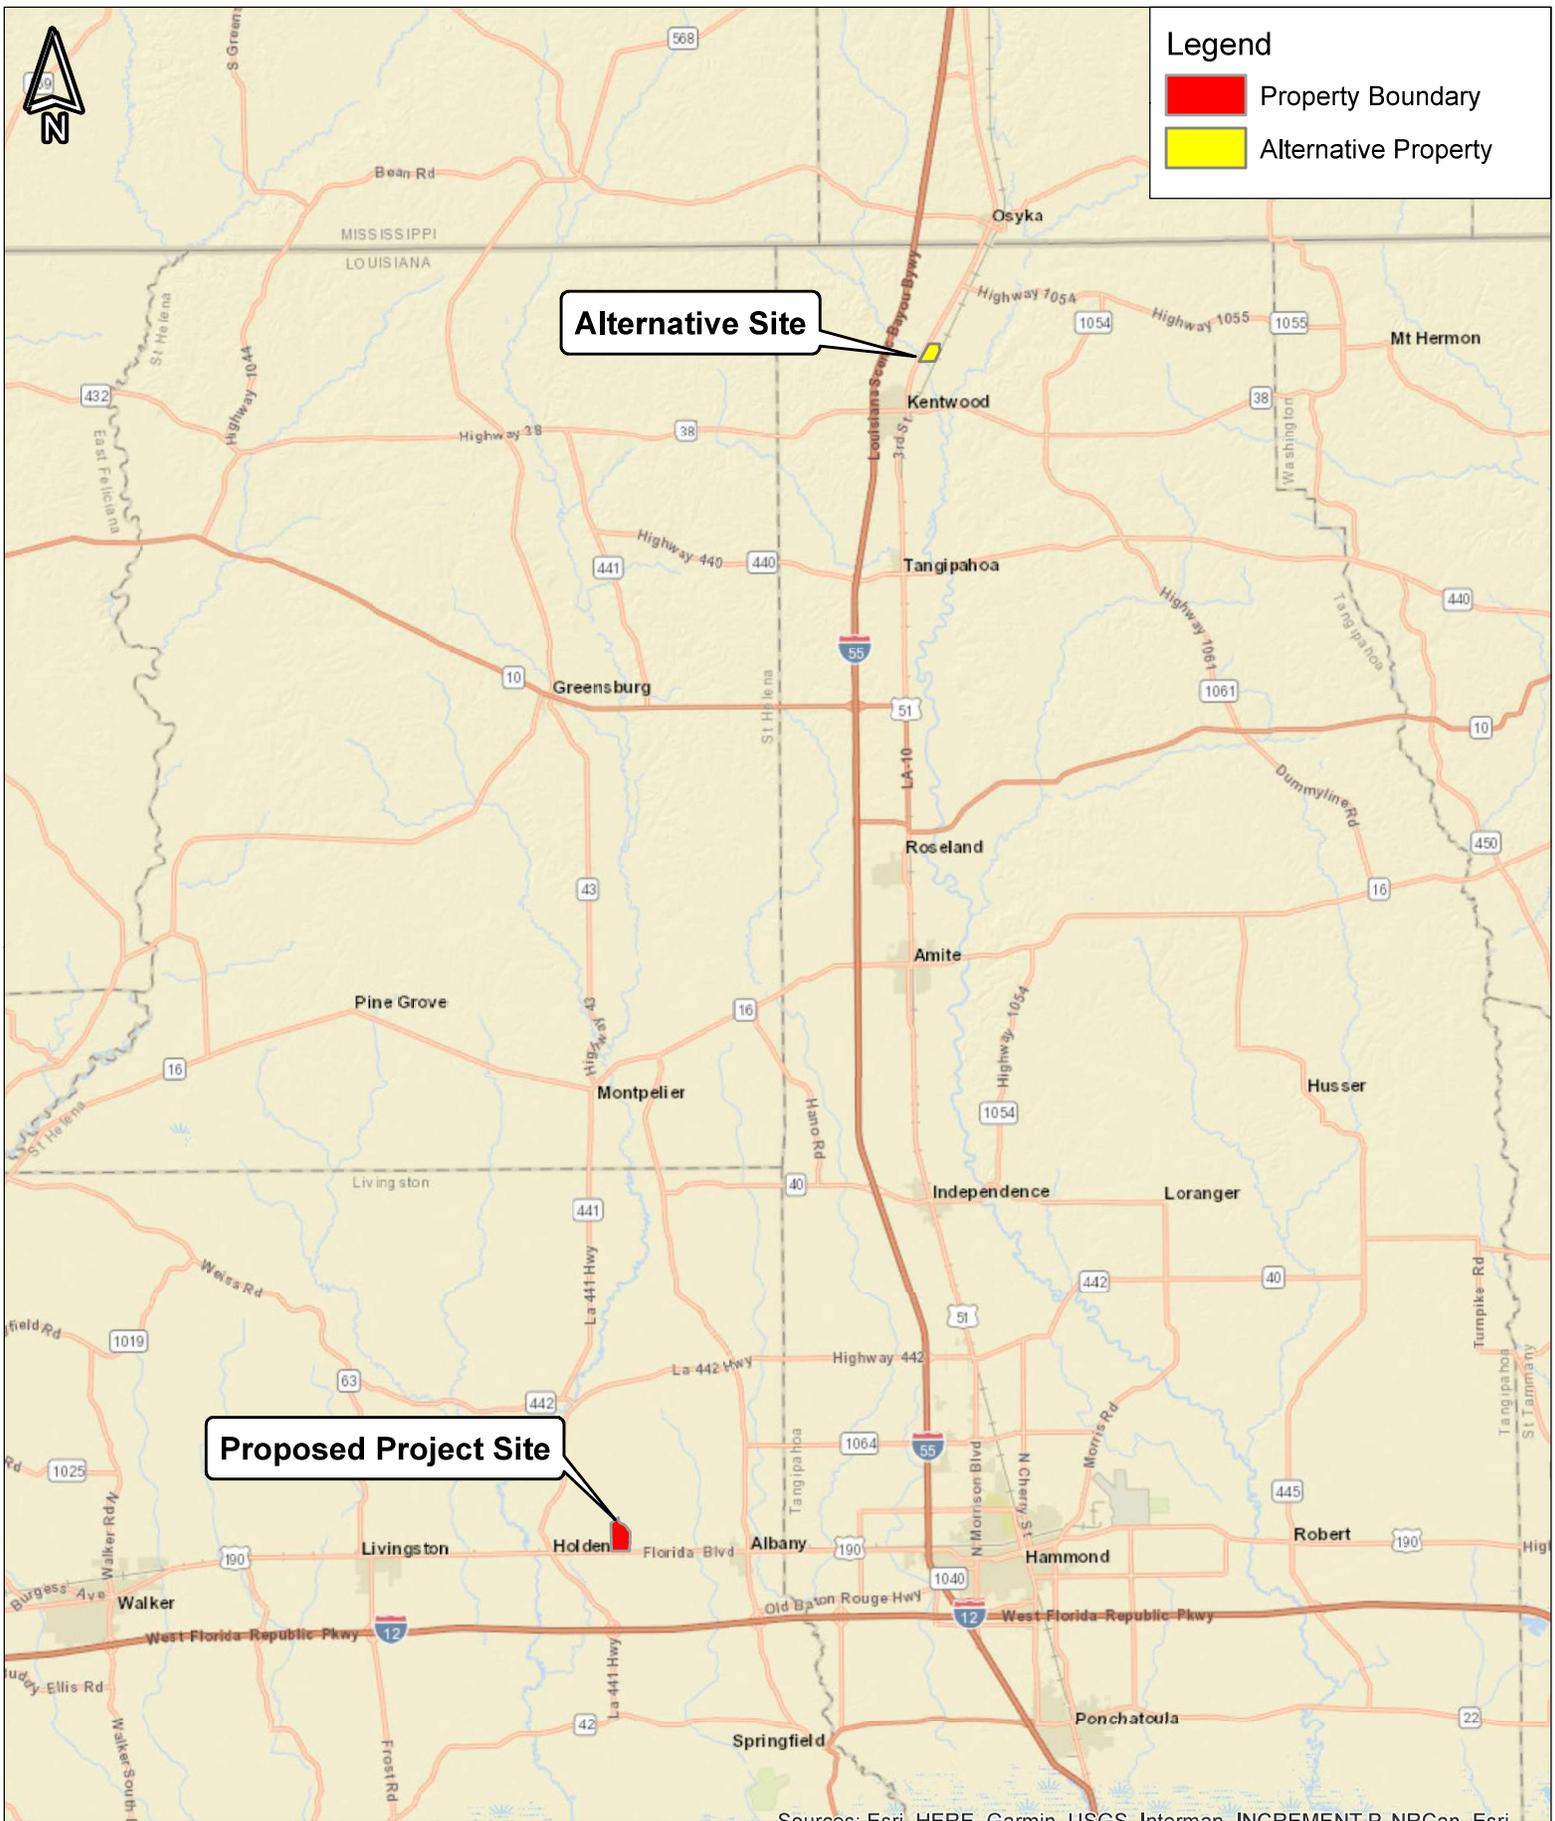

Proposed Project Site


Alternative Site


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Holden, LA 70744

0 2.5 5 10
Miles

Figure No.	10
Figure Name	Location Map
Purpose	Alternative Analysis
Drawn By	jsmith
Date Drawn	05/07/2020



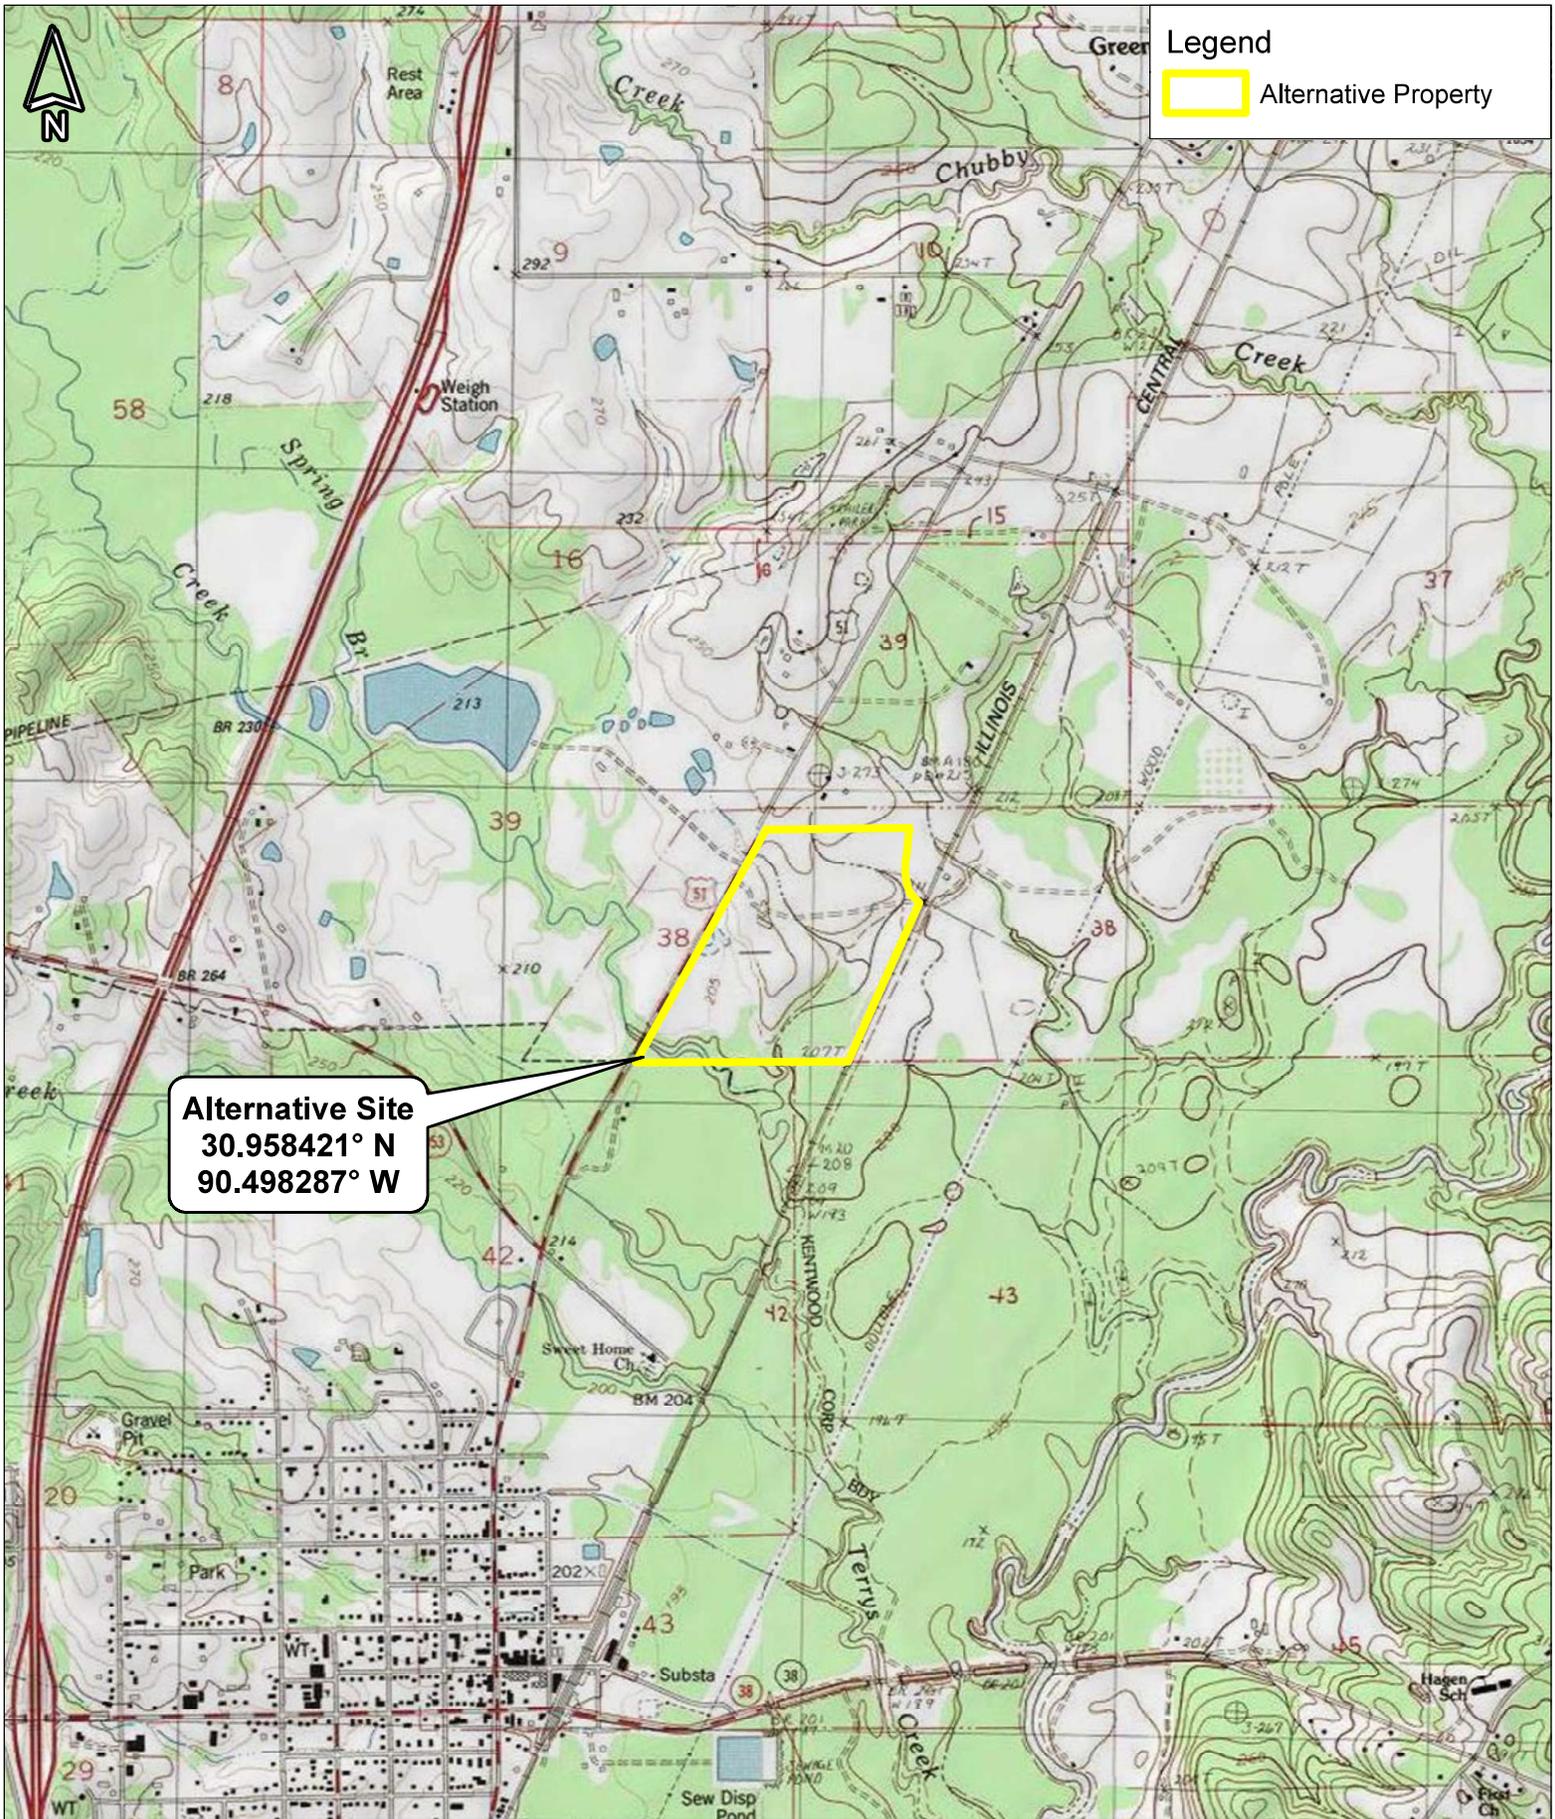

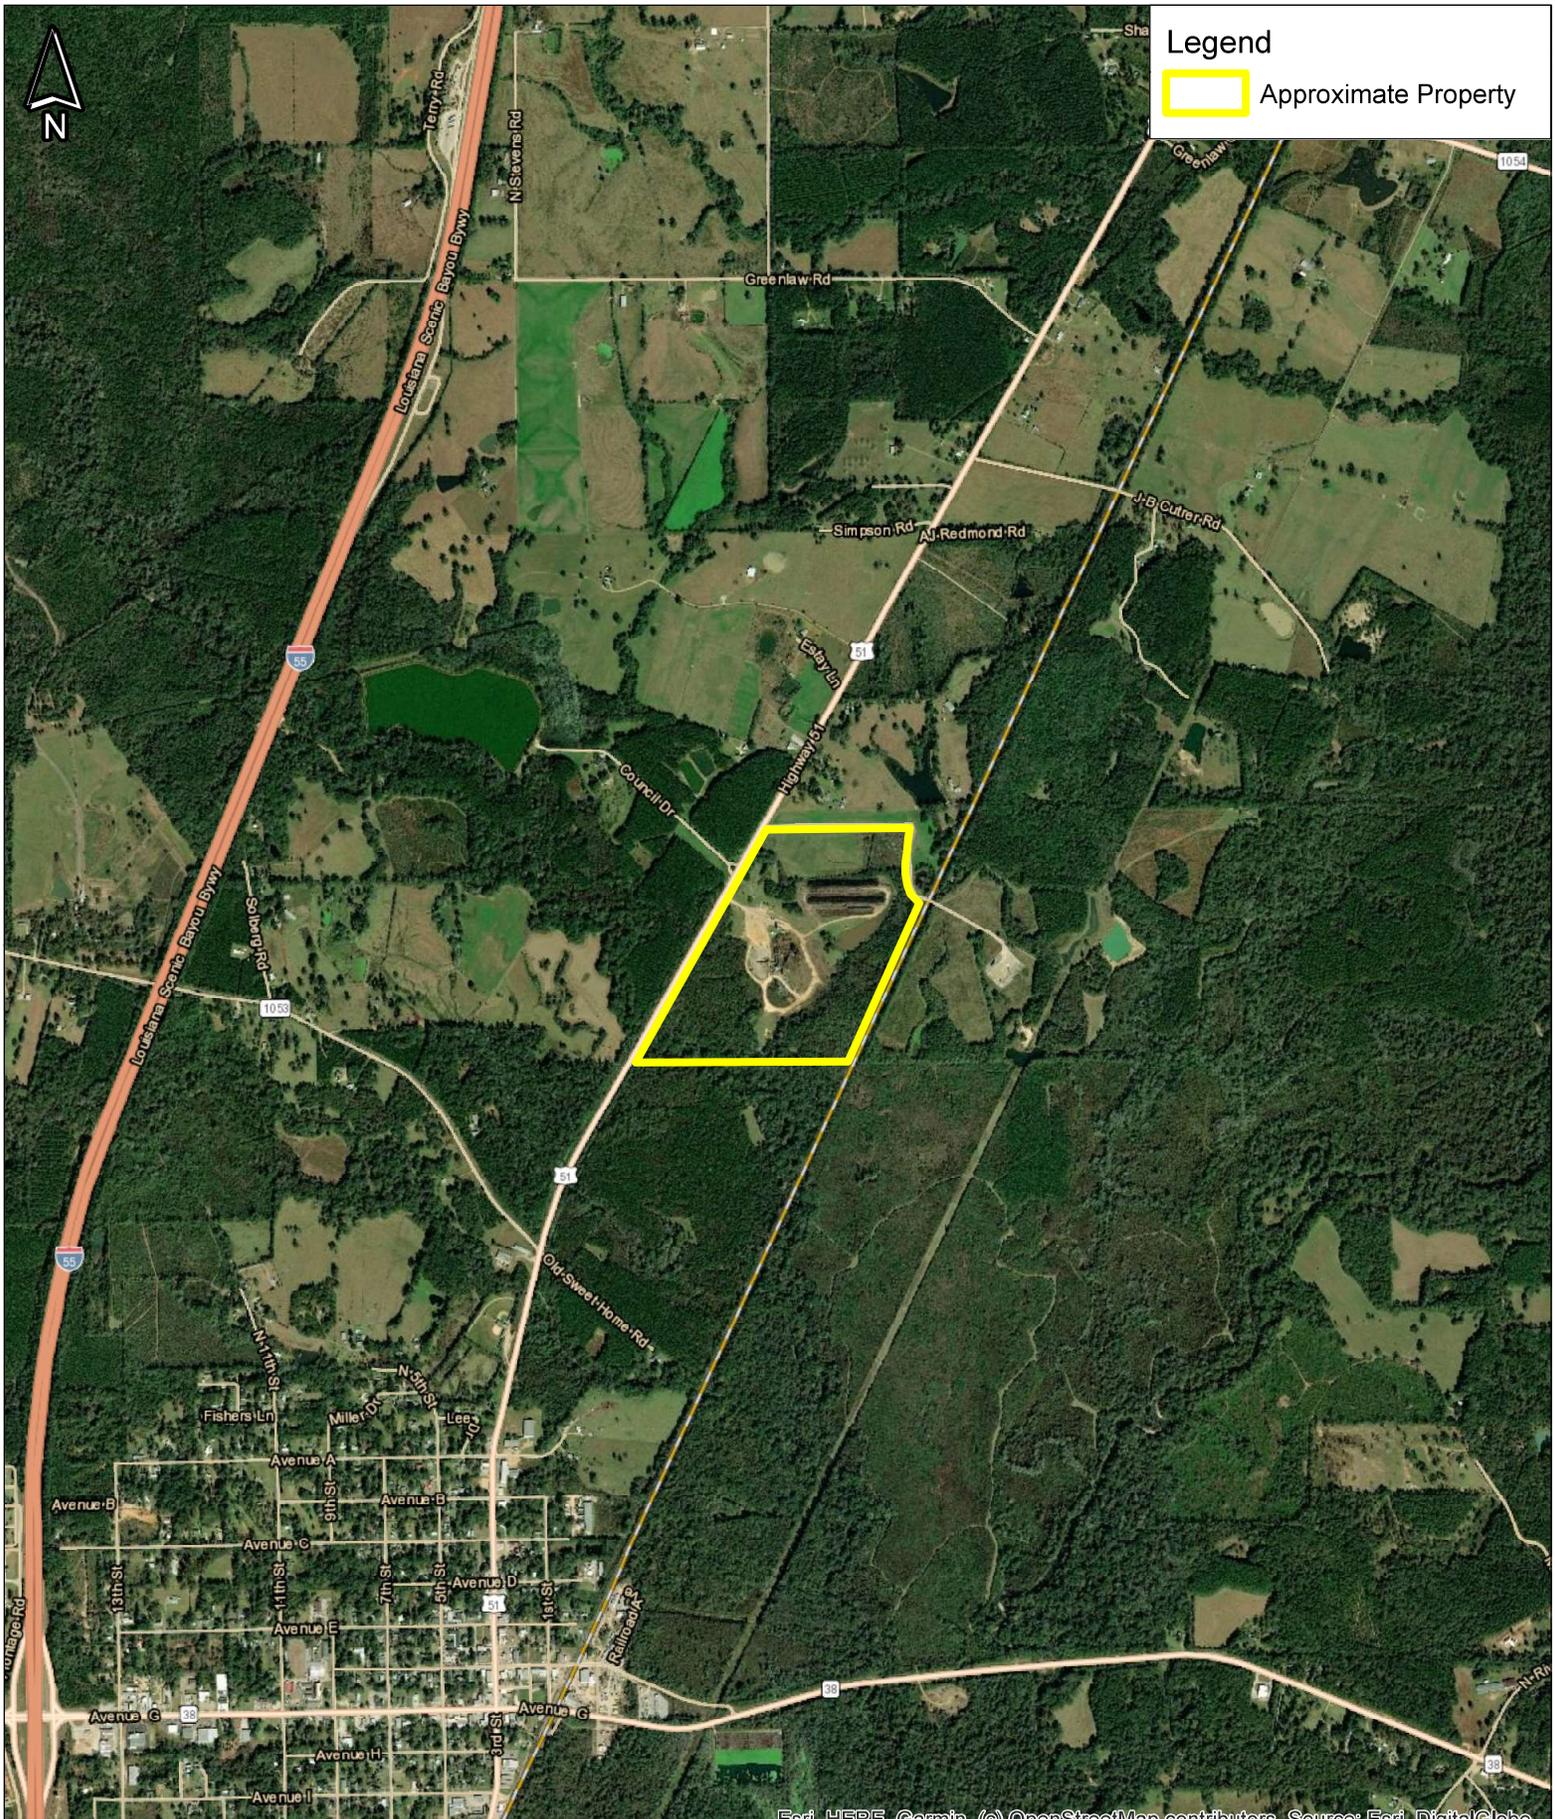
Legend
 Approximate Property



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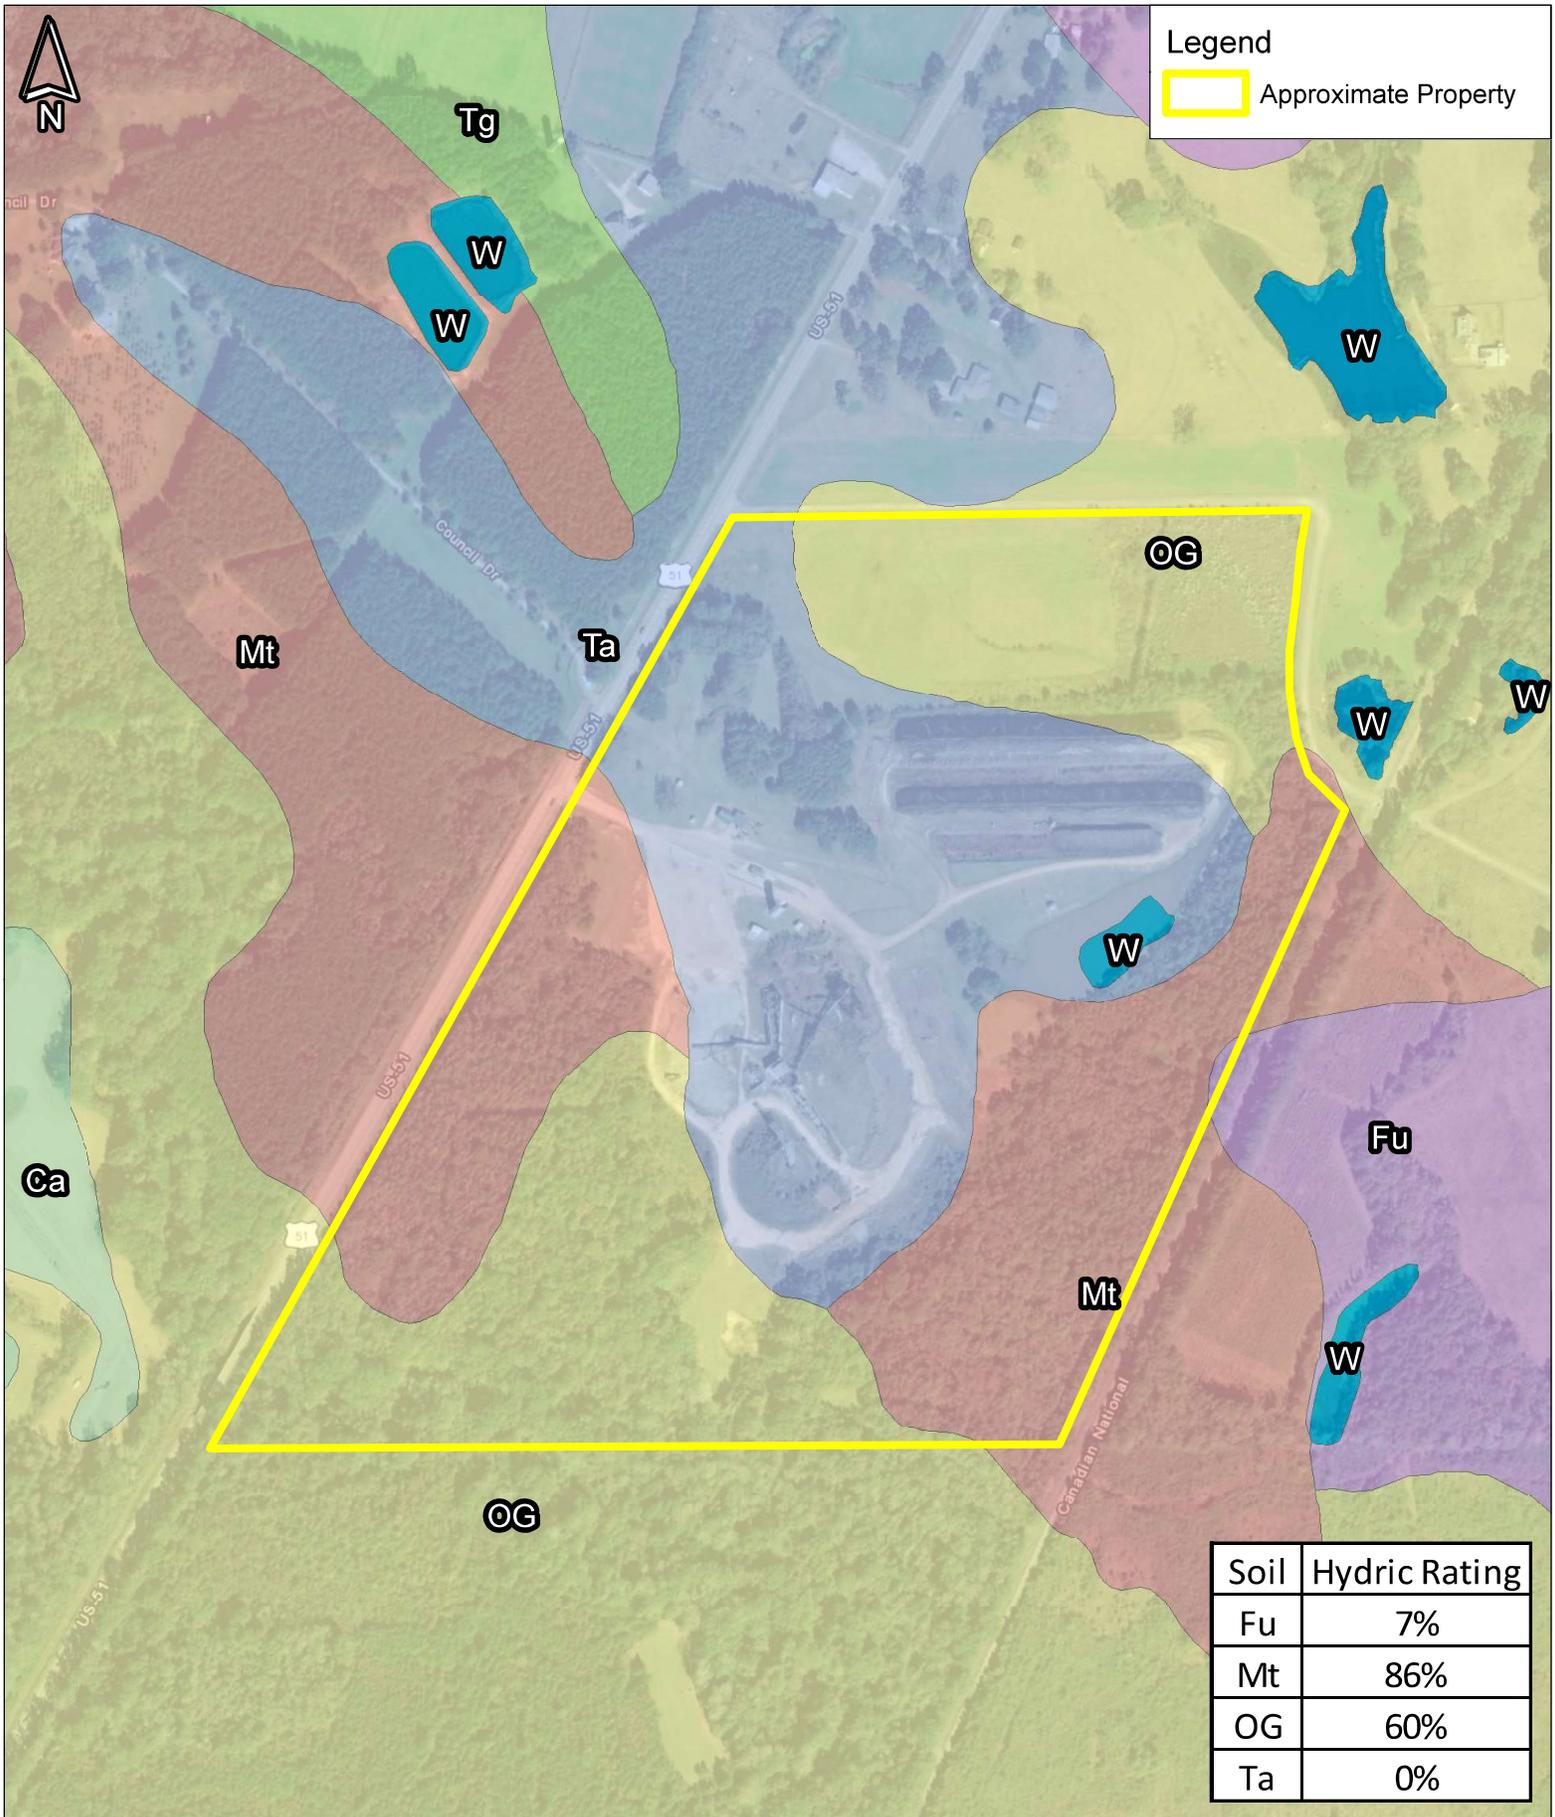
Figure No.	12
Figure Name	Vicinity Map
Purpose	Alternative Analysis
Drawn By	jsmith
Date Drawn	05/07/2020



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Figure No.	13
Figure Name	USFWS NWI Map
Purpose	Alternative Analysis
Drawn By	jsmith
Date Drawn	05/07/2020

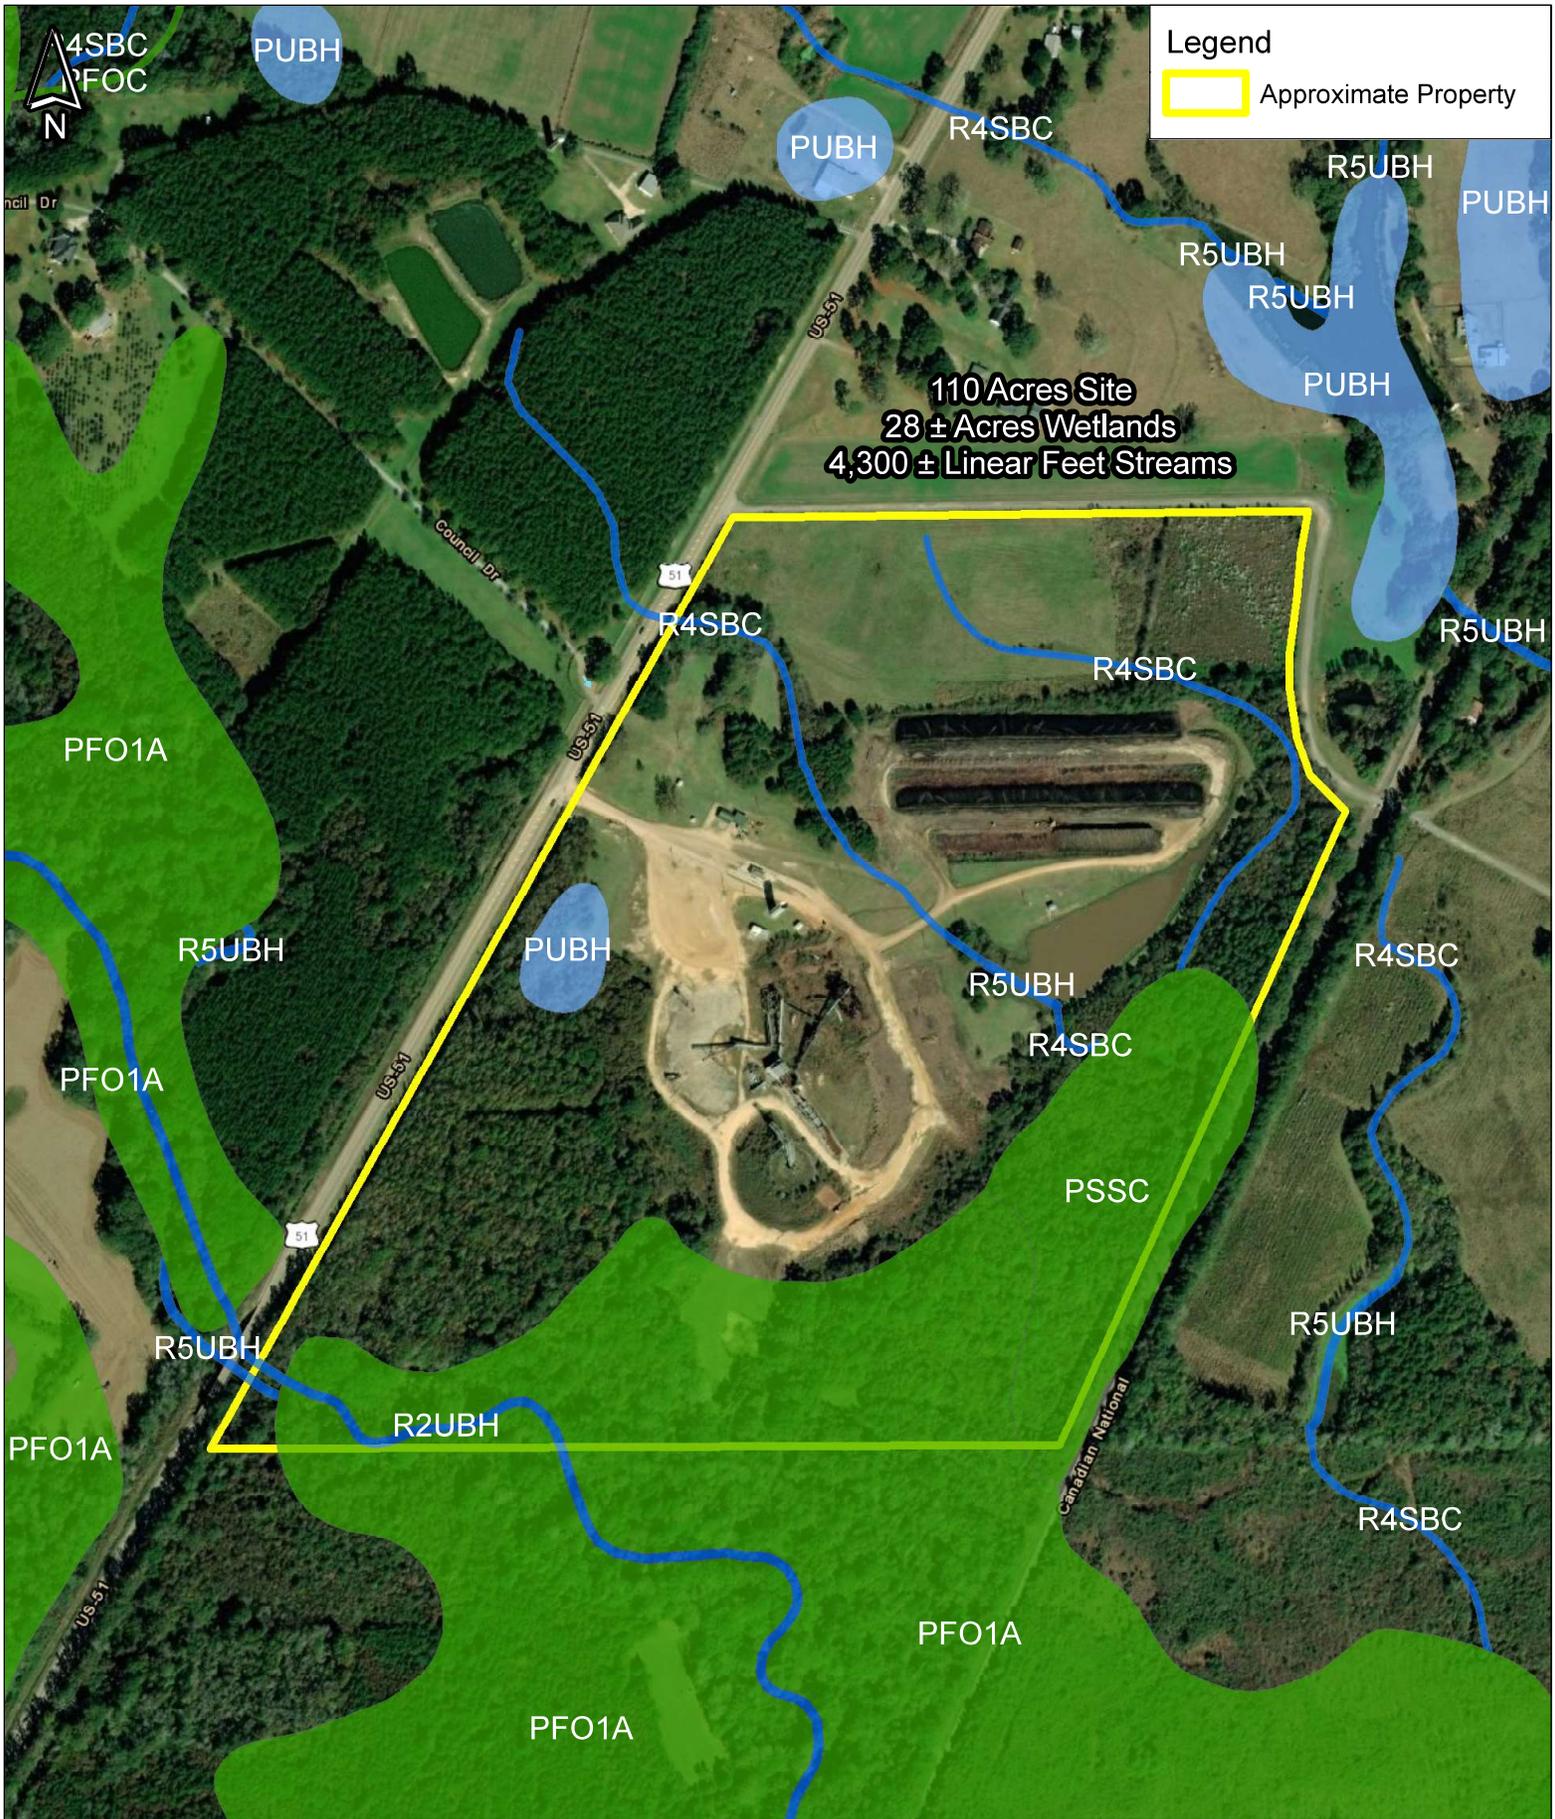



Legend

 Approximate Property

AREA OF MINIMAL FLOOD HAZARD Zone X

Council Dr

US 91

Zone A

Zone AE



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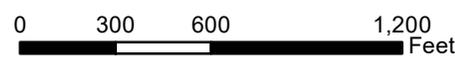
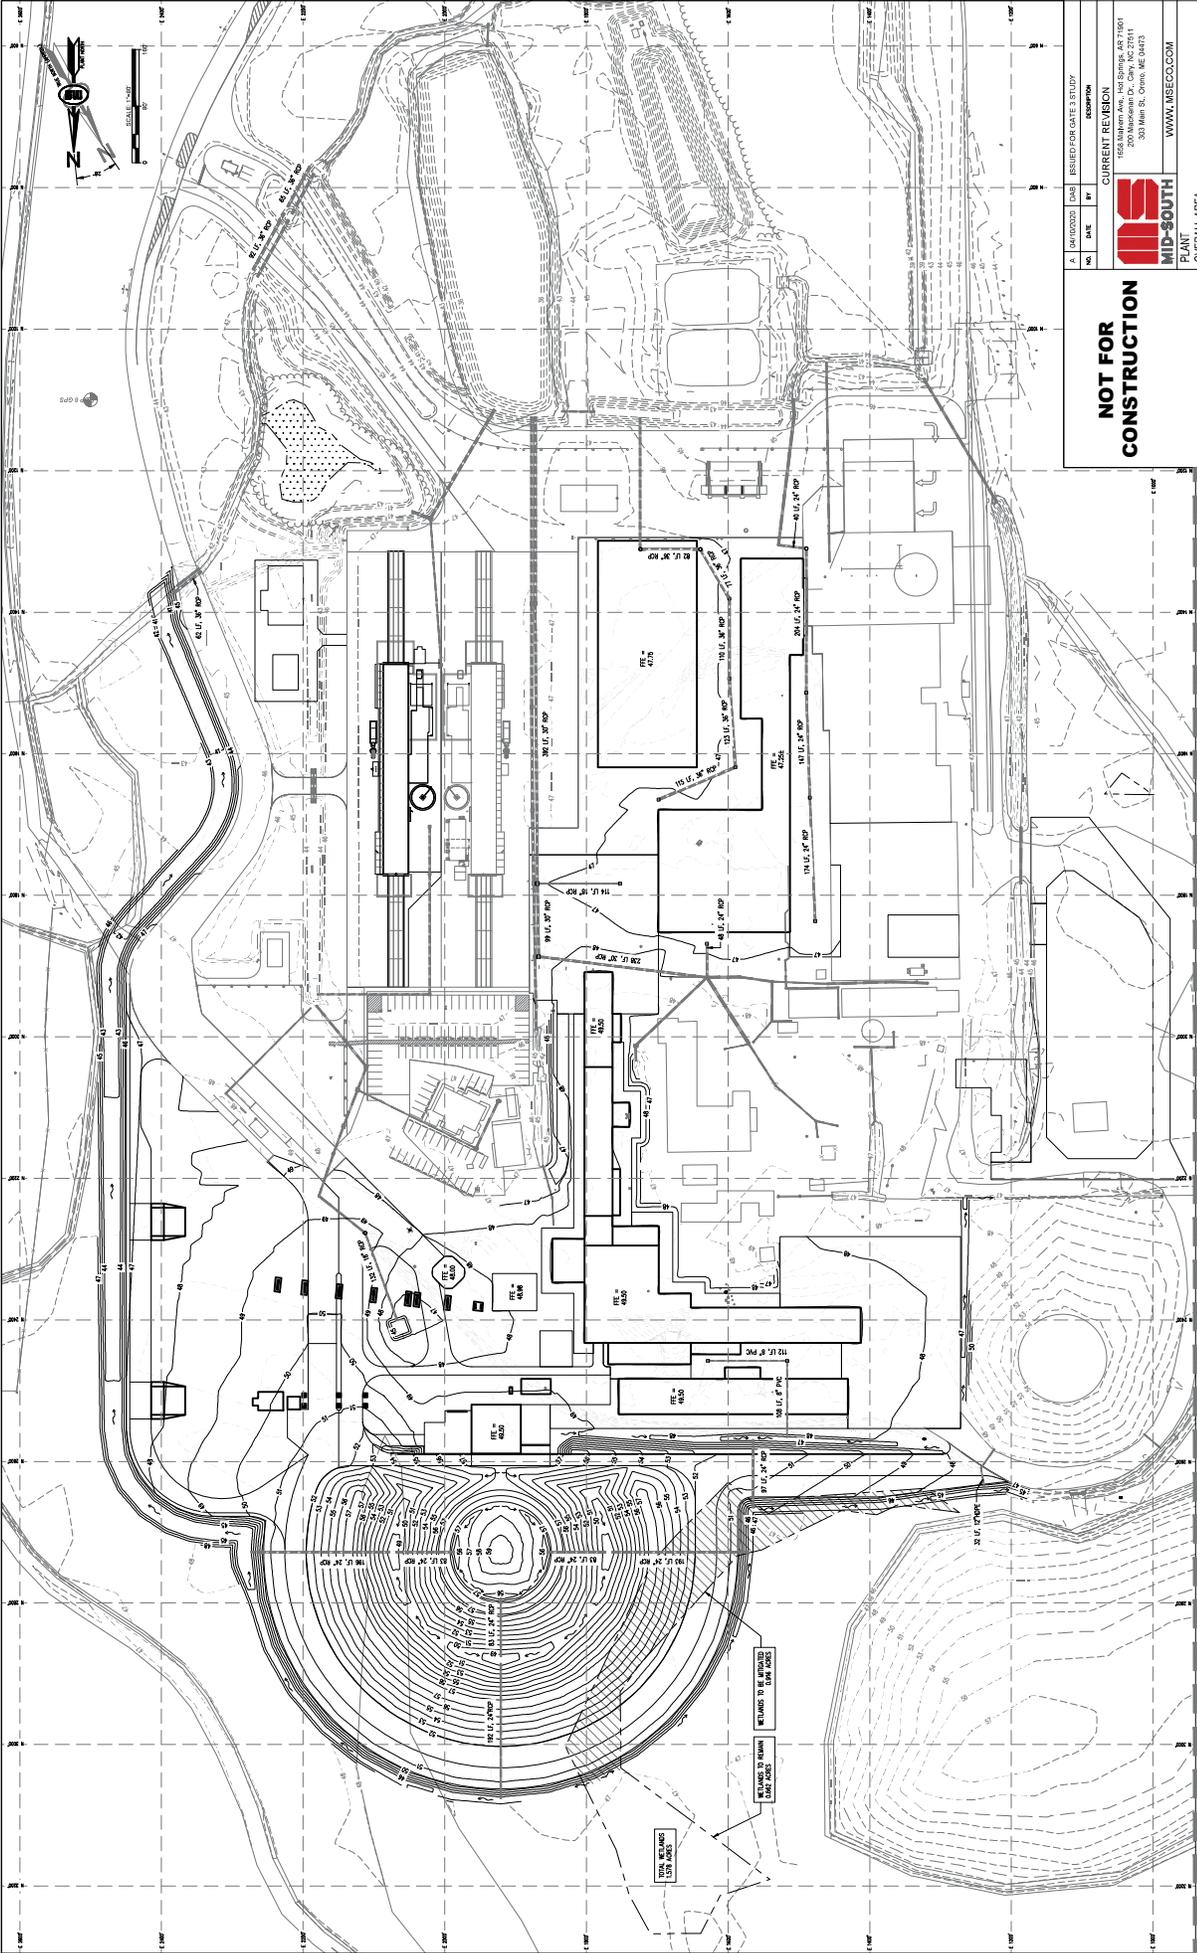


Figure No.	15
Figure Name	FEMA Flood Map
Purpose	Alternative Analysis
Drawn By	jsmith
Date Drawn	05/07/2020

Weyerhaeuser
Holden Mill Modernization Project
Request for Section 404 Permit Coverage

Appendix C: Civil Drawings



<p>NOT FOR CONSTRUCTION</p>		<p>ISSUED FOR GATE 3 STUDY</p>	
		<p>NO. DATE</p>	<p>DESCRIPTION</p>
<p>MID-SOUTH</p>		<p>15550 Main Ave., Fort Smith, AR 72501 303 Main St., Orono, ME 04473 WWW.MISECO.COM</p>	
<p>OVERALL AREA CIVIL GRADING PLAN OVERALL GRADING AND DRAINAGE PLAN (EAST)</p>		<p>WETTERHEUSER HOLDEN</p>	
<p>ISSUED FOR GATE 3 STUDY</p>		<p>7355-1000-07-CV006</p>	
<p>MID-SOUTH ENGINEERING CO. LOUISIANA REGISTRATION # 43247</p>		<p>SCALE: 1" = 80'</p>	


OVERALL GRADING AND DRAINAGE PLAN (EAST)
SCALE: 1" = 80'

RELAND TO MAINTAIN EXIST. DRAIN PATTERN

RELAND TO BE MATCHED WITH ADJACENT DRAIN PATTERN

MATCHLINE SEE SHEET 7355-1000-07-CV001

REVISIONS FOR SHEET 7385-1000-07-00001

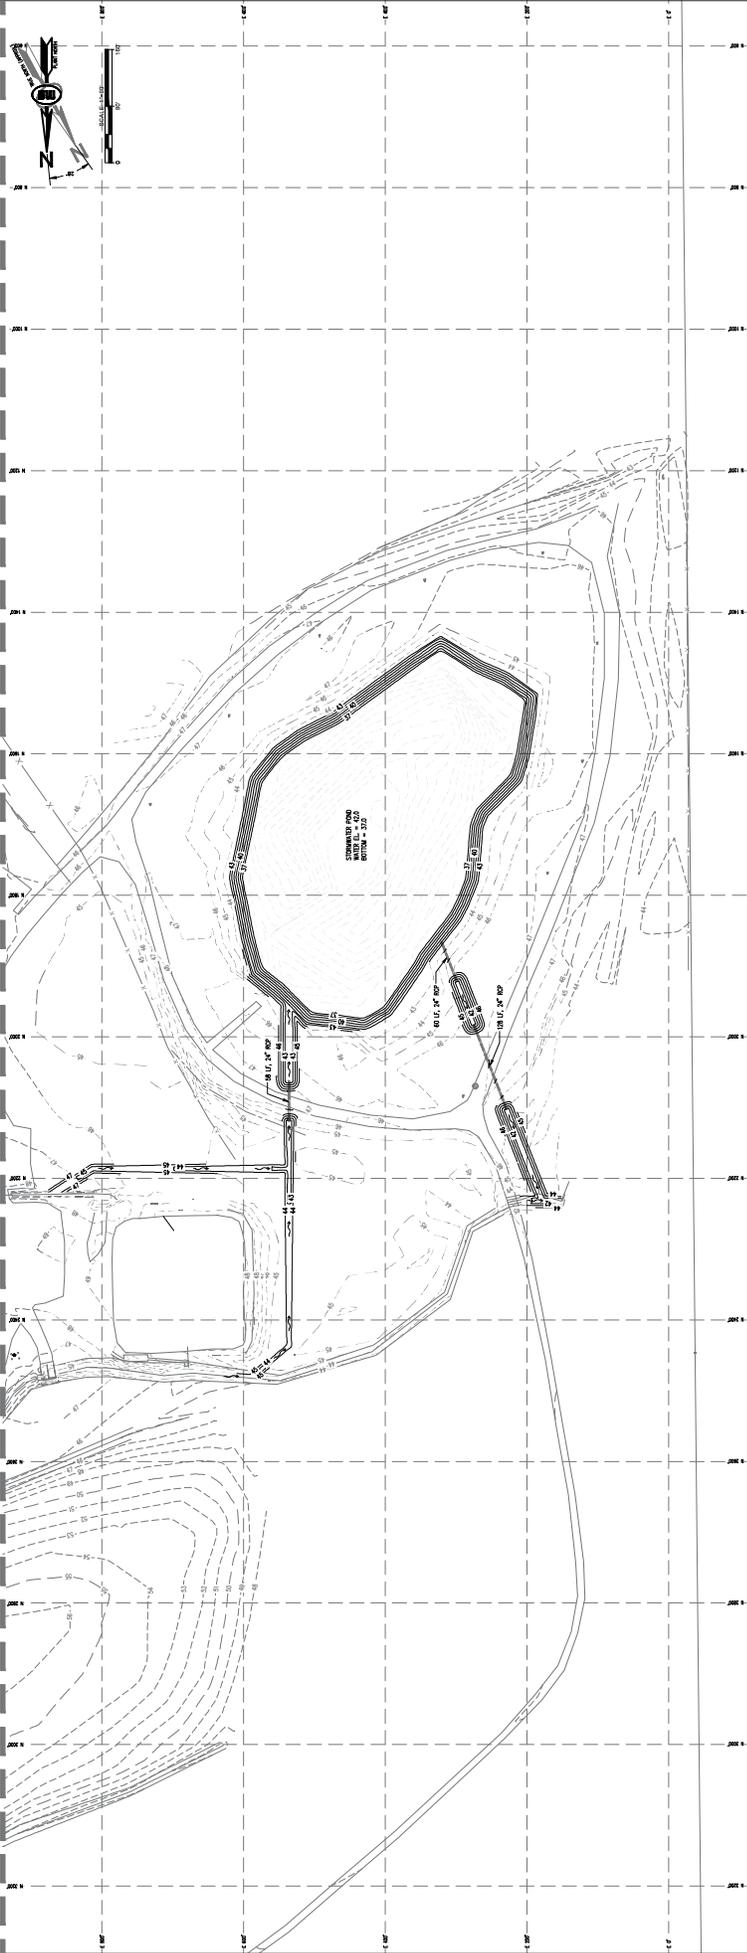

OVERALL GRADING AND DRAINAGE PLAN (WEST)
SCALE: 1" = 40'

A. SHEET NO.	DATE	ISSUED FOR GATE 3 STUDY	CURRENT REVISION	
			NO.	DESCRIPTION
<p>NOT FOR CONSTRUCTION</p>			 <p>MID-SOUTH WWW.MISECO.COM</p>	
			<p>1555 Mainway Ave., Fort Smith, AR 72501 303 Main St., Orono, ME 04473</p>	
<p>ISSUED FOR GATE 3 STUDY</p>			<p>PLANT OVERALL AREA CIVIL GRADING PLAN OVERALL GRADING AND DRAINAGE PLAN (WEST)</p>	
			<p>WETTERHEUSER HOLDEN</p>	
<p>MID-SOUTH ENGINEERING CO. LOUISIANA REGISTRATION # 42247</p>			<p>SCALE 1" = 40'</p>	<p>DATE 10/20/2007</p>
<p>7385-1000-07-CV007</p>			<p>DATE 10/20/2007</p>	<p>SCALE 1" = 40'</p>