

# JOINT PUBLIC NOTICE

December 17, 2018

United States Army  
Corps of Engineers  
New Orleans District  
Regulatory Branch, ODR-E  
Room 280  
7400 Leake Avenue  
New Orleans, Louisiana 70118

(504) 862-1564  
[Stephanie.L.Castaing@usace.army.mil](mailto:Stephanie.L.Castaing@usace.army.mil)  
Project Manager  
Stephanie Castaing  
Permit Application Number  
MVN-2017-0708-EPP

State of Louisiana  
Department of Environmental Quality  
ATTN: Water Quality Certifications

Post Office Box 4313  
Baton Rouge, Louisiana 70821-4313

(225) 219-3225

Project Manager  
Elizabeth Hill  
WQC Application Number  
WQC 181212-01

Interested parties are hereby notified that a permit application has been received by the New Orleans District of the U.S. Army Corps of Engineers pursuant to: [X] Section 10 of the Rivers and Harbors Act of March 3, 1899 (30 Stat. 1151; 33 USC 403); and/or [X] Section 404 of the Clean Water Act (86 Stat. 816; 33 USC 1344).

Application has also been made to the Louisiana Department of Environmental Quality, Water Quality Certifications, for a Water Quality Certification (WQC) in accordance with statutory authority contained in LRS30:2047 A(3), and provisions of Section 401 of the Clean Water Act (P.L.95-17).

## **PHASE 2- LONG DISTANCE SEDIMENT PIPELINE AT THE MISSISSIPPI RIVER IN JEFFERSON, PLAQUEMINES AND LAFOURCHE PARISHES.**

**NAME OF APPLICANT:** Jefferson Parish Public Works Department, c/o APTIM, Atten: Charlotte Liner, 2503 Petroleum Drive, in Houma, Louisiana 70363.

**LOCATION OF WORK:** Project site is located in Jefferson, Plaquemines, and Lafourche Parishes, within Mississippi River, between 60 to 67 miles above Head of Passes, in Louisiana, as shown on the attached drawings.

POB (Phase 2-pipeline corridor): Latitude: 29.602633 Longitude: -90.071328  
POE (Phase 2-pipeline corridor): Latitude: 29.554822 Longitude: -90.217261

Hydrologic Unit Codes: 08090100 Lower Mississippi River - New Orleans and 080900301 East Central Louisiana Coastal.

**CHARACTER OF WORK:** Dredge for sediment within the Mississippi River at the notated Alliance Anchorage and Willis Point Anchorage borrow areas in order to create a pipeline access corridor and emergent marsh. The purpose of the project is to: 1) obtain renewable sediment resources, 2) establish an adequate access corridor that supports equipment mobilization for long distance sediment conveyance, and 3) restore intertidal wetlands. Phase 2 will incorporate previously permitted borrow areas and pipeline routes (MVN-2009-1353-EFF) to deliver sediment to the new Phase 2 corridor. Phase 2 will extend the existing Phase I corridor an additional 12.6 miles.

Project implementation will require excavation and deposition of approximately 3,833,790 cubic yards of native material and the deposition of approximately 800 cubic yards of crushed stone or gravel and 696 cubic yards of rock.

The comment period for the Department of the Army Permit and the Louisiana Department of Environmental Quality WQC will close **30 days** from the date of this joint public notice. Written comments, including suggestions for modifications or objections to the proposed work, stating reasons thereof, are being solicited from anyone having interest in this permit and/or this WQC request and must be mailed so as to be received before or by the last day of the comment period. Letters concerning the Corps of Engineers permit application must reference the applicant's name and the Permit Application Number, and be mailed to the Corps of Engineers at the address above, ATTENTION: REGULATORY BRANCH.

The application for this proposed project is on file with the Louisiana Department of Environmental Quality and may be examined during weekdays between 8:00 a.m. and 4:30 p.m. Copies may be obtained upon payment of costs of reproduction.

### **Corps of Engineers Permit Criteria**

The decision whether to issue a permit will be based on an evaluation of the probable impacts, including cumulative impacts of the proposed activity on the public interest. That decision will reflect the national concern for both protection and utilization of important resources. The benefit which reasonably may be expected to accrue from the proposal must be balanced against its reasonably foreseeable detriments. All factors which may be relevant to the proposal will be considered including the cumulative effects thereof; among those are conservation, economics, aesthetics, general environmental concerns, wetlands, historic properties, fish and wildlife values, flood hazards, floodplain values, land use, navigation, shoreline erosion and accretion, recreation, water supply and conservation, water quality, energy needs, safety, food and fiber production, mineral needs, considerations of property ownership and, in general, the needs and welfare of the people.

The U.S. Army Corps of Engineers is soliciting comments from the public, federal, state, and local agencies and officials, Indian Tribes, and other interested parties in order to consider and evaluate the impacts of this proposed activity. Any comments received will be considered by the U.S. Army Corps of Engineers to determine whether to make, modify, condition, or deny a permit for this proposal. To make this decision, comments are used to assess impacts on endangered species, historic properties, water quality, general environmental effects, and other public interest factors listed above. Comments are used in the preparation of an Environmental Assessment and/or an Environmental Impact Statement pursuant to the National Environmental Policy Act. Comments are also used to determine the need for a public hearing and to determine the overall public interest of the proposed activity.

The New Orleans District is unaware of properties listed on the National Register of Historic Places near the proposed work. The possibility exists that the proposed work may damage or destroy presently unknown archeological, scientific, prehistorical, historical sites, or data. Issuance of this public notice solicits input from the State Archeologist and State Historic Preservation Officer regarding potential impacts to cultural resources.

The New Orleans District has determined that the proposed project is Not likely to Adversely Affect the endangered Pallid Sturgeon (*Scaphirhynchus albus*) and the West Indian Manatee (*Trichechus manatus*), based on the Standard Local Operating Procedure for Endangered Species of Louisiana (SLOPES), dated October 22, 2014, between the U.S. Army Corps of Engineers and U.S. Fish and Wildlife Service, Ecological Services Office.

Our initial finding is that the proposed work would not affect any species, nor affect any habitat designated as critical to the survival and recovery of such species, listed as endangered by the U.S. Department of Commerce.

This notice initiates the Essential Fish Habitat (EFH) consultation requirements of the Magnuson-Stevens Fishery Conservation and Management Act. The applicant's proposal would result in the destruction or alteration of **700.0** acres of EFH utilized by various life stages of red drum and penaeid shrimp. Our initial determination is that the proposed action would not have a substantial adverse impact on EFH or federally managed fisheries in the Gulf of Mexico. Our final determination relative to project impacts and the need for mitigation measures is subject to review by and coordination with the National Marine Fisheries Service.

If the proposed work involves deposits of dredged or fill material into navigable waters, the evaluation of the probable impacts will include the application of guidelines established by the Administrator of the Environmental Protection Agency. Also, a certification that the proposed activity will not violate applicable water quality standards will be required from the Department of Environmental Quality, Water Quality Certifications, before a permit is issued.

Any person may request, in writing, within the comment period specified in this notice, that a public hearing be held to consider this application. Requests for public hearings shall state, with particularity, the reasons for holding a public hearing.

The applicant has certified that the proposed activity described in the application complies with and will be conducted in a manner that is consistent with the Louisiana Coastal Resources Program. The Department of the Army permit will not be issued unless the applicant received approval or a waiver of the Coastal Use Permit by the Department of Natural Resources.

You are requested to communicate the information contained in this notice to any other parties whom you deem likely to have interest in the matter.

Michael V. Farabee  
Chief, Eastern Evaluation Section

Enclosure

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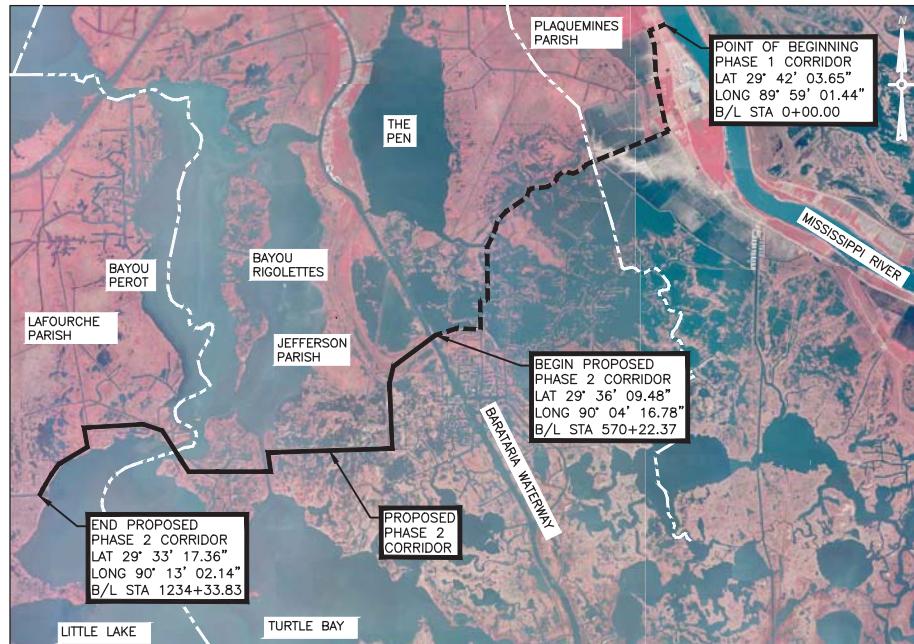
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FOR PERMITTING ONLY - NOT FOR CONSTRUCTION


THIS DRAWING SET IS FOR PERMITTING PURPOSES  
ONLY AND NOT TO BE USED FOR CONSTRUCTION

DATE: MAY 2017  
MARCH 2018 (REVISED)  
JULY 2018 (REVISED)

# JEFFERSON PARISH DEPARTMENT OF ENVIRONMENTAL AFFAIRS MISSISSIPPI RIVER LONG DISTANCE SEDIMENT PIPELINE WEST OF BARATARIA WATERWAY (PHASE 2 - CORRIDOR) JEFFERSON, PLAQUEMINES, & LAFOURCHE PARISH



LOCATION MAP

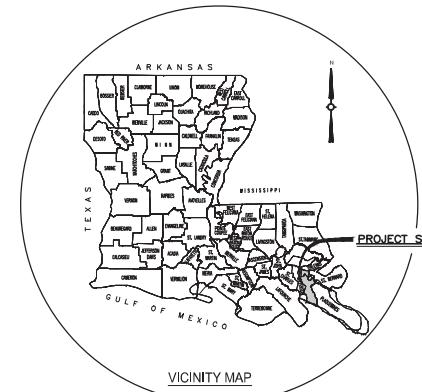

PHASE 1  
PREVIOUS PERMITS  
CUP NO. P20111445  
COE NO. MVN-2009-1353



DESIGNED	SCALE	CHECKED	DETAILED	DATE	TIME	PERMIT PLANS RE-ISSUED	NO. DATE	REVISION DESCRIPTION	B/L
						▲ 07/25/18	▲ 03/16/18		

APTIM

THE METairie CENTRE  
SUITE 450  
2401 GENEBRORNE AVE.  
METairie, LA 70001 504.832.4878



APTIM

Long Distance Sediment Pipeline  
West of Barataria Waterway

Title Sheet

Project No.


153455

Date

MAY 2017

Sheet No.

001

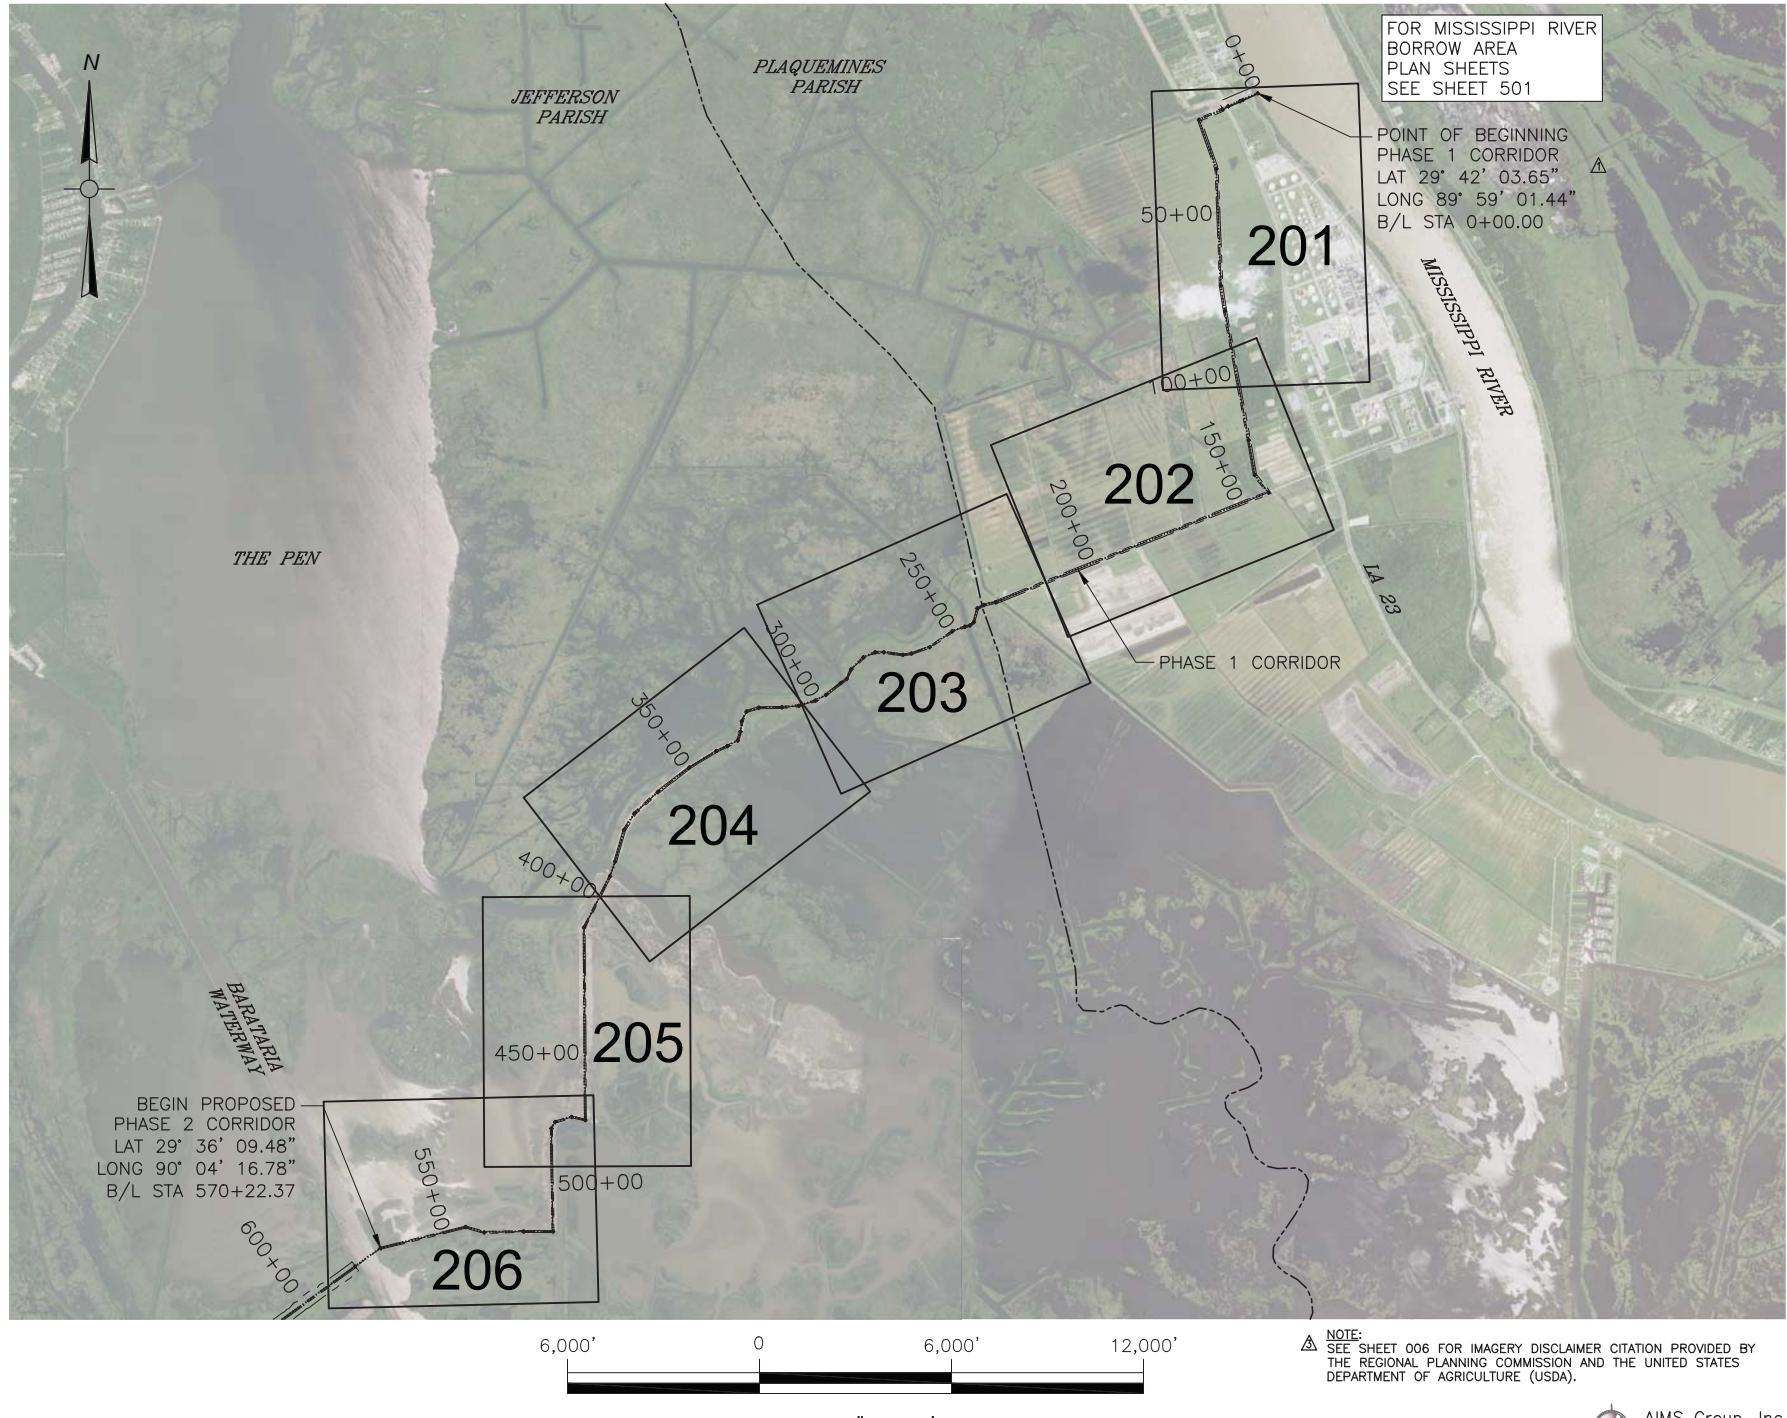

SPL  
SPL  
SPL  
SPL

03/15/18 CITATION NOTE REVISION  
03/15/18 PERMIT PLANS RE-ISSUED  
03/15/18 ADDED POINT OF BEGINNING  
NO. DATE REVISION DESCRIPTION

B/L



07/25/18

DATE TIME

APTIM  
THE METAIRIE CENTRE  
2024 LEDGERBORG AVE.  
SUITE 450  
METAIRIE, LA 70001 504.832.4878




PROJECT NO.  
153455

DATE  
MAY 2017

SHEET NO.  
002



Ph. 504.887.7045  
Fax. 504.887.7088

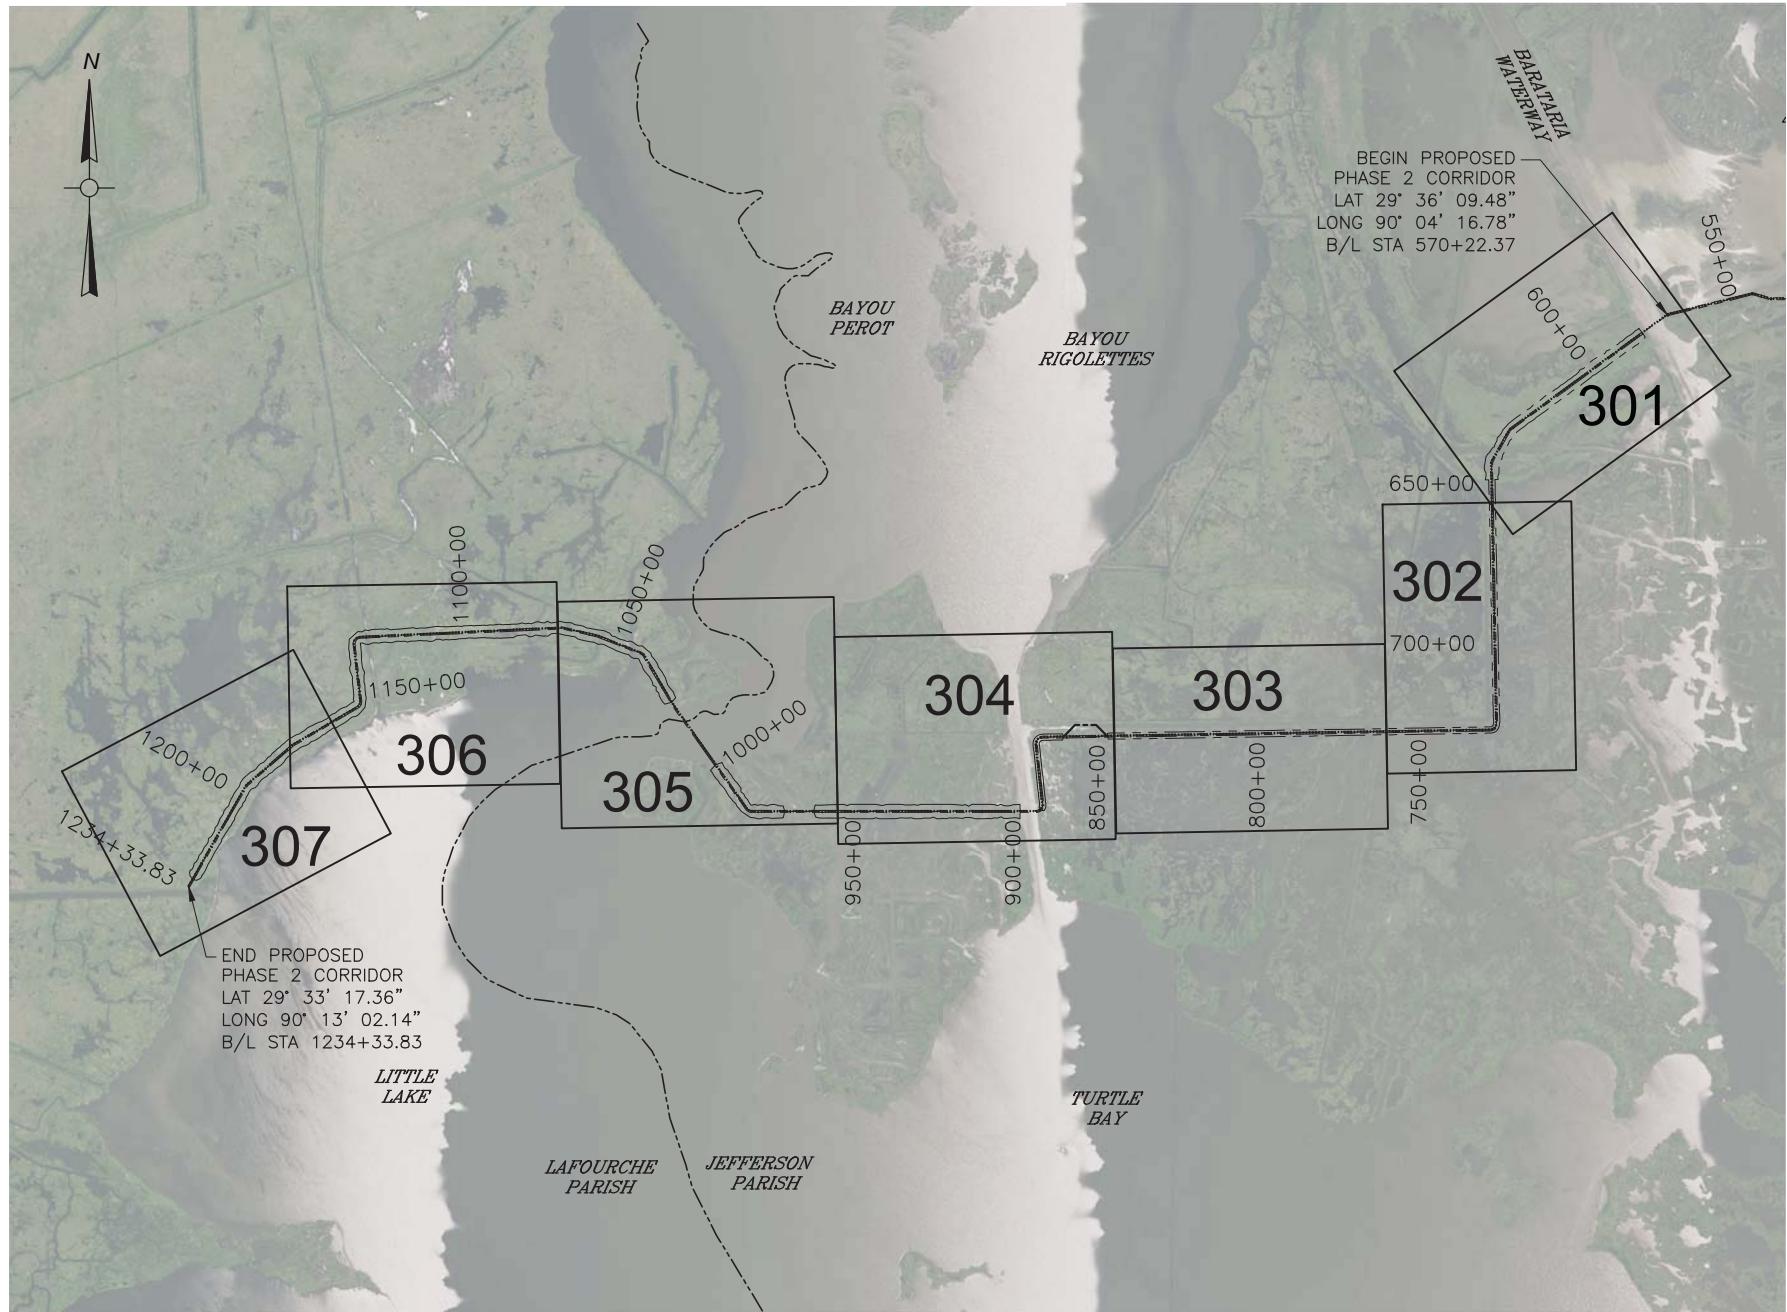

**NOTE:**  
SEE SHEET 006 FOR IMAGERY DISCLAIMER CITATION PROVIDED BY  
THE REGIONAL PLANNING COMMISSION AND THE UNITED STATES  
DEPARTMENT OF AGRICULTURE (USDA).



**GENERAL NOTES:**

1. BACKGROUND AERIAL IMAGES FROM THE REGIONAL PLANNING COMMISSION FOR JEFFERSON, ORLEANS, PLAQUEMINES, ST. BERNARD, ST. TAMMANY AND TANGIPAHOA PARISHES (RPC) AND THE UNITED STATES DEPARTMENT OF AGRICULTURE (USDA).
2. COORDINATES ARE NAVD83, LOUISIANA STATE PLANE, SOUTHERN ZONE, U.S. SURVEY FEET.
3. ALL ELEVATIONS ARE IN NORTH AMERICAN VERTICAL DATUM OF 1988 (NAVD88), U.S. SURVEY FEET.
4. THE RIVER DATUMS SHOWN BASED ON HISTORIC DATA FOR MISSISSIPPI RIVER AT ALLIANCE (01390) RIVER MILE 62.5. RECORDS AVAILABLE FROM APRIL 2, 1977 TO DATE.
5. THE CONTRACTOR SHALL NOT EXCAVATE WITHIN 500' OF ANY PIPELINE IN THE MISSISSIPPI RIVER OR WITHIN 50' OF ANY OTHER PIPELINE EXCEPT FOR NAOMI SIPHON PIPES.
6. NO EXCAVATION SHALL BE PERMITTED WITHIN 25' OF THE NAOMI SIPHON PIPES. THE EDGE OF THE DREDGE SLURRY PIPELINE SHALL BE PLACED A MINIMUM OF 25' OF THE EDGE OF THE NAOMI SIPHON PIPES.
7. THE CONTRACTOR SHALL BE RESPONSIBLE FOR NOTIFYING PIPELINE AND UTILITY OPERATORS AT THE TIME OF CONSTRUCTION. ALL PIPELINES AND UNDERGROUND UTILITIES SHALL BE FIELD LOCATED AND MARKED.
8. THE CONTRACTOR SHALL BE RESPONSIBLE FOR NOTIFYING PIPELINE AND UTILITY OPERATORS 72 HOURS PRIOR TO ANY EXCAVATION.
9. NO CONSTRUCTION EQUIPMENT OR ACTIVITIES MAY OPERATE, TRANSIT, STAGE OR STORE OUTSIDE OF THE CONSTRUCTION LIMITS.
10. THIS DRAWING SET IS FOR PERMITTING PURPOSES ONLY AND IS NOT TO BE USED FOR CONSTRUCTION.
11. ESTIMATED RANGE OF FULLY-LOADED DRAFTS FOR VESSELS TO BE USED DURING CONSTRUCTION:
 

a. 4,000 HP TUGS .....	15-20 FT
b. 2,000 HP TUGS .....	10-14 FT
c. WORK BOATS, TENDERS .....	6-8 FT
d. CREW BOATS .....	2-4 FT
e. BOOSTER PUMP BARGES, WORK BARGES, FUEL BARGES .....	4-6 FT
f. SMALL BARGE-MOUNTED CLAMSHELL OR EXCAVATOR .....	4-6 FT
g. LARGE HYDRAULIC DREDGE .....	10 FT
12. REFER TO SHEET 507 FOR CORRIDOR ALIGNMENT TABLES.

**DREDGING NOTES:**

1. THE CONTRACTOR WILL BE REQUIRED TO ANCHOR WITHIN THE DREDGE ANCHOR LIMITS SHOWN IN SHEETS 503 AND 504.
2. DREDGE ANCHOR LIMITS SHALL BE MARKED WITH BUOYS AS SHOWN IN SHEETS 503 AND 504.
3. DREDGING BEYOND THE BORROW AREA LIMITS SHOWN WILL NOT BE ALLOWED.
4. DREDGING WILL BE ALLOWED TO A MAXIMUM DEPTH OF -90 FT NAVD88.
5. THE CONTRACTOR WILL BE REQUIRED TO SUBMIT A DAILY COMMUNICATION PLAN TO THE OWNER, THE USACE OPERATIONS DIVISION, AND MNSA DELINEATING THE LOCATION OF THE DREDGE, ATTENDANT PLANT, ANCHOR BUOYS, AND FLOATING PIPELINE AS PER THE OWNER SPECIFICATIONS.

CANAL CROSSINGS			
STA. 575+00	BAYOU BARATARIA WATERWAY	TEMPORARY CROSSING	BURIED PIPE
STA. 638+00	CANAL NO. 1	PERMANENT CROSSING	FILL
STA. 762+50	CANAL NO. 3	PERMANENT CROSSING	FILL
STA. 855+00	LITTLE LAKE CLUB CANAL	TEMPORARY CROSSING	BURIED PIPE
STA. 895+50	HARVEY CUT	TEMPORARY CROSSING	BURIED PIPE
STA. 967+00	CANAL NO. 4	TEMPORARY CROSSING	BURIED PIPE
STA. 1015+00	BAYOU PEROT	TEMPORARY CROSSING	BURIED PIPE
STA. 1037+50	CANAL NO. 5	PERMANENT CROSSING	FILL
STA. 1045+00	CANAL NO. 6	PERMANENT CROSSING	FILL
STA. 1056+00	CANAL NO. 8	PERMANENT CROSSING	FILL
STA. 1078+00	UNNAMED CANAL	PERMANENT CROSSING	FILL
STA. 1130+00	CANAL NO. 8	PERMANENT CROSSING	FILL

ABBREVIATIONS			
* UNLESS OTHERWISE NOTED ON EACH SHEET			
A/E	ARCHITECT OR ENGINEER	ID	INSIDE DIAMETER
ALT.	ALTERNATE	LS	LUMP SUM
APPROX	APPROXIMATE	L.S.	LIFT STATION
ASPH.	ASPHALT	MISC	MISCELLANEOUS
Avg.	AVERAGE	MH	MANHOLE
AZ	AZIMUTH	M.S.L.	MEAN SEA LEVEL
B/L	BASELINE	N.T.S.	NOT TO SCALE
BLDG.	BUILDING	N/A	NOT APPLICABLE
BM	BENCH MARK	NO	NUMBER
BRG.A.	BEARING	OF	OUTSIDE FACE
CB	CATCH BASIN	OC	ON CENTER
C/L	CENTERLINE	OD	OUTSIDE DIAMETER
CMP	CORRUGATED METAL PIPE	OHL	OVERHEAD LINE
CONC	CONCRETE	PC	POINT OF CURVATURE
CFS	CUBIC FEET PER SECOND	P.I.	POINT OF INFLECTION
DTL.	DETAIL	P/S	PROTECTED SIDE
DI	DUCTILE IRON	P/L	Pipeline
DIA	DIAMETER	PL	Pipeline
DIST	DISTANCE	RR	Railroad
DWG	DRAWING	R/W	RIGHT OF WAY
EL	ELEVATION	S/P	SHEET PILE
EJ	EXPANSION JOINT	SPEC	SPECIFICATIONS
EX	EXISTING	STA	STATION
EXIST	EXISTING	SUB	SUBMERGED
FT	FEET	T&B	TOP AND BOTTOM
FH	FIRE HYDRANT	TYP	TYPICAL
F/S	FLOOD SIDE	UGND	UNDERGROUND
FM	FORCE MAIN	V	VERTICAL
HT	HEIGHT	WL	WATER LINE
H	HORIZONTAL	WM	WATER MAIN
HP	HORSEPOWER	WV	WATER VALVE


PERMITTING NOTES			
PHASE 1 WAS CONSTRUCTED UNDER PERMITS CUP NO. P20111445 USACE NO. MVN-2009-1353			
DESIGNED	SCALE	DATE	TIME
CHECKED	DETAILED	03/16/18	PERMIT PLANS RE-ISSUED
DETAILED	CHECKED	DATE	TIME
APTIM	THE METairie CENTRE 2024 LEDGERBORG AVE. SUITE 460 METairie, LA 70001 504.832.4878	NO. DATE	REVISION DESCRIPTION

UTILITY CROSSINGS			
PHASE 1 CORRIDOR		PROPOSED PHASE 2 CORRIDOR	
①	ENTERGY OVERHEAD LINE	⑨	16" JP WATERLINE
②	6" PHILLIPS 66 PIPELINE	⑩	8" CHEVRON PIPELINE
③	8" PHILLIPS 66 PIPELINE	⑪	6" CASTEX ENERGY FLOW LINE
④	ENTERGY TRANSMISSION LINE	⑫	24" PLAINS PIPELINE
⑤	PLAINS PIPELINE	⑬	GULF PIPE LINE COMPANY
⑥	PLAINS PIPELINE	⑭	BP OIL PIPE LINE COMPANY
⑦	20" SHELL PIPELINE	⑮	EXXON PIPELINE
⑧	18" BP PIPELINE	⑯	2.5" EXXON FLOW LINE
		⑰	BADGER OIL CORP. PIPELINE
		⑱	BADGER OIL CORP. PIPELINE
		⑲	2-16" EXXONMOBIL PIPELINES
GENERAL NOTES			
LONG DISTANCE SEDIMENT PIPELINE WEST OF BARATARIA WATERWAY			
PROJECT NO.	153455	DATE	MAY 2017
SHEET NO.	004	Ph. 504.887.7045	Fax. 504.887.7088
AIMS Group, Inc.	Consulting Engineers	4421 Zenith Street Metairie, LA 70001	

GENERAL CROSS-REFERENCING SYMBOLS	
DETAIL/SECTION SUPPLEMENTAL INFORMATION SCALE:	A SECTION/DETAIL TITLE ON SAME DRAWING (CENTERED UNDER SECTION/DETAIL)
DETAIL/SECTION SCALE: 2 3	A SECTION/DETAIL TITLE ON ANOTHER DRAWING (CENTERED UNDER SECTION/DETAIL)
TOP      FRONT      SIDE ELEVATION    SECTION	A VIEW SUBTITLE/ (CENTERED UNDER EACH VIEW)
A SECTION CUT W/ VIEW SHOWN ON SAME DRAWING	A SECTION CUT W/ VIEW SHOWN ON ANOTHER DRAWING
A DETAIL SYMBOL W/ VIEW SHOWN ON SAME DRAWING	A DETAIL SYMBOL W/ VIEW SHOWN ON ANOTHER DRAWING
HATCHING	
CONCRETE	REMOVE/DEMO
ASPHALT	RIPRAP
EXISTING GROUND	GRANULAR MATERIAL
EMBANKMENT	
EXCAVATION	
SAND	
CLAY	

LINE TYPES	
SLOPE	RIGHT OF WAY
RIGHT OF WAY	LIMITS OF FILL
LIMITS OF FILL	BASELINE
BASELINE	CENTERLINE
CENTERLINE	NEW CONSTRUCTION
NEW CONSTRUCTION	EXISTING GROUND
EXISTING GROUND	SILT FENCE
SILT FENCE	EASEMENT LINE
EASEMENT LINE	HAUL ROUTE
HAUL ROUTE	CONSTRUCTION STAGING AREA
CONSTRUCTION STAGING AREA	EXISTING FENCE
EXISTING FENCE	LIMITS OF CONSTRUCTION
LIMITS OF CONSTRUCTION	CATCH BASIN
CATCH BASIN	DROP INLET, DRAIN LINE
DROP INLET, DRAIN LINE	COMMUNICATIONS MANHOLE/LINE
COMMUNICATIONS MANHOLE/LINE	DRAIN MANHOLE, DRAIN LINE
DRAIN MANHOLE, DRAIN LINE	ELECTRICAL MANHOLE, ELEC. LINE
ELECTRICAL MANHOLE, ELEC. LINE	GAS MANHOLE, GAS LINE
GAS MANHOLE, GAS LINE	OVERHEAD LINE
OVERHEAD LINE	Pipeline
Pipeline	RAILROAD
RAILROAD	SEWER MANHOLE, SEWER LINE
SEWER MANHOLE, SEWER LINE	SUBMERGED PIPELINE
SUBMERGED PIPELINE	TELEPHONE MANHOLE, TELE LINE
TELEPHONE MANHOLE, TELE LINE	TRAFFIC MANHOLE, TRAFFIC LINE
TRAFFIC MANHOLE, TRAFFIC LINE	WATER LINE
WATER LINE	WATER MANHOLE, WATER LINE
WATER MANHOLE, WATER LINE	UTILITY POLE / OVERHEAD LINES
SYMBOLS	
□	UTILITY BOX
○○○	UTILITY CLEANOUT
○○○	UTILITY METER
□	UTILITY PEDESTAL
●○○	UTILITY VALVE
○○○	FIRE HYDRANT
○○○	LIGHT STANDARD
▽	TRAFFIC SIGNAL POLE
○○○	TRAFFIC LIGHT POWER VAULT
○○○	CANOPY SUPPORT
○○○	SIGN
○○○	TREE
○○○	RESIDENTIAL MAILBOX
○○○	PP DEADMAN
○○○	BUILDING

DESIGNED	SCALE
CHECKED	DATE
DETAILED	TIME
CHECKED	PERMIT PLANS RE-ISSUED
NO. DATE	REVISION DESCRIPTION
APTIM	03/16/18
THE METairie CENTRE	SP1
SUITE 450	BY
METairie, LA 70001 504.832.4878	
LONG DISTANCE SEDIMENT PIPELINE	
WEST OF BARATARIA WATERWAY	
LEGEND	
PROJECT NO.	153455
DATE	MAY 2017
SHEET NO.	005
AIMS Group, Inc.	
Consulting Engineers	
4421 Zenith Street	
Metairie, LA 70001	
Ph. 504.887.7045	
Fax. 504.887.7088	

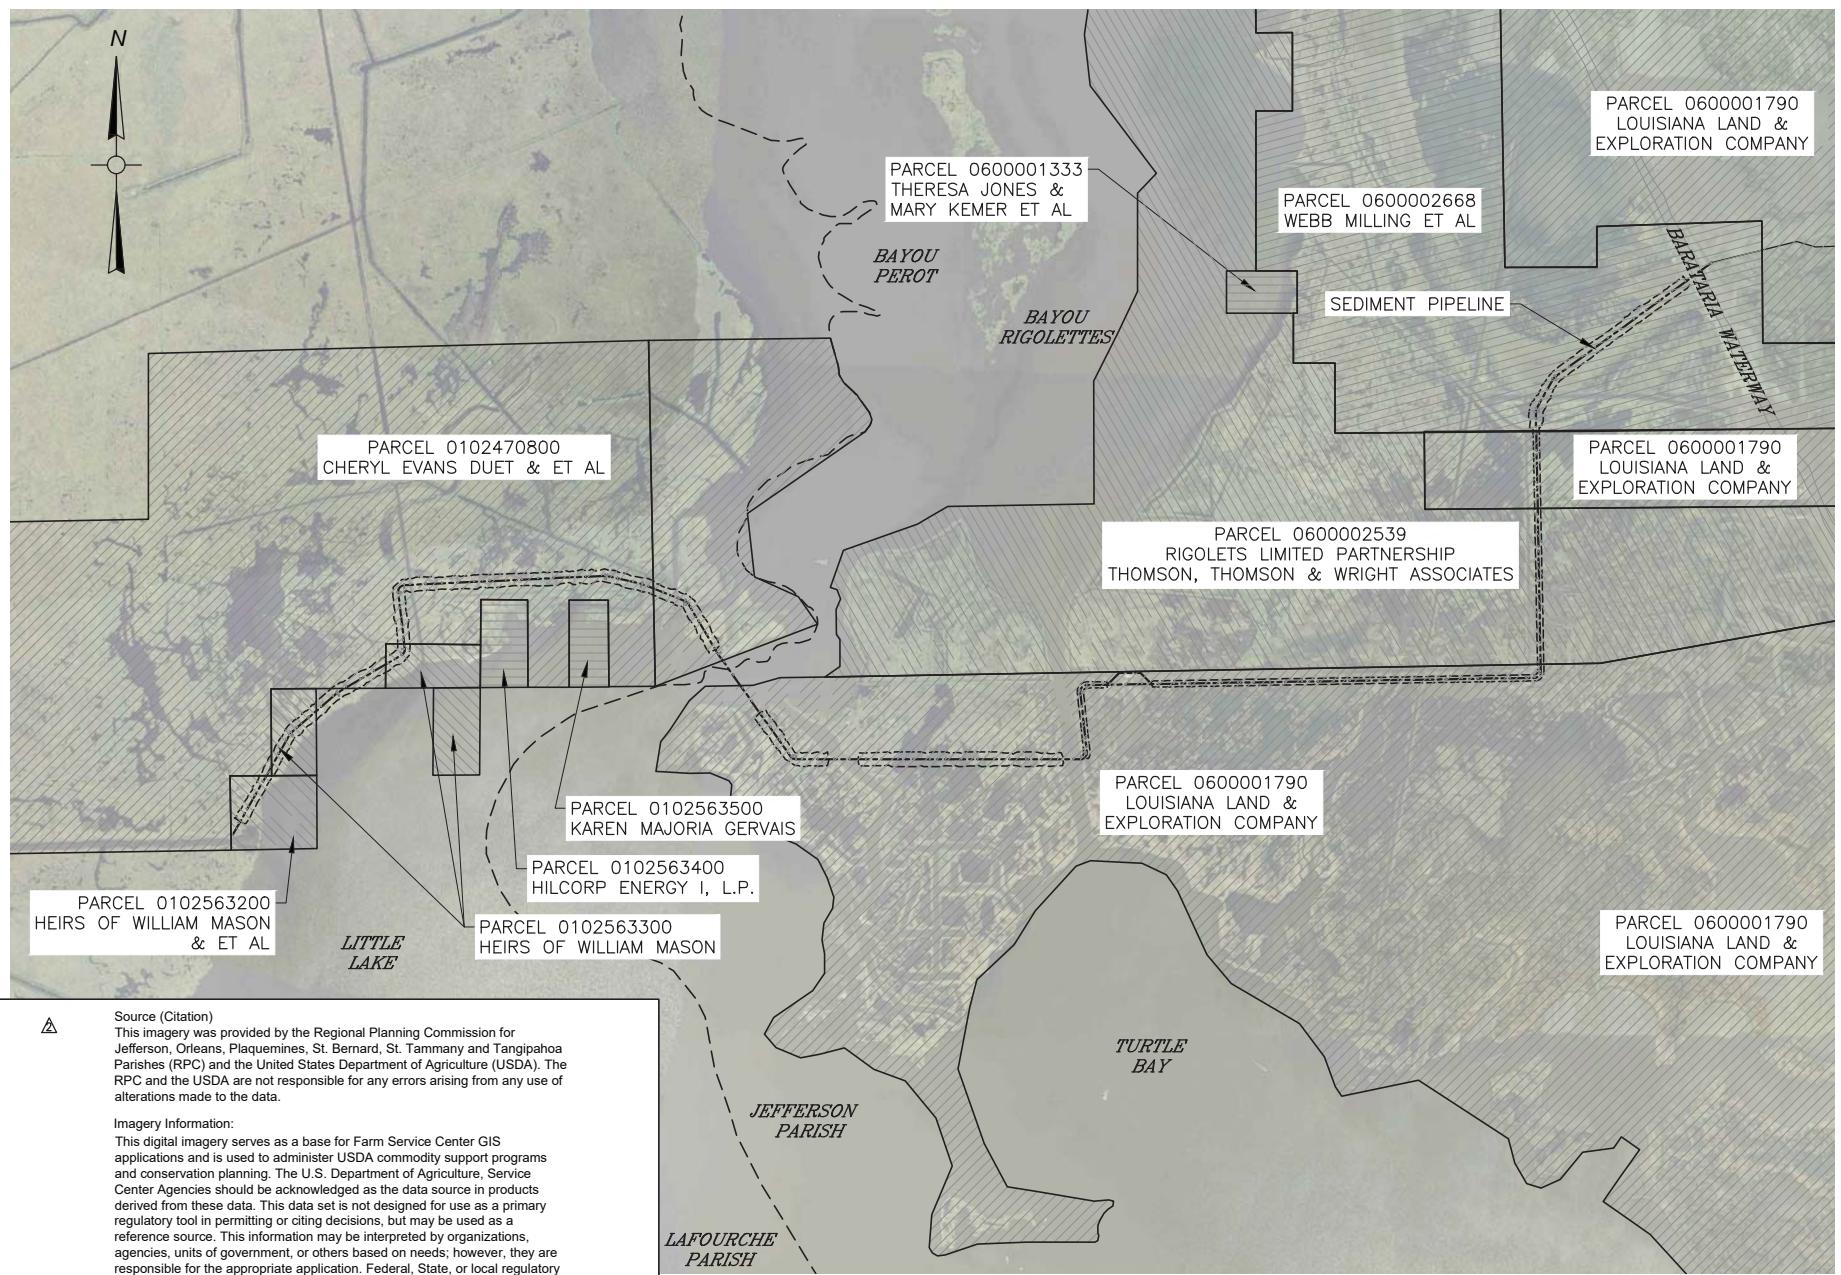

## Source (Citation)

This imagery was provided by the Regional Planning Commission for Jefferson, Orleans, Plaquemines, St. Bernard, St. Tammany and Tangipahoa Parishes (RPC) and the United States Department of Agriculture (USDA). The RPC and the USDA are not responsible for any errors arising from any use of alterations made to the data.

## Imagery Information:

This digital imagery serves as a base for Farm Service Center GIS applications and is used to administer USDA commodity support programs and conservation planning. The U.S. Department of Agriculture, Service Center Agencies should be acknowledged as the data source in products derived from these data. This data set is not designed for use as a primary regulatory tool in permitting or citing decisions, but may be used as a reference source. This information may be interpreted by organizations, agencies, units of government, or others based on needs; however, they are responsible for the appropriate application. Federal, State, or local regulatory bodies are not to reassign to the Service Center Agencies any authority for the decisions that they make. The Service Center Agencies will not perform any evaluations of these data for purposes related solely to State or local regulatory programs.

This color infrared geotiff imagery was captured in 2015 and projected to UTM; the unit of measure is meters. The compressed mrsid imagery was produced from the geotiff data as true color parish mosaics. Specific dates are included in imagery metadata at the file level. The spatial resolution is approximately one meter pixel. Any use of the data must be accompanied with this citation and accompanying seals and logos.



SPL	SPL
07/25/18	ADDED CITATION
03/16/18	PERMIT PLANS RE-ISSUED

NO.	DATE	TIME	DESCRIPTION

DESIGNED

CHECKED

DETAILED

CHECKED

SCALE

DATE



TIME

**APTIM**  
THE METACIRC CENTRE  
2024 EDENBOROUGH AVE.  
SUITE 460  
METairie, LA 70001 504.832.4878

LONG DISTANCE SEDIMENT PIPELINE WEST OF BARATARIA WATERWAY	PROPERTY OWNERS
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PROJECT NO.  
153455DATE  
MAY 2017SHEET NO.  
006



ELEVATION IN FEET NAVD88

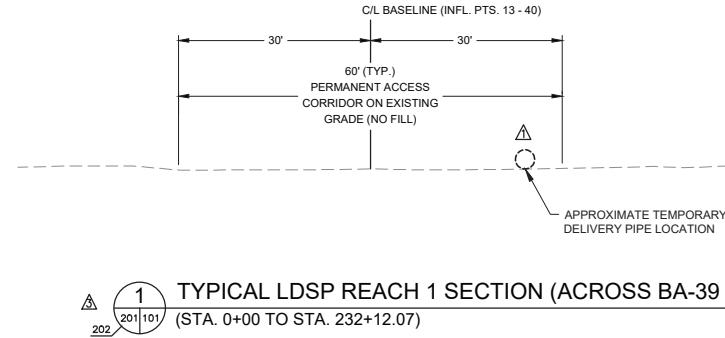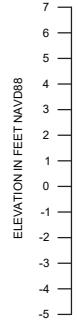



⚠ NOTE:  
TEMPORARY DELIVERY PIPE MAY BE LOCATED BY CONTRACTOR ANYWHERE WITHIN PERMANENT ACCESS CORRIDOR.




ELEVATION IN FEET NAVD88

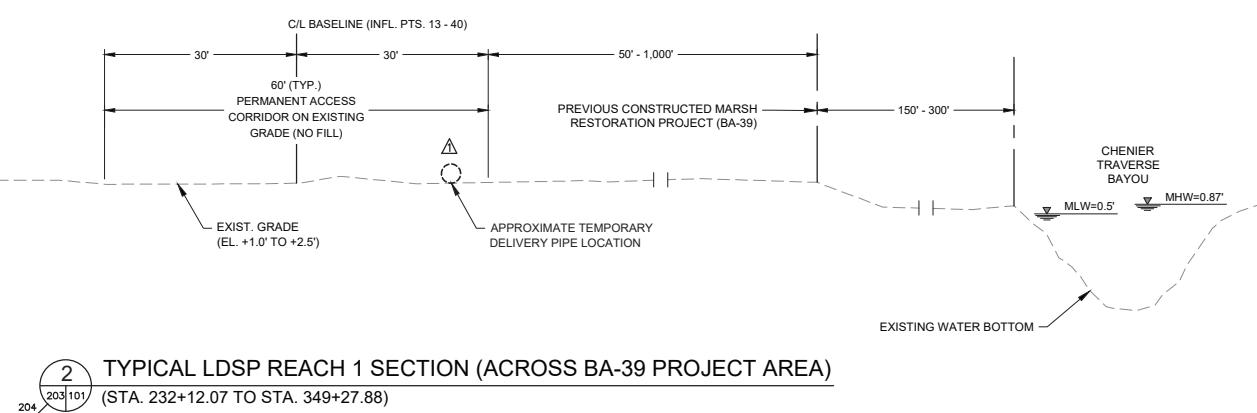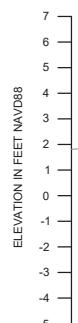

ELEVATION IN FEET NAVD88

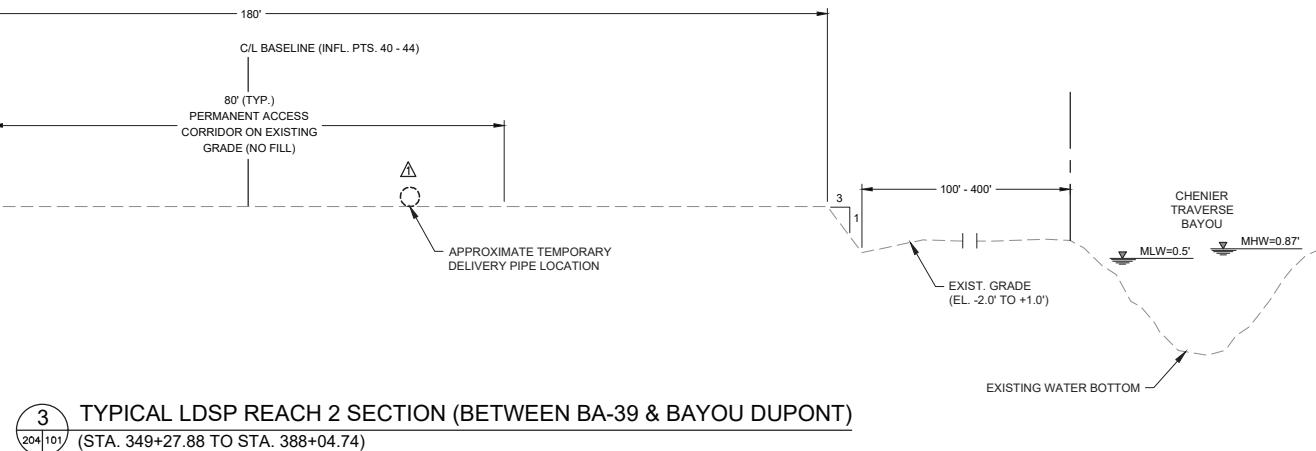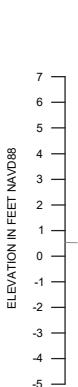

**NOTE:**  
1. EXISTING GROUND ELEVATIONS BASED ON TOPOGRAPHIC SURVEYS PERFORMED FROM JULY 26 THROUGH OCTOBER 10, 2011 BY T. BAKER SMITH, LLC.

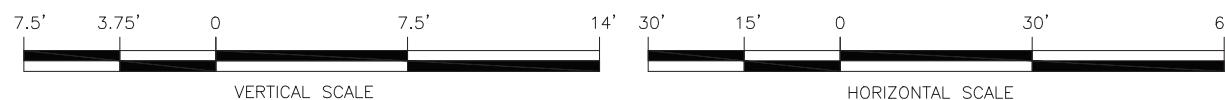

DESIGNED	SCALE	CHECKED	DATE	TIME	ADDED NEW TYPICAL SECTION	SPL
			03/16/18	PERMIT PLANS RE-ISSUED		
			03/15/18	TEMPORARY PIPE NOTED		
			03/15/18			
			NO. DATE	REVISION DESCRIPTION		


APTIM	THE METARIE CENTRE 205 LEFEBVRE AVE. SUITE 450 METARIE, LA 70001	504.832.4878
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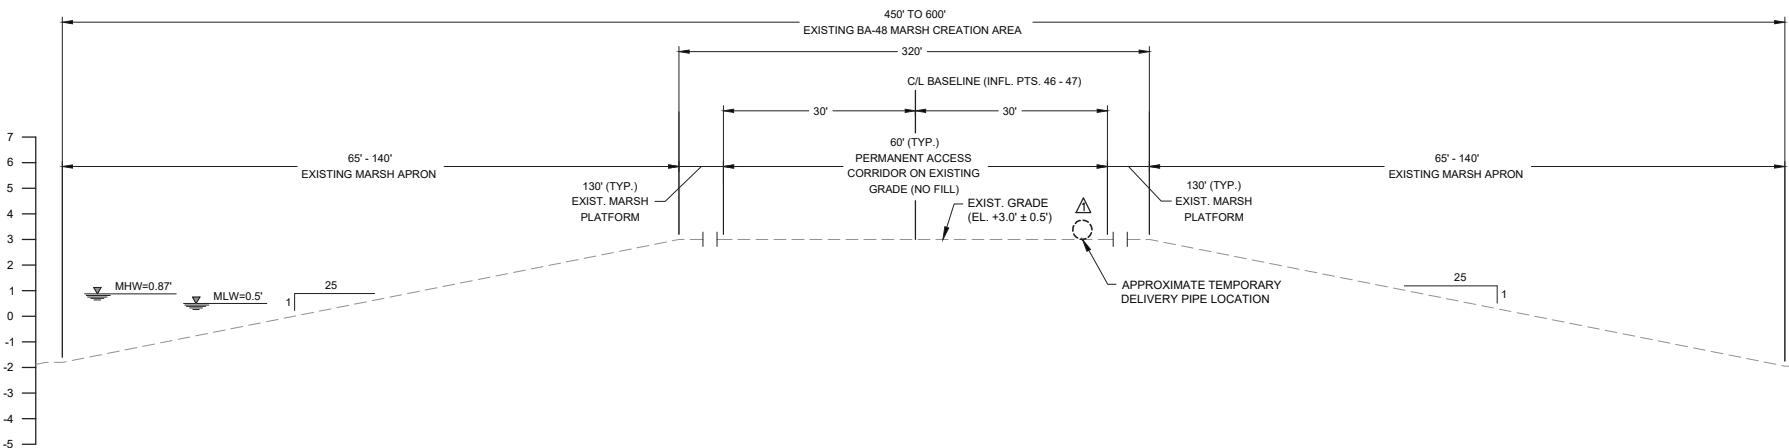
APTIM	LONG DISTANCE SEDIMENT PIPELINE WEST OF BARATARIA WATERWAY	BASE BID: TYPICAL LDSP EXISTING SECTIONS
-------	---	---


PROJECT NO.	153455
DATE	MAY 2017
SHEET NO.	101



**TYPICAL LDSP REACH 3 SECTION (ACROSS BA-48 MARSH CREATION AREA)**

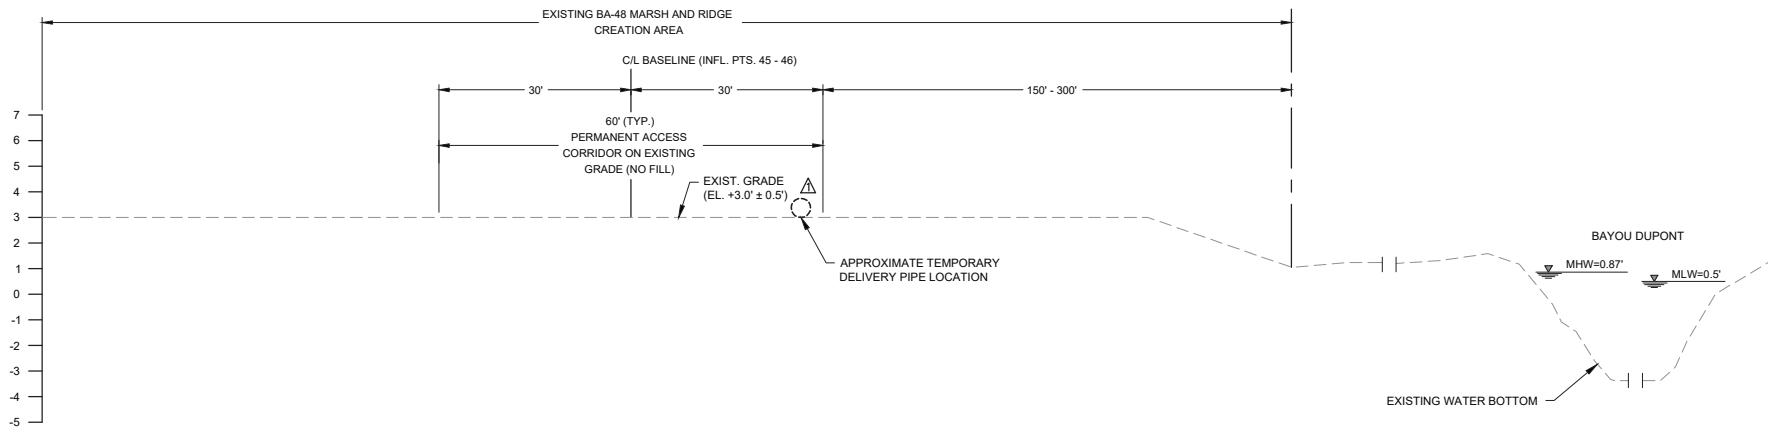

**TYPICAL LDSP REACH 4 SECTION (FROM BA-48 TO THE FISH CAMP)**

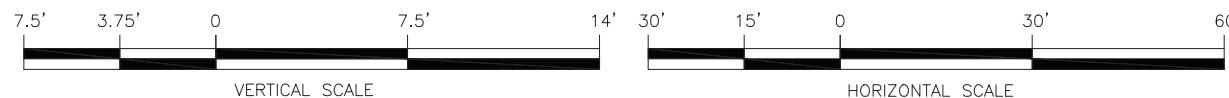

**NOTE:**  
TEMPORARY DELIVERY PIPE MAY BE LOCATED BY  
CONTRACTOR ANYWHERE WITHIN PERMANENT  
ACCESS CORRIDOR.




DESIGNED	SCALE	07/25/18	RENUMBERED TYPICAL SECTIONS
CHECKED	DATE	03/16/18	PERMIT PLANS RE-ISSUED
DETAILED	TIME	03/15/18	TEMPORARY PIPE NOTED
NO.	DATE	REVISION DESCRIPTION	B/L




LONG DISTANCE SEDIMENT PIPELINE  
WEST OF BARATARIA WATERWAY  
BASE BID: TYPICAL LDSP  
EXISTING SECTIONS

PROJECT NO.  
153455  
DATE  
MAY 2017  
SHEET NO.  
102


ELEVATION IN FEET NAVD88

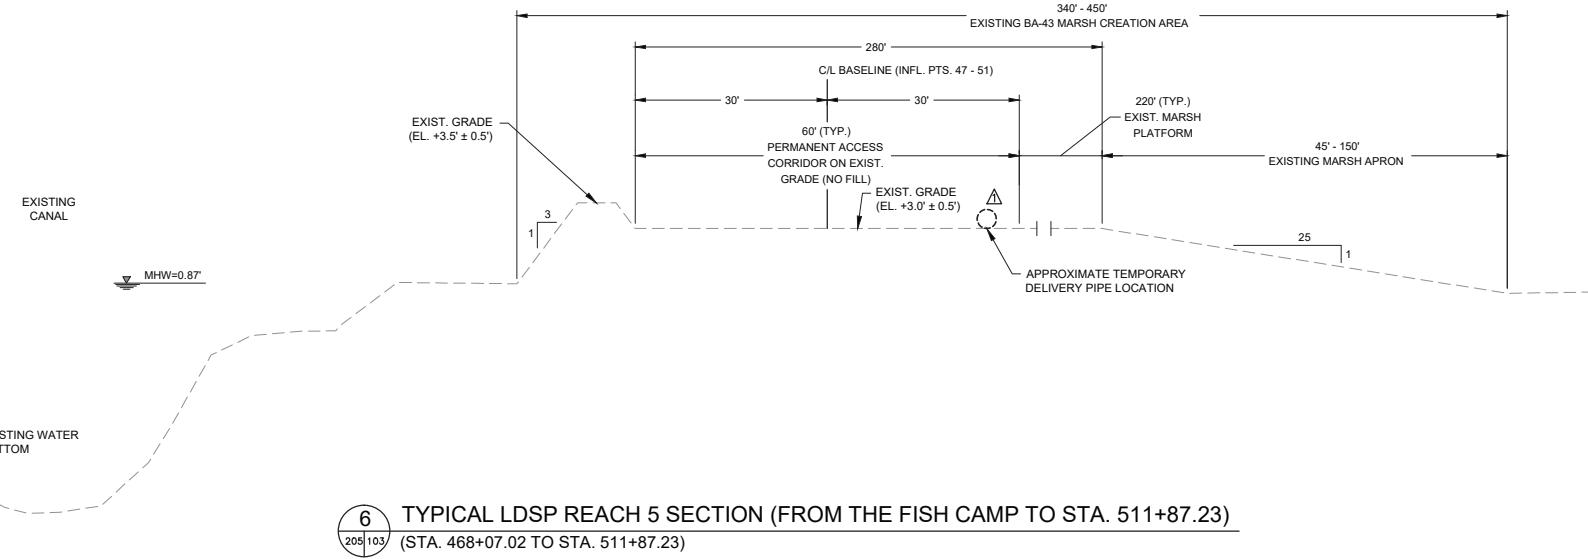

ELEVATION IN FEET NAVD88

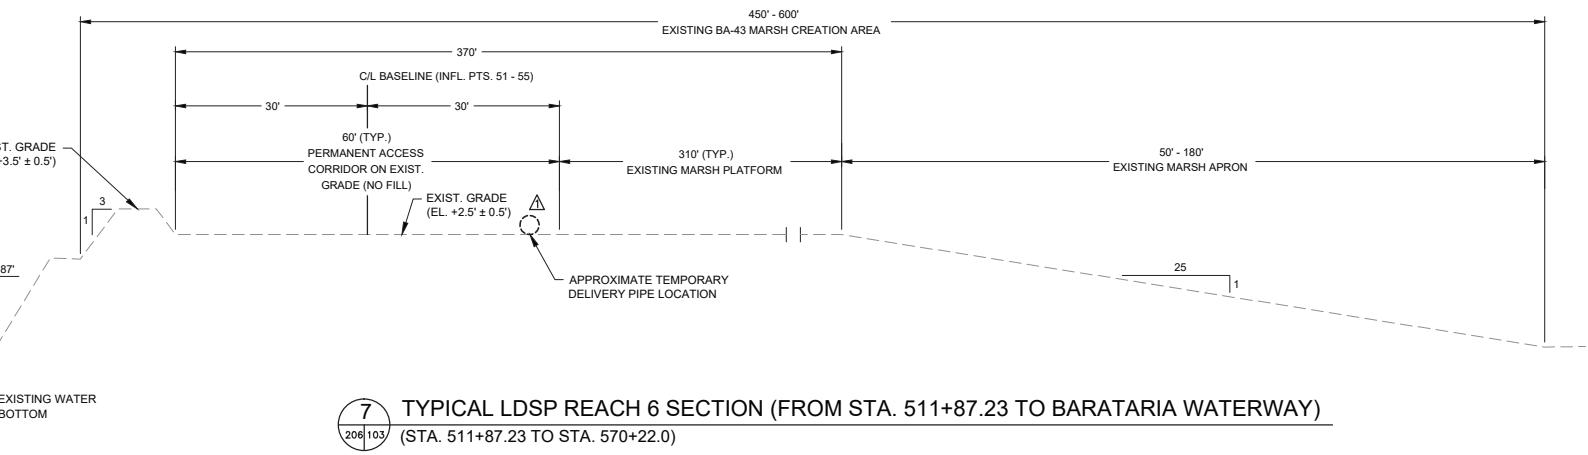**NOTE:**

- EXISTING GROUND ELEVATIONS BASED ON TOPOGRAPHIC SURVEYS PERFORMED FROM JULY 26 THROUGH OCTOBER 10, 2011 BY T. BAKER SMITH, LLC.

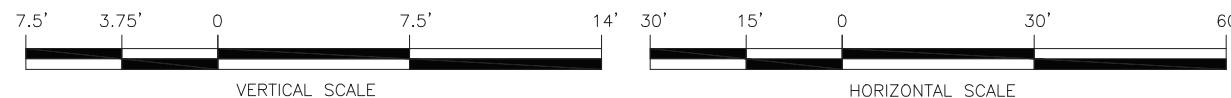

**NOTE:**  
TEMPORARY DELIVERY PIPE MAY BE LOCATED BY CONTRACTOR ANYWHERE WITHIN PERMANENT ACCESS CORRIDOR.



DESIGNED	SCALE	RENUMBERED	TYPICAL	SECTION	SPL
CHECKED	DATE	03/16/18	PERMIT	PLANS	SPL
DETAILED	TIME	03/15/18	RE-ISSUED	TEMPORARY PIPE	SPL
NO.	DATE	REVISION	DESCRIPTION		


THE METairie CENTRE 2024 EDEMBURG AVE. SUITE 450 METairie, LA 70001	504.832.4878
--	--------------

<b>APTIM</b> Long Distance Sediment Pipeline West of Barataria Waterway	Base Bid: Typical LDSP Existing Sections
---	---


  

PROJECT NO. 153455	DATE MAY 2017
SHEET NO. 103	

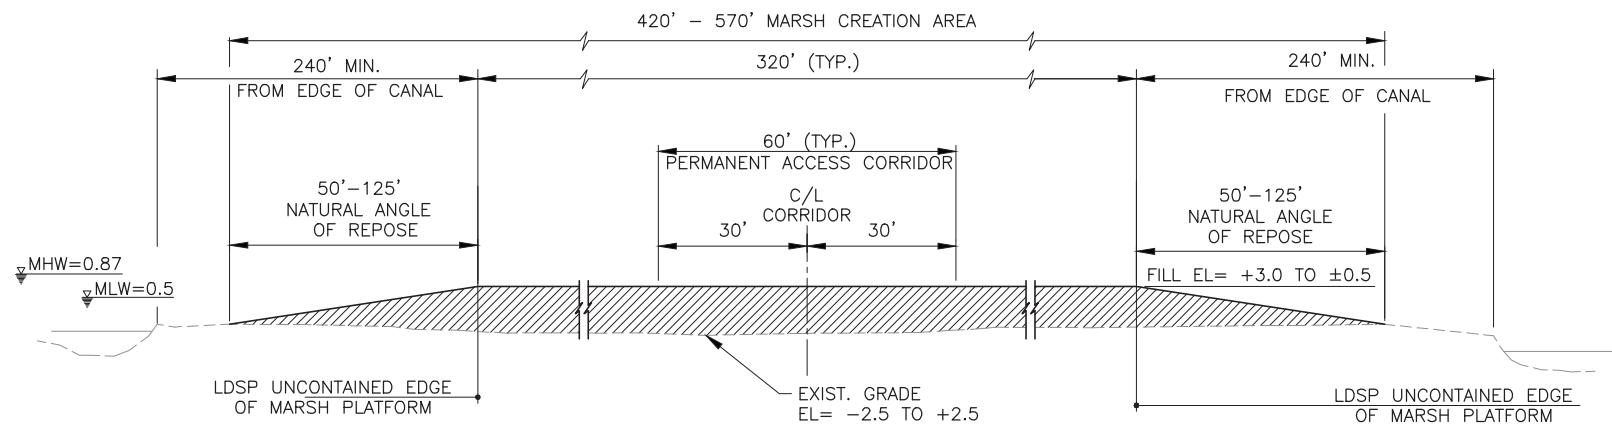


### TYPICAL LDSP SECTION 1

STA. 580+00 TO 647+00 (59 ACRES)  
 STA. 898+25 TO 962+50 (63 ACRES) ▲  
 STA. 972+25 TO 1000+25 (27 ACRES)  
 STA. 1025+25 TO 1231+74.81 (189 ACRES)  
 N.T.S.

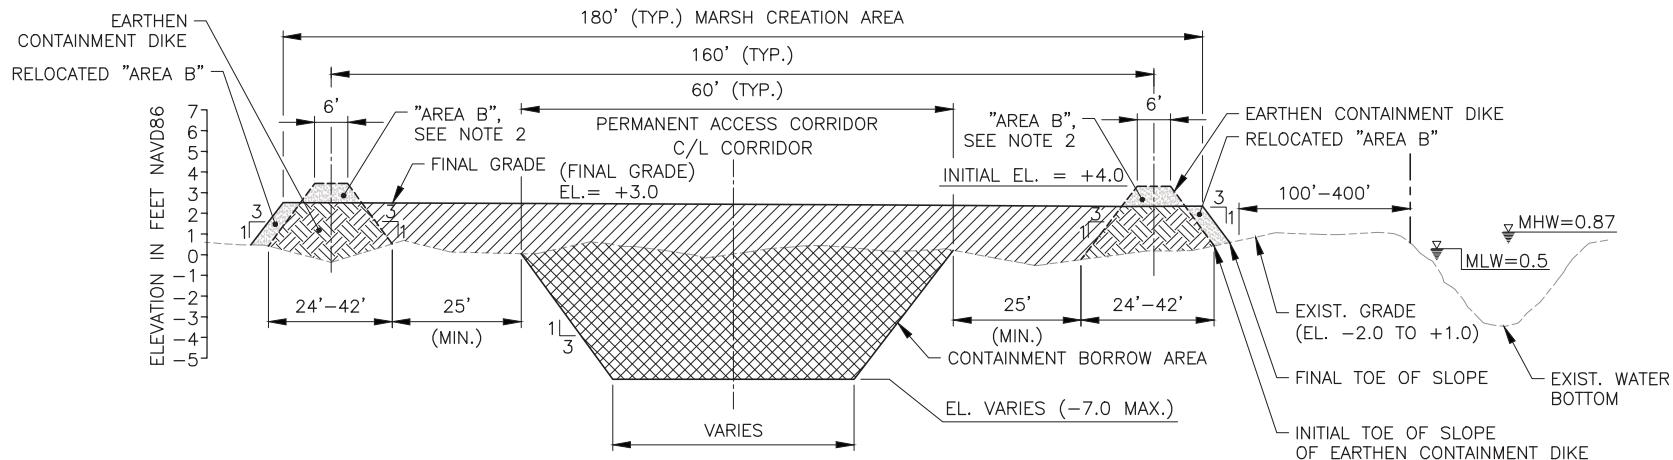

### TYPICAL LDSP SECTION 2

STA. 647+00 TO 847+00 (89 ACRES)  
 STA. 861+25 TO 891+00 (14 ACRES) ▲  
 N.T.S.

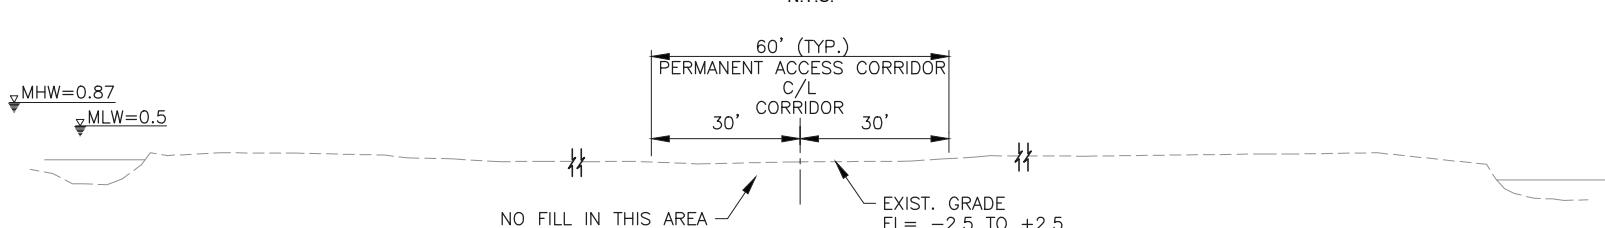

### TYPICAL LDSP SECTION 3

STA. 1231+74.81 TO STA. 1234+33.83  
 N.T.S. ▲

### NOTES:

1. EXISTING GROUND ELEVATIONS BASED ON LIDAR DATA.
2. THE CONTRACTOR SHALL MECHANICALLY RELOCATE "AREA B" MATERIAL TO THE LOCATION LABELED "RELOCATED AREA B" PRIOR TO DEMOBILIZATION.



DESIGNED	SCALE	CHECKED	DATE	TIME
			07/25/18	ADDED NEW TYP. SECTION & ACRES SPL.
			03/16/18	PERMIT PLANS RE-ISSUED SPL.
			No. DATE	REVISION DESCRIPTION SPL. BY

DESIGNED	SCALE	CHECKED	DATE	TIME

APTIM	THE METAIRIE CENTRE SUITE 460 LEEDERSVILLE METAIRIE, LA 70001 504.832.4878
APTIM	LEEDERSVILLE

LONG DISTANCE PIPELINE WEST OF BARATARIA WATERWAY	TYPICAL SECTIONS
PROJECT NO.	
153455	
DATE	
MAY 2017	
SHEET NO.	
104	

MATCHLINE STA. 105+00  
SEE SHEET 202

LONG DISTANCE PIPELINE  
WEST OF BARATARIA WATERWAY  
PIPELINE CORRIDOR LAYOUT  
SHEETS (1 of 6)

PROJECT NO.  
153455


DATE  
MAY 2017

SHEET NO.  
201

**APTIM**  
THE METANIC CENTRE  
2024 FEDERAL DRIVE  
METairie, LA 70001 504.832.4878



DESIGNED	SCALE	CHECKED	DATE	TIME	SPL	SPL	BY
			07/25/18	CITATION NOTE REVISION	A	03/16/18	PERMIT PLANS RE-ISSUED

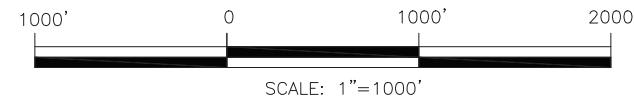MATCHLINE STA. 215+00  
SEE SHEET 203Pipeline Corridor Layout

**NOTE:**  
SEE SHEET 006 FOR IMAGERY DISCLAIMER CITATION PROVIDED BY  
THE REGIONAL PLANNING COMMISSION AND THE UNITED STATES  
DEPARTMENT OF AGRICULTURE (USDA).



DESIGNED	SCALE	DATE	TIME	REVISION DESCRIPTION
		07/25/18		CITATION NOTE REVISION
		03/16/18		PERMIT PLANS RE-ISSUED
		03/15/18		BOOSTER PUMP LAT/LONG
		NO.	DATE	

DESIGNED	SCALE	DATE	TIME	REVISION DESCRIPTION


**APTIM**  
THE METANIRI CENTRE  
2024 EDENBROOK LANE  
METairie, LA 70001 504.832.4878






**APTIM**  
PROJECT NO.  
153455  
DATE  
MAY 2017  
SHEET NO.  
202

**LONG DISTANCE SEDIMENT PIPELINE  
WEST OF BARATARIA WATERWAY**  
**Pipeline Corridor Layout Sheets (2 of 6)**

MATCHLINE STA. 305+00  
SEE SHEET 204

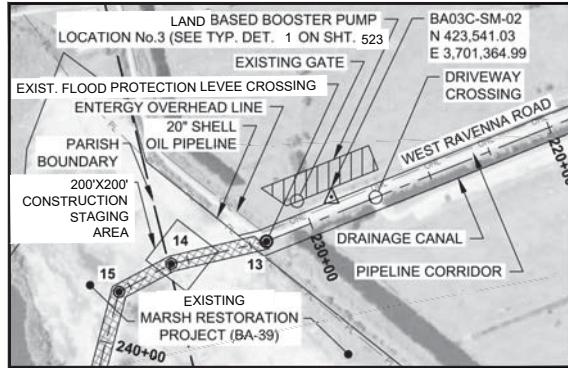

Pipeline Corridor Layout

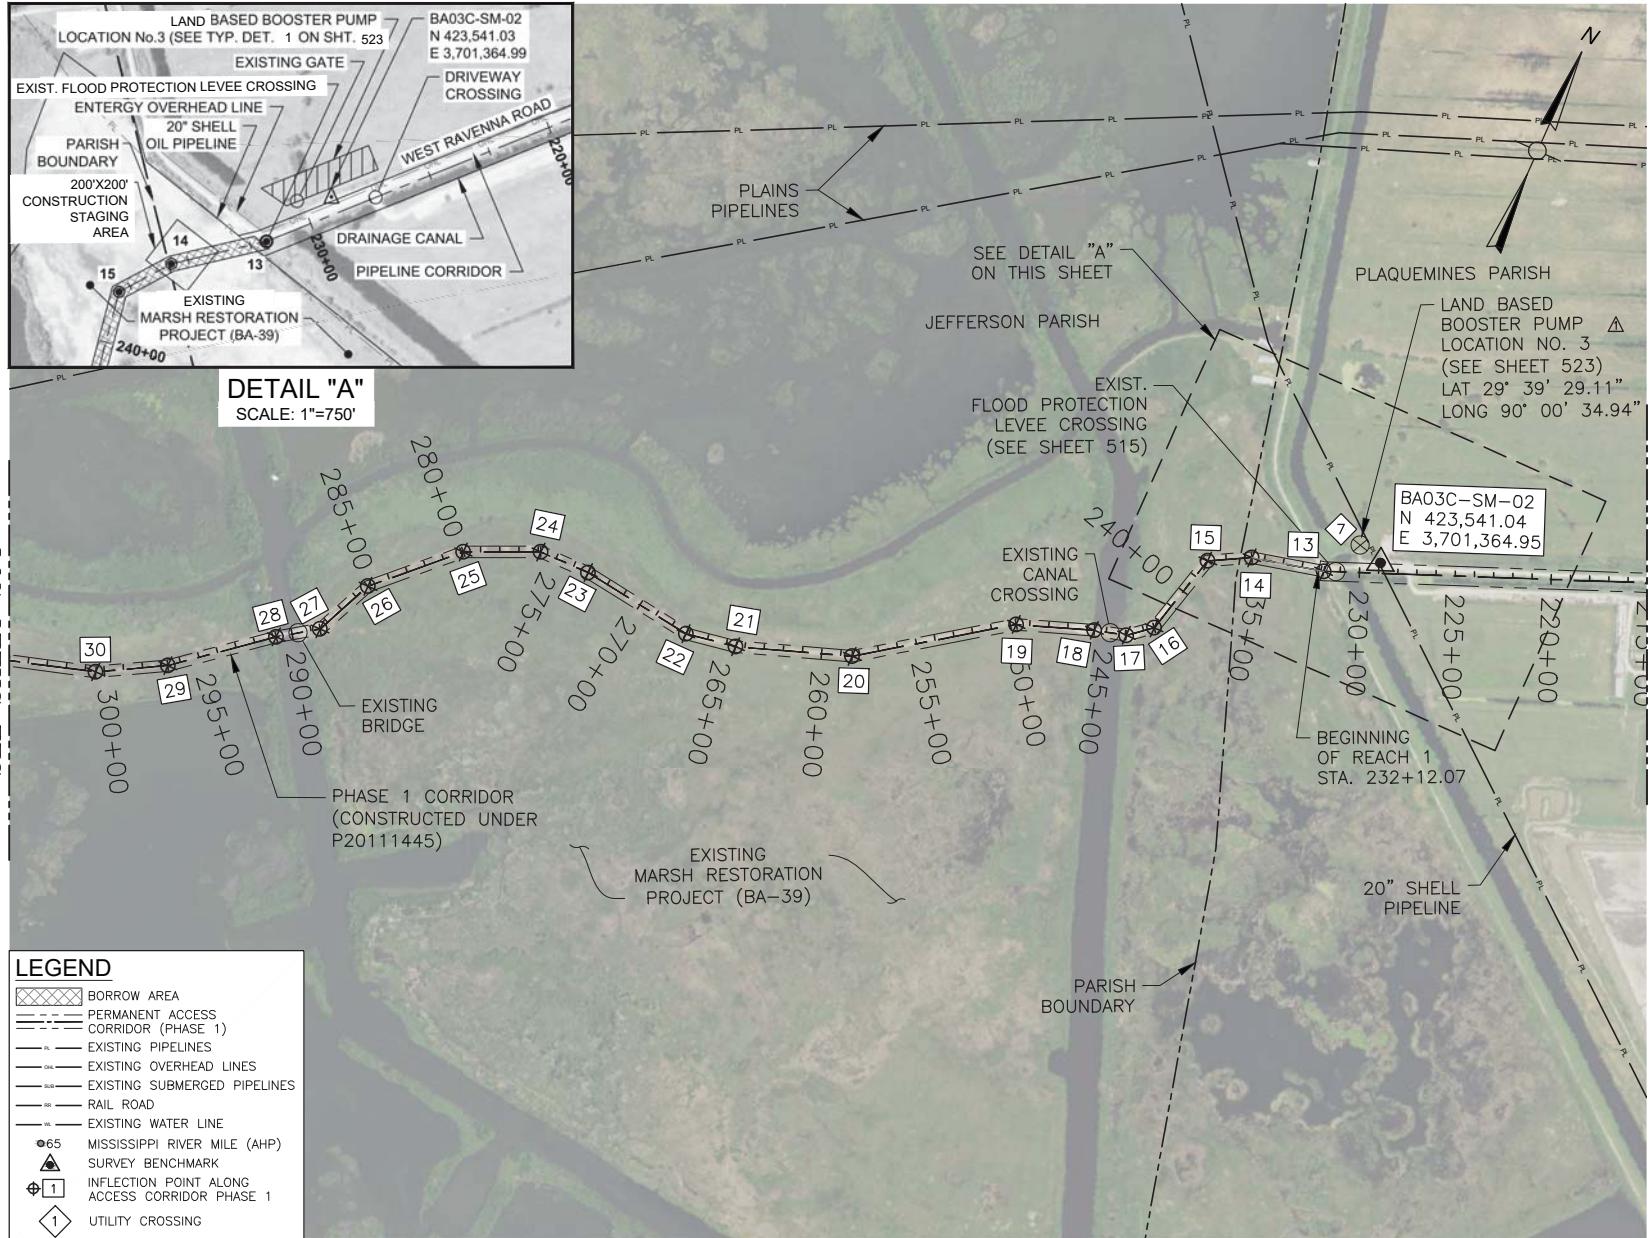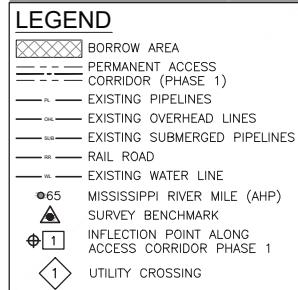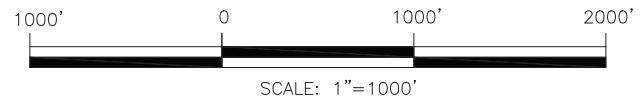

NOTE:  
SEE SHEET 006 FOR IMAGERY DISCLAIMER CITATION PROVIDED BY  
THE REGIONAL PLANNING COMMISSION AND THE UNITED STATES  
DEPARTMENT OF AGRICULTURE (USDA).



APTIM  
THE METAPHYSICAL CENTRE  
2024 EDEMBURG AV.  
METairie, LA 70001 504.832.4878  
LONG DISTANCE PIPELINE  
WEST OF BARATARIA WATERWAY  
PIPELINE CORRIDOR LAYOUT  
SHEETS (3 of 6)


PROJECT NO.  
153455  
DATE  
MAY 2017  
SHEET NO.  
203



DESIGNED	SCALE	07/25/18 CITATION NOTE REVISION
		03/16/18 PERMIT PLANS RE-ISSUED
CHECKED	DATE	03/15/18 BOOSTER PUMP LAT/LONG
DETAILED	TIME	NO. DATE REVISION DESCRIPTION


MATCHLINE STA. 400+00  
SEE SHEET 205

卷四

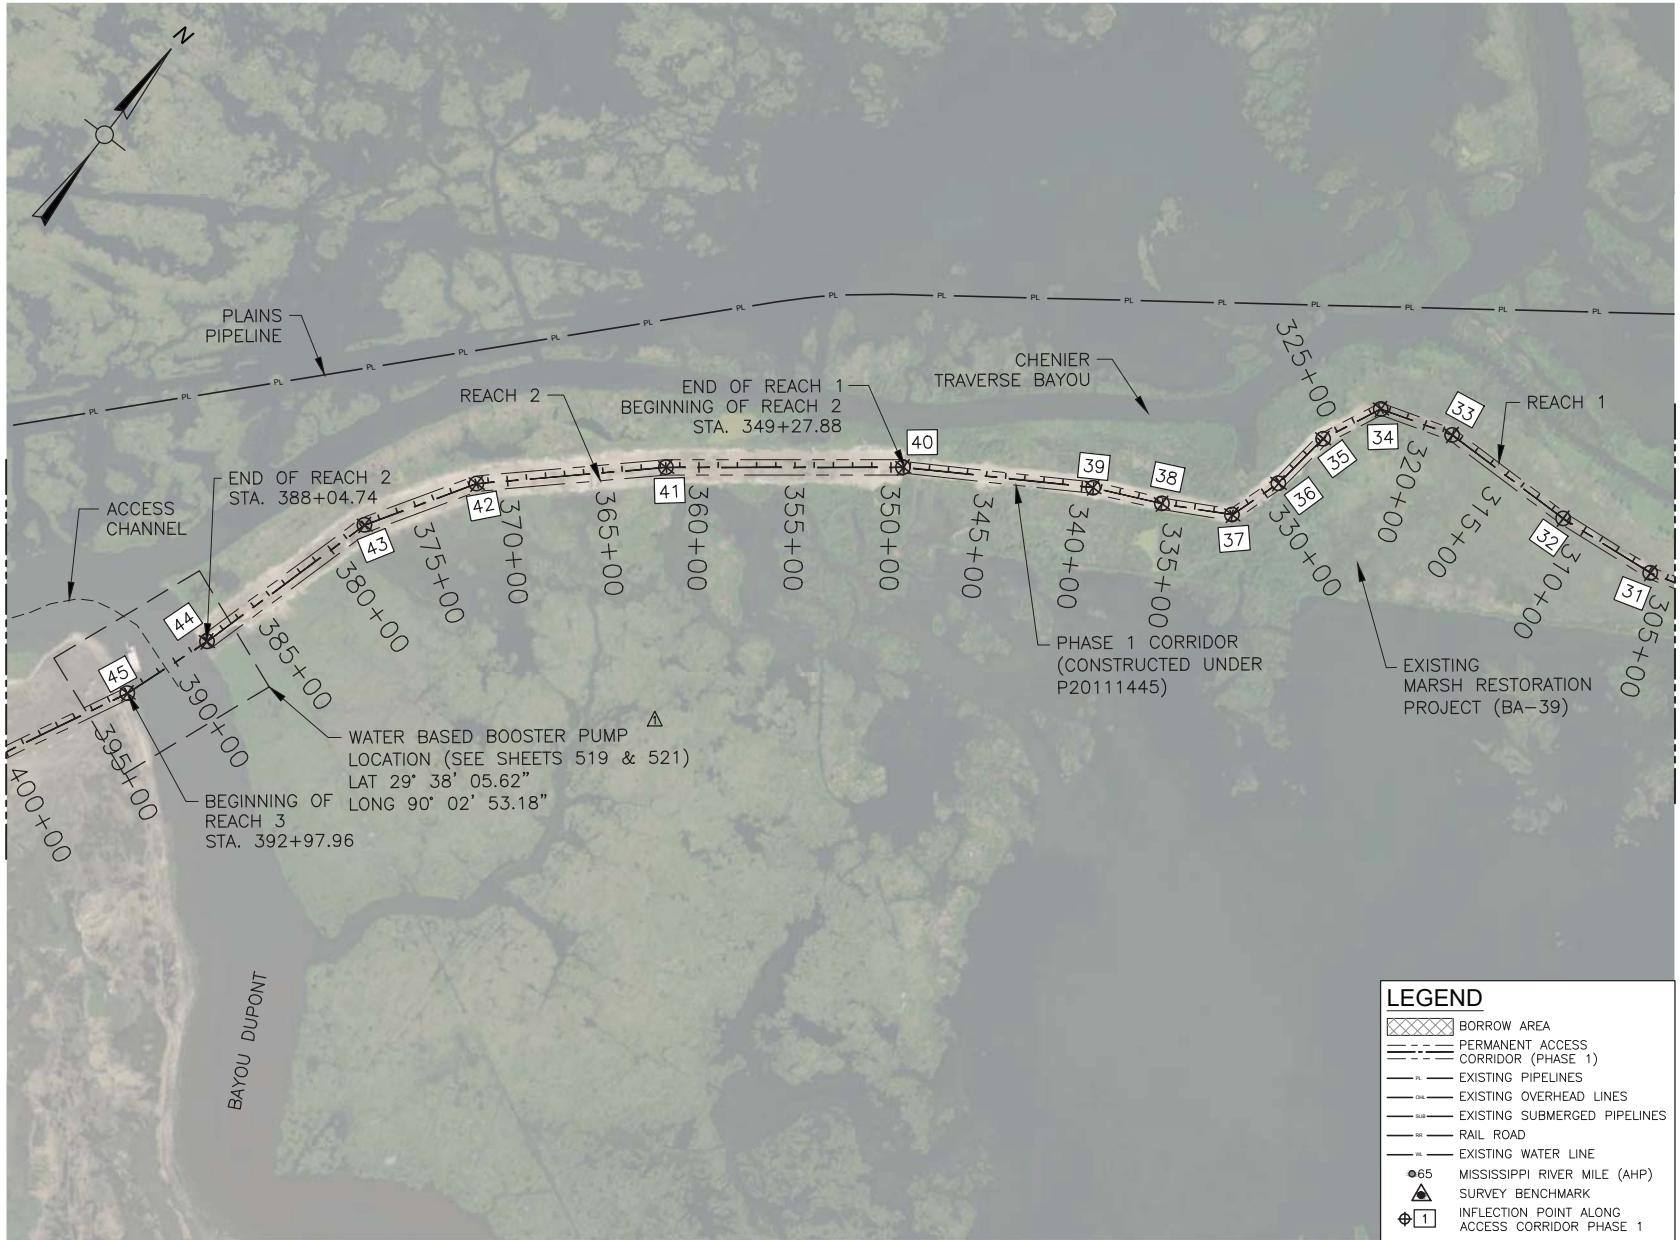

## PIPELINE CORRIDOR LAYOUT

A horizontal scale bar diagram. It features three vertical tick marks labeled '1000'' at the left end, '0' in the center, and '1000'' at the right end. To the right of the '1000'' label is another tick mark without a label. A thick black horizontal line starts at the first tick mark and ends at the unlabeled tick mark. Below the scale bar, the text 'SCALE: 1"=1000'' is centered.

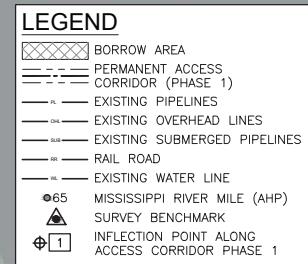


**NOTE:**  
SEE SHEET 006 FOR IMAGERY DISCLAIMER CITATION PROVIDED BY  
THE REGIONAL PLANNING COMMISSION AND THE UNITED STATES  
DEPARTMENT OF AGRICULTURE (USDA).




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 APTIM THE METACRE CENTRE 2242 DEBONAIR AVE. SUITE 450 METairie, LA 70001 504.832.4878	LONG DISTANCE SEDIMENT PIPELINE WEST OF BARATARIA WATERWAY	PIPELINE CORRIDOR LAYOUT SHEETS (4 of 6)	PROJECT NO. 153455	DATE MAY 2017	SHEET NO. 204
	DESIGNED CHECKED	SCALE	07/25/18 CITATION NOTE, REVISION SPL	03/16/18 PERMIT PLANS, RE-ISSUED SPL	03/15/18 BOOSTER PUMP LAT/ LONG SPL
	DETAILED CHECKED	DATE TIME	NO.	DATE	DESCRIPTION BY



### Pipeline Corridor Layout

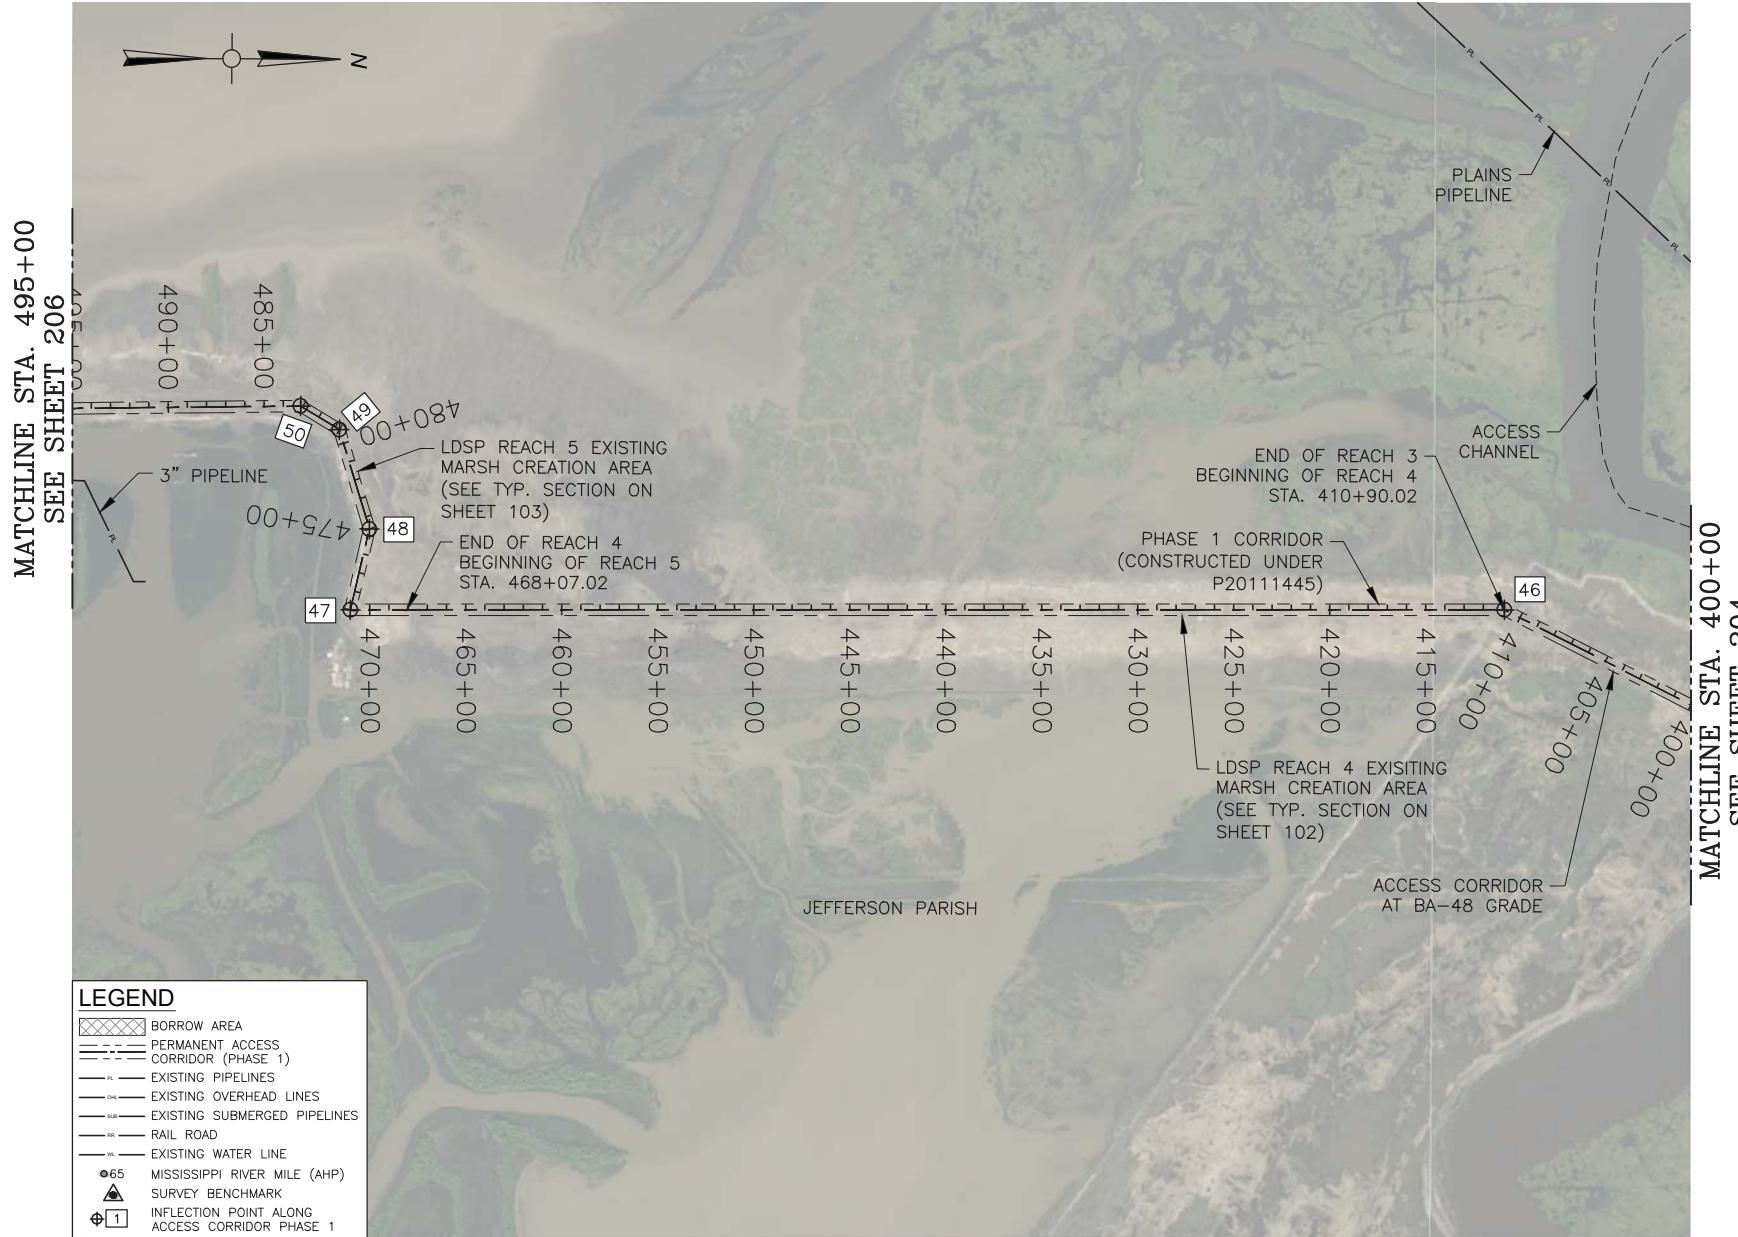

**NOTE:**  
SEE SHEET 006 FOR IMAGERY DISCLAIMER CITATION PROVIDED BY THE REGIONAL PLANNING COMMISSION AND THE UNITED STATES DEPARTMENT OF AGRICULTURE (USDA).

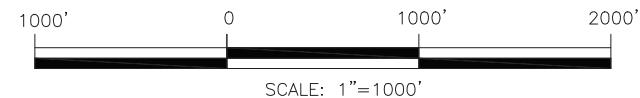

APTIM  
CONSULTING ENGINEERS

Long Distance Sediment Pipeline  
West of Barataria Waterway

Pipeline Corridor Layout

Sheets (5 of 6)

Project No. 153455

Date May 2017


Sheet No. 205

07/25/18 CITATION NOTE REVISION

03/16/18 PERMIT PLANS RE-ISSUED

No. Date Revision Description

SPL SPL BY

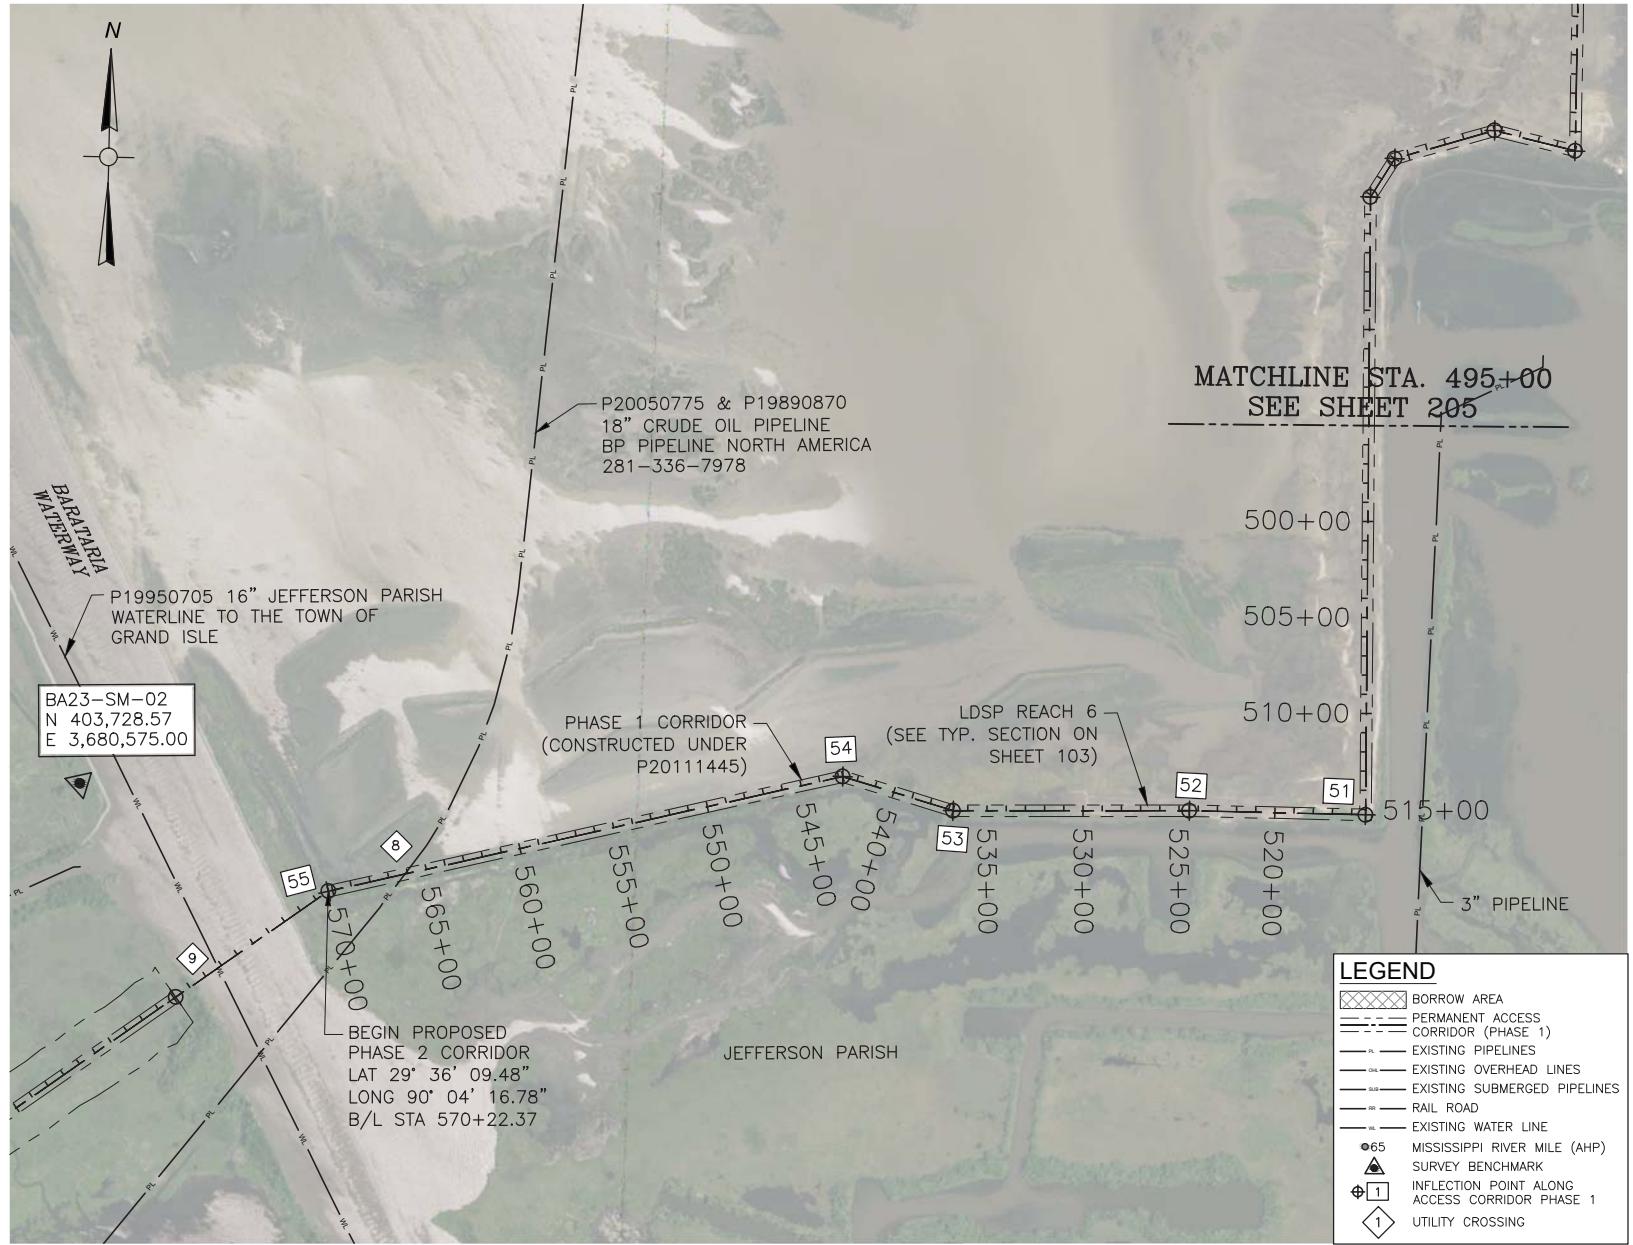

**MATCHLINE STA. 495+00  
SEE SHEET 205**

500+00  
505+00  
510+00  
515+00  
520+00  
525+00  
530+00  
535+00  
540+00  
545+00  
550+00  
555+00  
560+00  
565+00  
570+00

3" PIPELINE



Long Distance  
Sediment Pipeline  
West of Barataria Waterway

Project No.  
153455  
Date  
May 2017  
Sheet No.  
206

07/25/18 CITATION NOTE REVISION  
03/16/18 PERMIT PLANS RE-ISSUED  
No. Date Revision Description

DESIGNED  
CHECKED  
DETAILED  
CHECKED

SCALE  
DATE  
TIME

SPL  
SPL  
BY

APTIM  
THE METairie CENTRE  
2024 EDENBOROUGH AVE.  
METAIRIE, LA 70001 504.832.4878

APTIM  
THE METairie CENTRE  
2024 EDENBOROUGH AVE.  
METAIRIE, LA 70001 504.832.4878

APTIM  
THE METairie CENTRE  
2024 EDENBOROUGH AVE.  
METAIRIE, LA 70001 504.832.4878

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THE METairie CENTRE  
2024 EDENBOROUGH AVE.  
METAIRIE, LA 70001 504.832.4878

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THE METairie CENTRE  
2024 EDENBOROUGH AVE.  
METAIRIE, LA 70001 504.832.4878

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THE METairie CENTRE  
2024 EDENBOROUGH AVE.  
METAIRIE, LA 70001 504.832.4878

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THE METairie CENTRE  
2024 EDENBOROUGH AVE.  
METAIRIE, LA 70001 504.832.4878

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THE METairie CENTRE  
2024 EDENBOROUGH AVE.  
METAIRIE, LA 70001 504.832.4878

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THE METairie CENTRE  
2024 EDENBOROUGH AVE.  
METAIRIE, LA 70001 504.832.4878

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THE METairie CENTRE  
2024 EDENBOROUGH AVE.  
METAIRIE, LA 70001 504.832.4878

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THE METairie CENTRE  
2024 EDENBOROUGH AVE.  
METAIRIE, LA 70001 504.832.4878


APTIM  
THE METairie CENTRE  
2024 EDENBOROUGH AVE.  
METAIRIE, LA 70001 504.832.4878

APTIM  
THE METairie CENTRE  
2024 EDENBOROUGH AVE.  
METAIRIE, LA 70001 504.832.4878

APTIM  
THE METairie CENTRE  
2024 EDENBOROUGH AVE.  
METAIRIE, LA 70001 504.832.4878

APTIM  
THE METairie CENTRE  
2024 EDENBOROUGH AVE.  
METAIRIE, LA 70001 504.832.4878

APTIM  
THE METairie CENTRE  
2024 EDENBOROUGH AVE.  
METAIRIE, LA 70001 504.832.4878

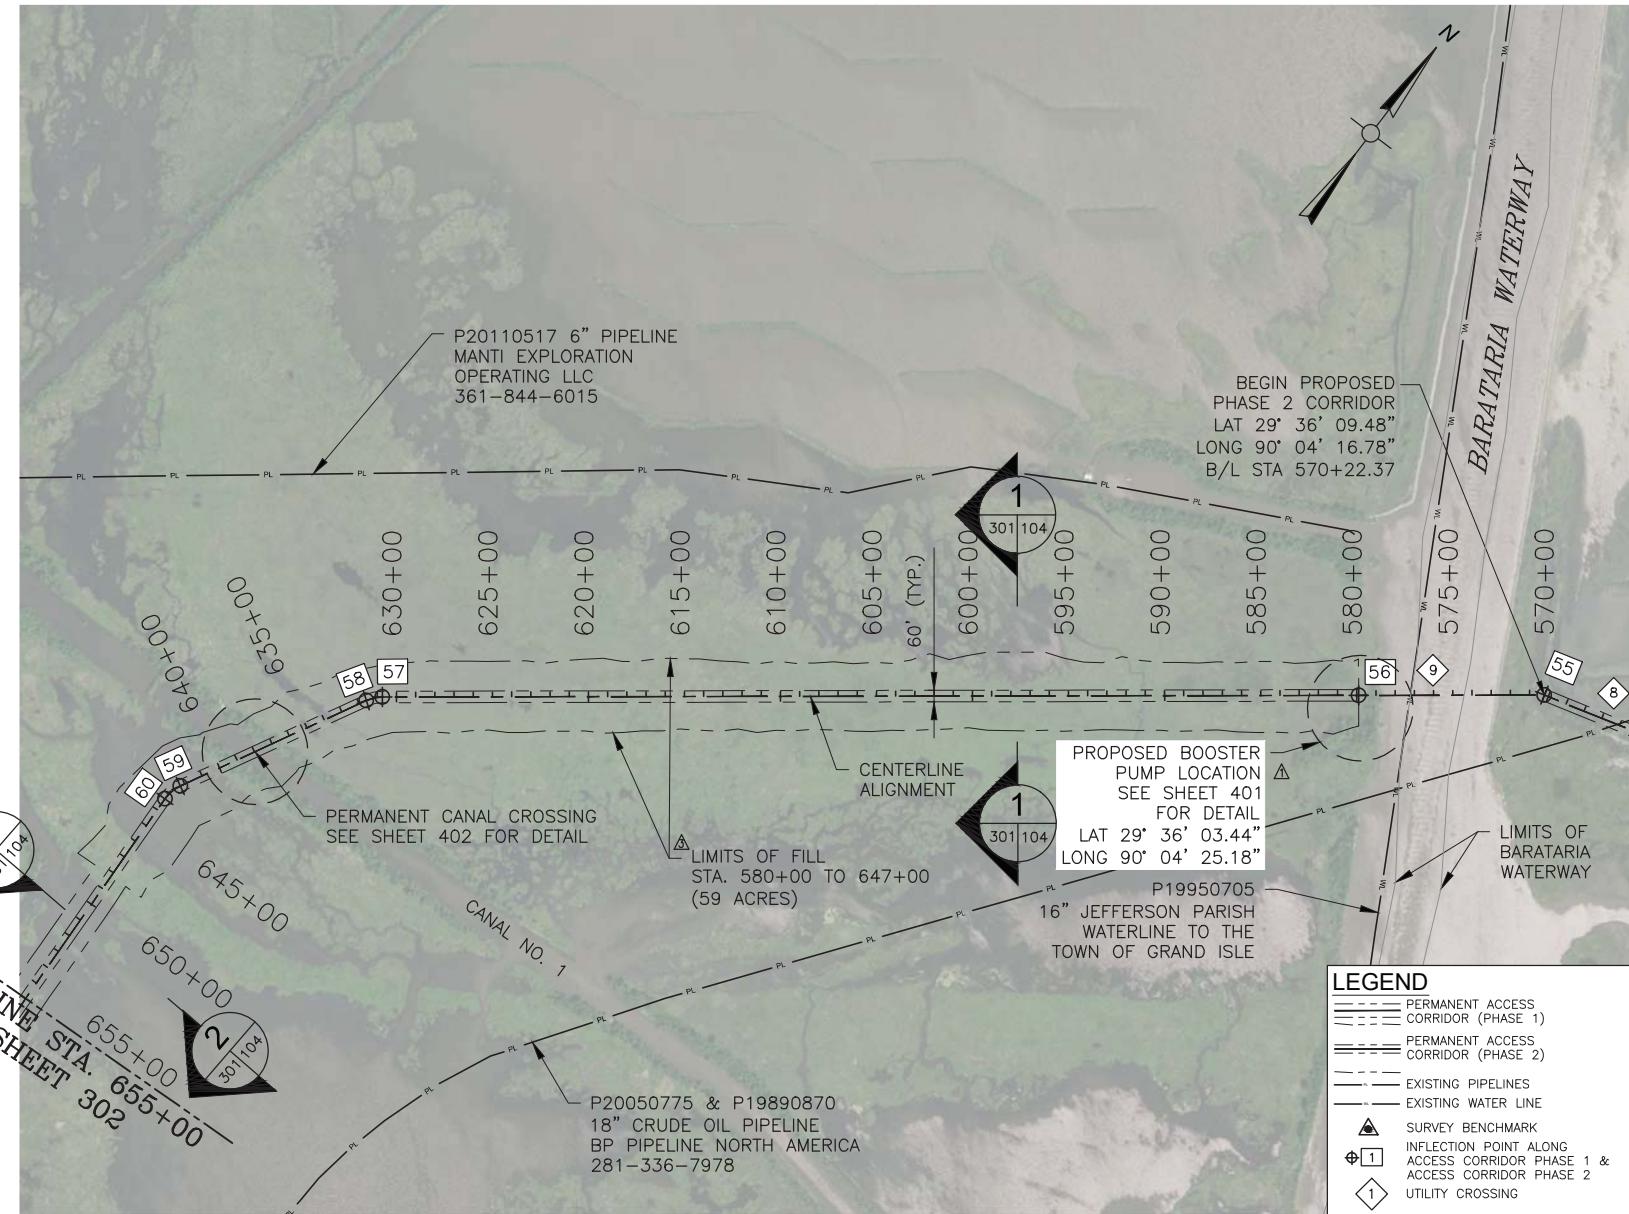

## PIPELINE CORRIDOR LAYOUT

1000'                    0                    1000'                    2000'

SCALE: 1"=1000'

NOTE: SEE SHEET 403 FOR BARATARIA WATERWAY CROSSING.

**NOTE:**  
SEE SHEET 006 FOR IMAGERY DISCLAIMER CITATION PROVIDED BY  
THE REGIONAL PLANNING COMMISSION AND THE UNITED STATES  
DEPARTMENT OF AGRICULTURE (USDA).



		THE NEIGHBOURHOOD CENTRE		208 E. BONNIEVIEW AVE.		SUITE 400		METairie, LA 70001 504-832-4878	
		APTIM		APTIM		APTIM		APTIM	
DESIGNED		SCALE		CHECKED					
DETAILED		DATE		TIME					
CHECKED									
A07/25/18 REVISED CITATION & ADDED ACRES SPL									
A03/15/18 PERMIT PLANS RE-ISSUED SPL									
A03/15/18 BOOSTER PUMP LAT/LONG SPL									
NO. DATE REVISION DESCRIPTION BY									
LONG DISTANCE SEDIMENT PIPELINE WEST OF BARATARIA WATERWAY									
PIPELINE CORRIDOR LAYOUT SHEETS (1 OF 7)									
PROJECT NO. 153455									
DATE MAY 2017									
SHEET NO. 301									

MATCHLINE STA. 760+00  
SEE SHEET 303



755+00  
750+00  
745+00  
740+00  
735+00  
730+00

CANAL NO. 2

62  
7254

720+00

715+00  
2  
302 104  
710+00

705+00

700+00

695+00

690+00

685+00

680+00

5/5+00

100+0

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300

P20050775 & P19890870  
18" CRUDE OIL PIPELINE  
BP PIPELINE NORTH AMERICA  
281-366-7978

## PIPELINE CORRIDOR LAYOUT

1000' 0 1000' 2000'

SCALE: 1"=1000'

**NOTE:**  
SEE SHEET 006 FOR IMAGERY DISCLAIMER CITATION PROVIDED BY  
THE REGIONAL PLANNING COMMISSION AND THE UNITED STATES  
DEPARTMENT OF AGRICULTURE (USDA).

## LEGEND

- PERMANENT ACCESS  
 CORRIDOR (PHASE 1)  
 PERMANENT ACCESS  
 CORRIDOR (PHASE 2)  
 EXISTING PIPELINES  
 EXISTING WATER LINE  
 SURVEY BENCHMARK  
 INFLECTION POINT ALONG  
 ACCESS CORRIDOR PHASE  
 ACCESS CORRIDOR PHASE

MATCHLINE STA. 655+00  
SEE SHEET 301


Pipeline Corridor Layout Sheets (2 of 7)

PROJECT NO.

155455


SHEET NO.  
303

MATCHLINE STA. 845+00  
SEE SHEET 304

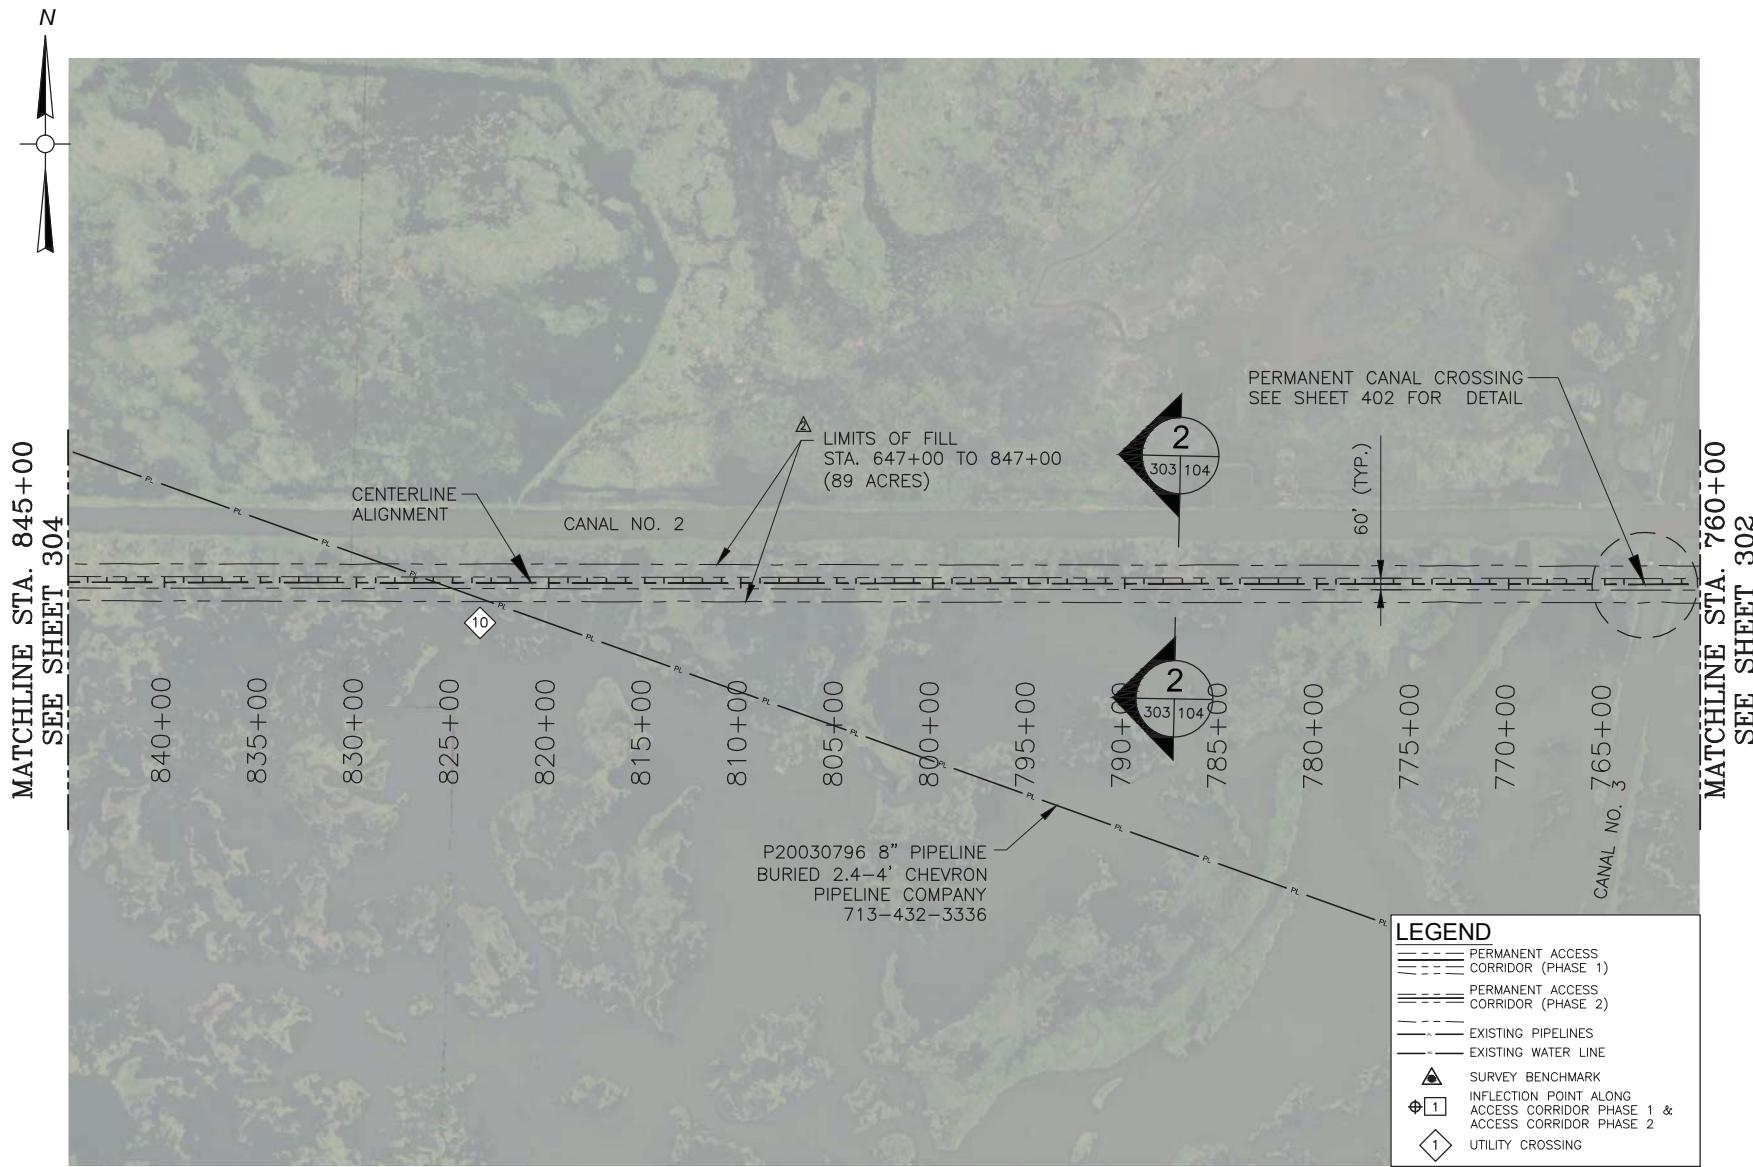

**NOTE:**  
SEE SHEET 006 FOR IMAGERY DISCLAIMER CITATION PROVIDED BY  
THE REGIONAL PLANNING COMMISSION AND THE UNITED STATES  
DEPARTMENT OF AGRICULTURE (USDA).

## Pipeline Corridor Layout

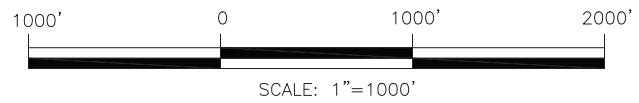

APTIM  
THE METAIRIE CENTRE  
2024 EDENBOROUGH AVE.  
SUITE 450  
METAIRIE, LA 70001 504.832.4878

07/25/18 REVISED CITATION & ADDED ACRES SPL  
03/16/18 PERMIT PLANS RE-ISSUED SPL  
NO. DATE REVISION DESCRIPTION BY


LONG DISTANCE SEDIMENT PIPELINE  
WEST OF BARATARIA WATERWAY  
PIPELINE CORRIDOR LAYOUT  
SHEETS (3 OF 7)

PROJECT NO.  
153455

DATE  
MAY 2017

SHEET NO.  
303

MATCHLINE STA. 955+00  
SEE SHEET 305

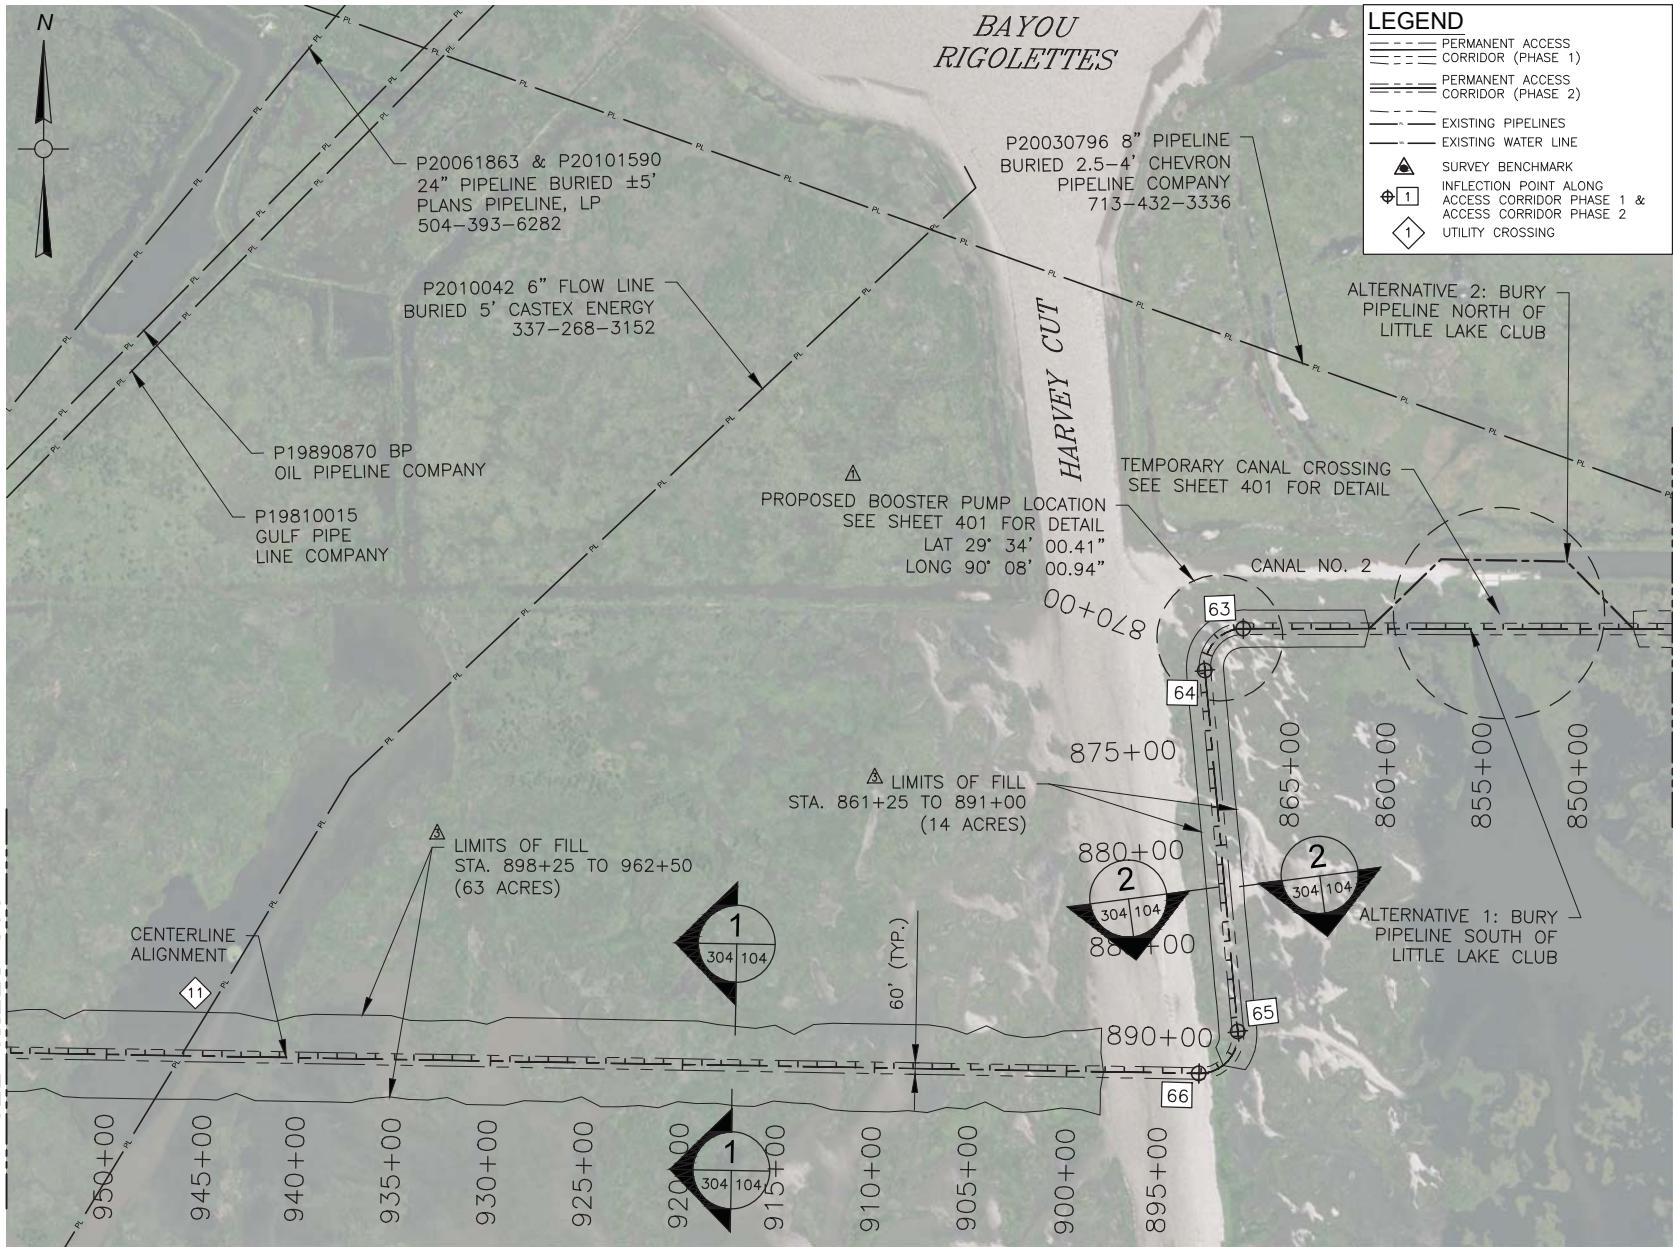

## PIPELINE CORRIDOR LAYOUT

A horizontal scale bar diagram. It features a thick black horizontal line with tick marks at both ends. Above the line, the text "1000'" is positioned above the first tick mark, "0" is centered above the midpoint, "1000'" is positioned above the second tick mark, and "2000'" is positioned above the third tick mark. Below the line, the text "SCALE: 1\"/>=1000'" is centered.

NOTE: SEE SHEET 404 FOR HARVEY CUT CROSSING.

**⚠ NOTE:**  
SEE SHEET 006 FOR IMAGERY DISCLAIMER CITATION PROVIDED BY  
THE REGIONAL PLANNING COMMISSION AND THE UNITED STATES  
DEPARTMENT OF AGRICULTURE (USDA).




Long Distance Sediment Pipeline West of Barataria Waterway	Pipeline Corridor Layout Sheets (4 of 7)
Project No. 153455	Date May 2017
Sheet No. <b>304</b>	



DESIGNED BY	SCALE	DATE	TIME	REvised CITATION & ADDED ACRES	SPL.
CHECKED BY				PERMIT PLANS RE-ISSUED	SPL.
DETAILED BY				BOoster DMP LA/ LONG	SPL.
		03/16/18			
		03/15/18			

MATCHLINE STA. 1070+00

SEE SHEET 306

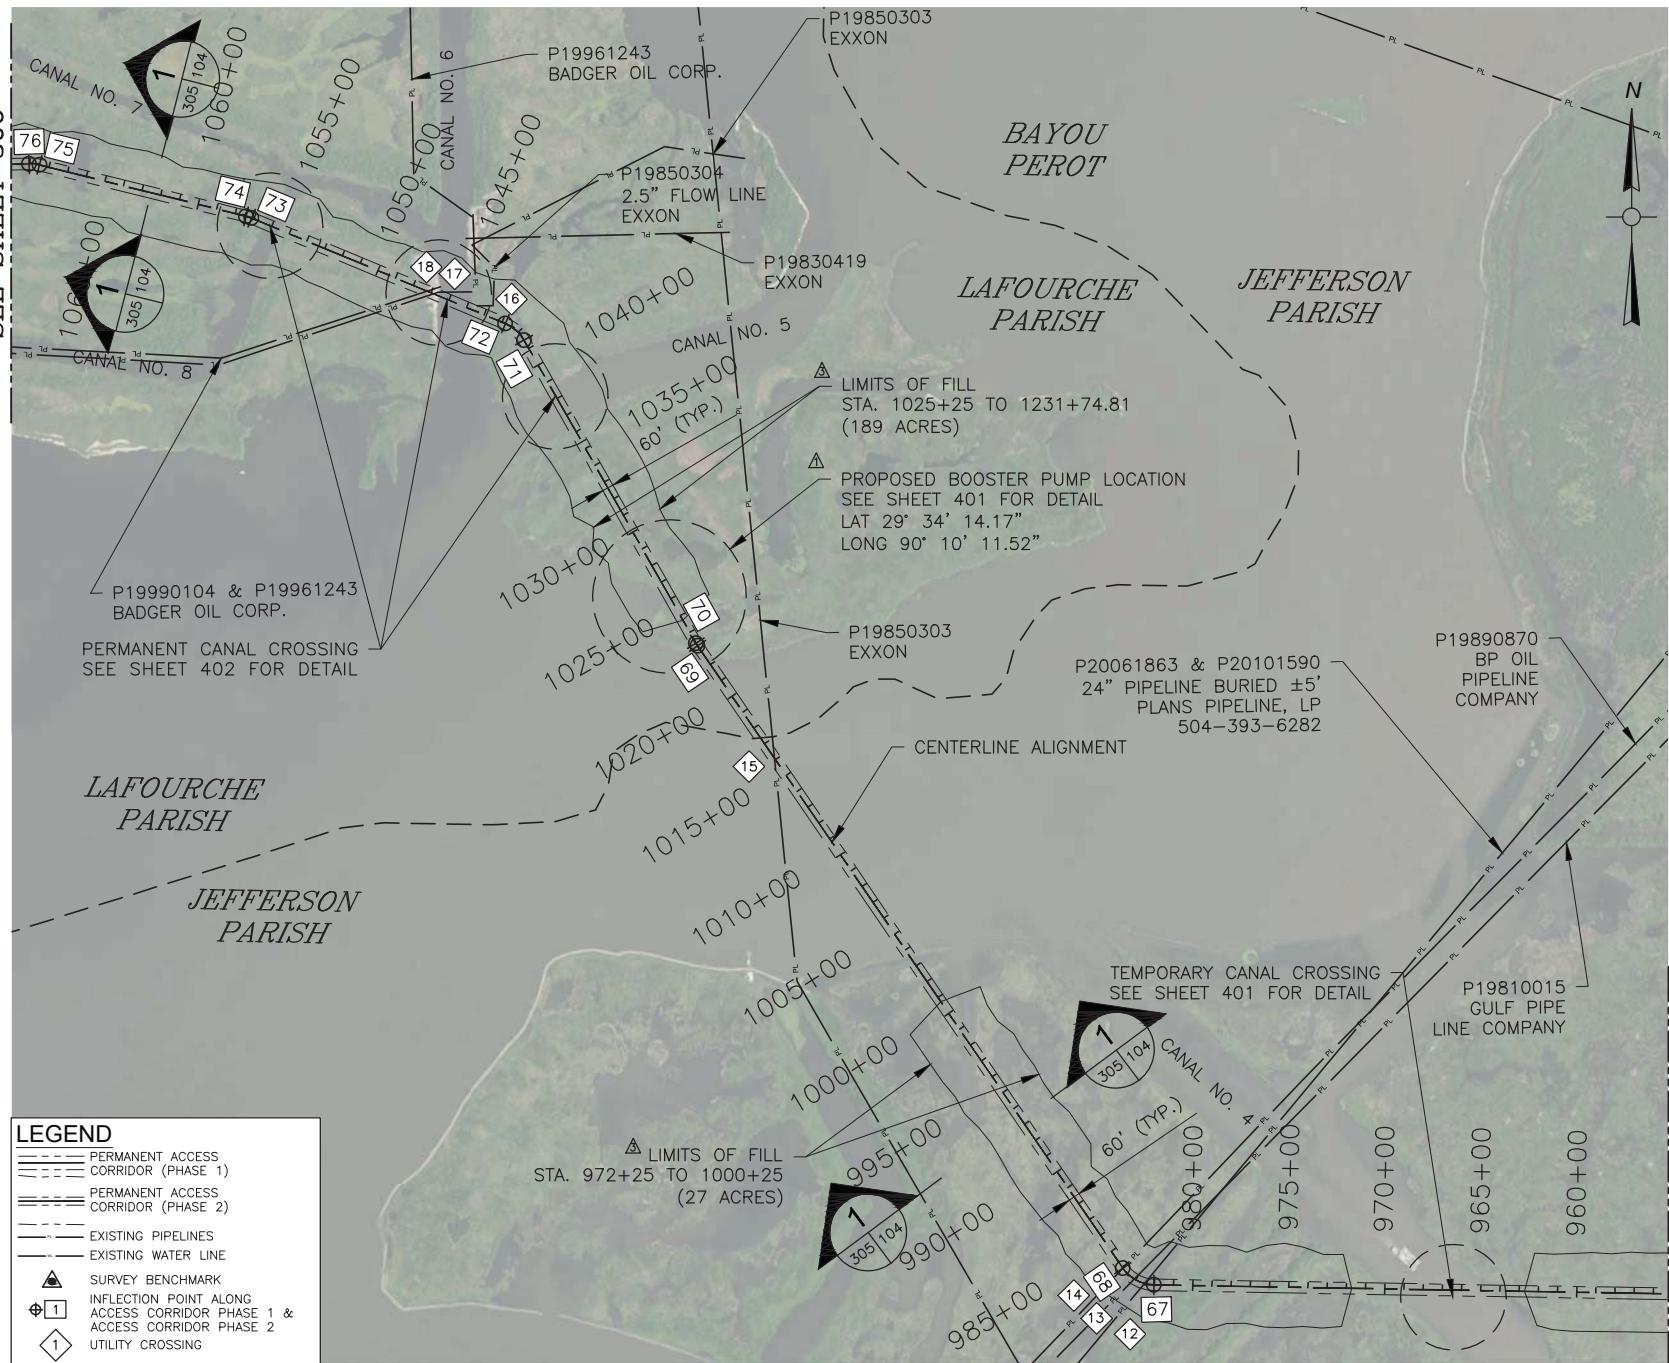

**NOTE:**  
SEE SHEET 006 FOR IMAGERY DISCLAIMER CITATION PROVIDED BY  
THE REGIONAL PLANNING COMMISSION AND THE UNITED STATES  
DEPARTMENT OF AGRICULTURE (USDA).



07/25/18 REVISED CITATION & ADDED ACRES  
03/16/18 PERMIT PLANS RE-ISSUED  
03/15/18 BOOSTER PUMP LAT/LONG  
NO. DATE REVISION DESCRIPTION BY

DESIGNED	SCALE	CHECKED	DATE	TIME

THE METAIRIE CENTRE  
2024 EDENBORG AVENUE  
SUITE 460  
METAIRIE, LA 70001 504.832.4878

**APTIM**


LONG DISTANCE SEDIMENT PIPELINE  
WEST OF BARATARIA WATERWAY  
PIPELINE CORRIDOR LAYOUT  
SHEETS (5 OF 7)

PROJECT NO.  
153455  
DATE  
MAY 2017  
SHEET NO.  
305


MATCHLINE STA. 955+00  
SEE SHEET 304

**AIMS Group, Inc.**  
Consulting Engineers  
4421 Zenith Street  
Metairie, LA 70001  
Ph. 504.887.7045  
Fax. 504.887.7088

MATCHLINE STA. 1180+00  
SEE SHEET 307

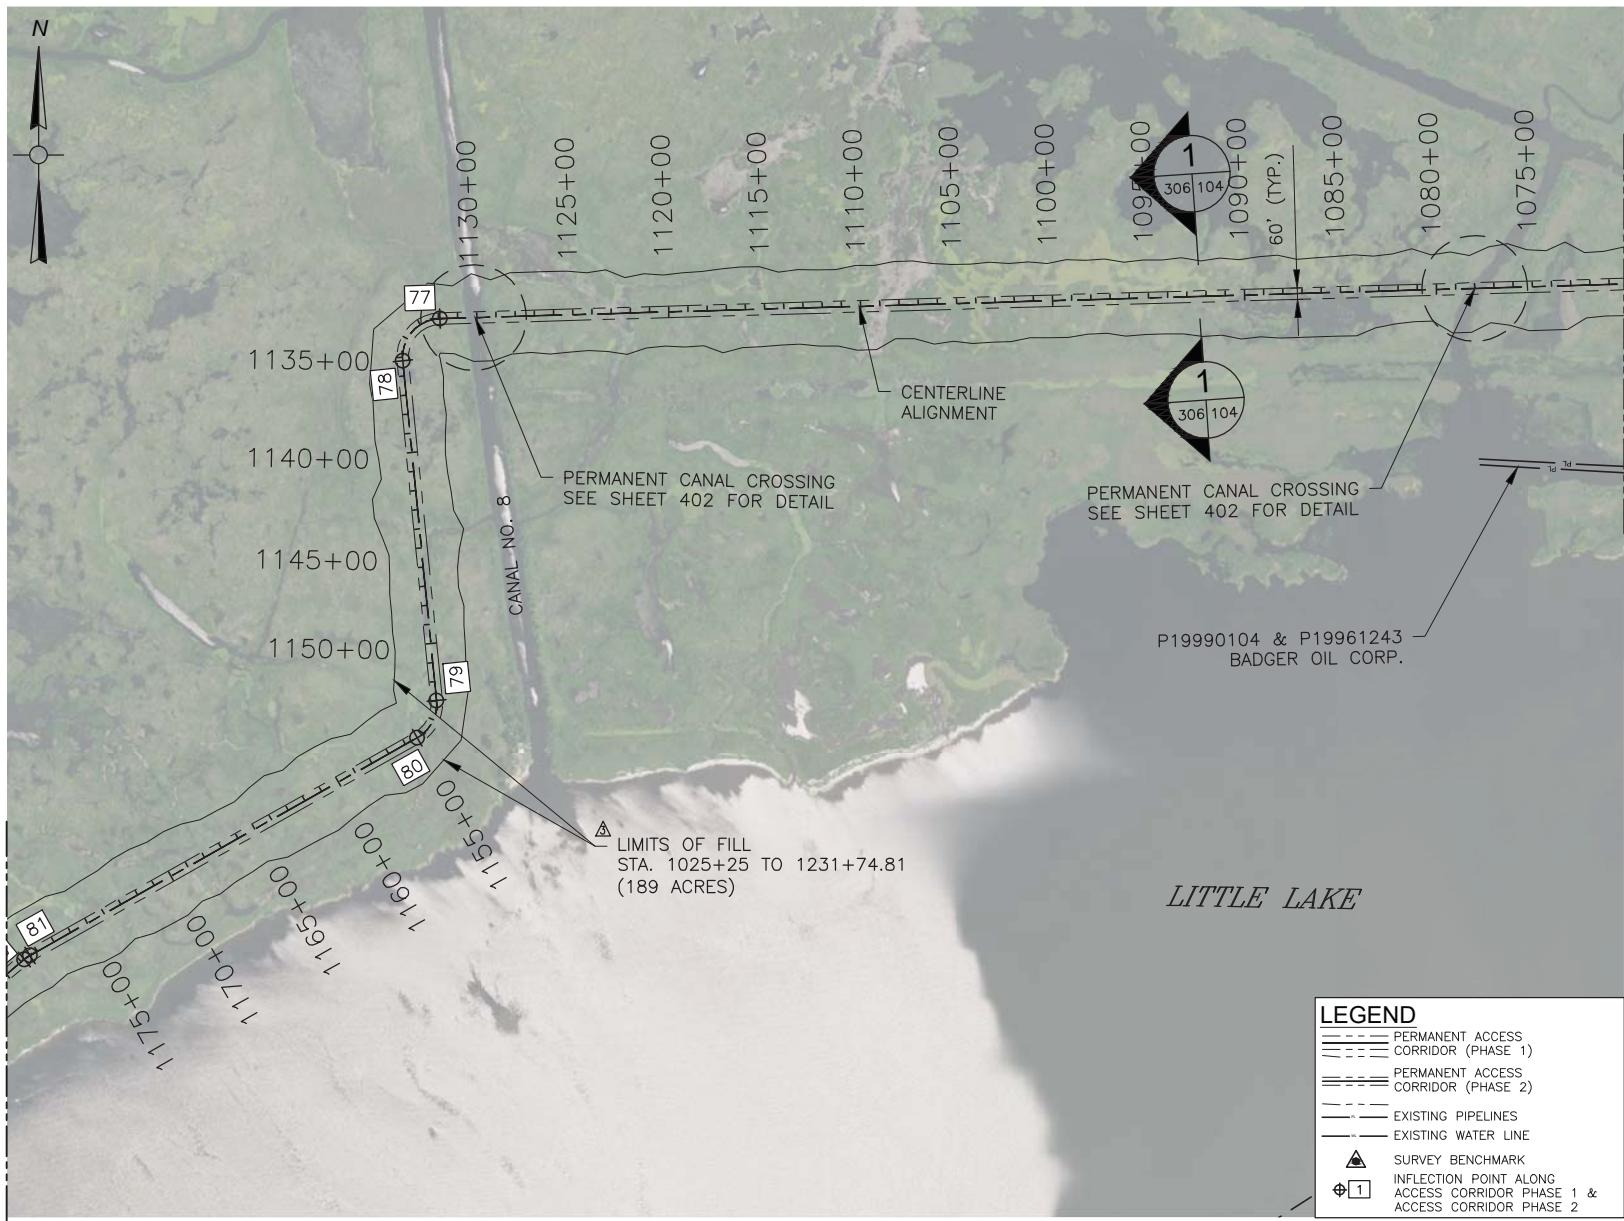


## PIPELINE CORRIDOR LAYOUT

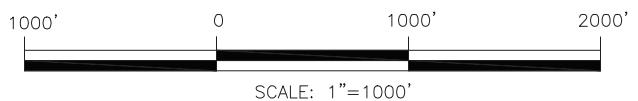

LONG DISTANCE SEDIMENT PIPELINE WEST OF BARATARIA WATERWAY	PROJECT NO. 153455
Pipeline Corridor Layout Sheets (6 of 7)	DATE May 2017
	SHEET NO. 306


&lt;/

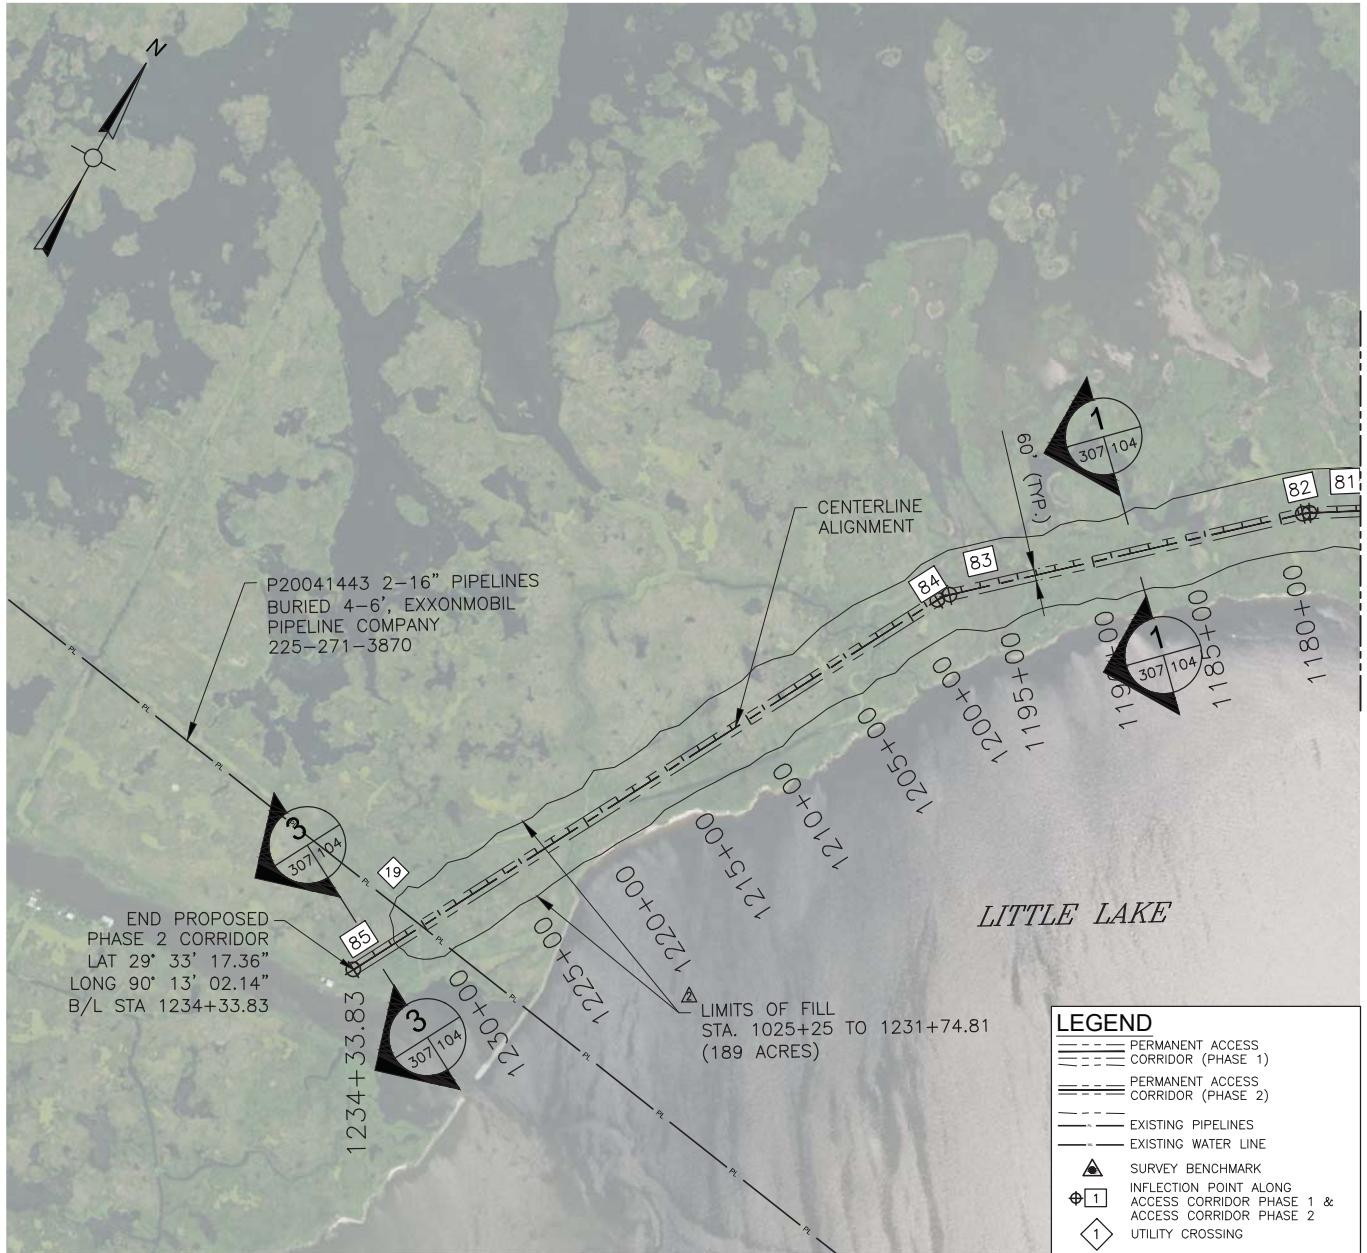


## PIPELINE CORRIDOR LAYOUT

1000' 0 1000' 2000'  
SCALE: 1"=1000'

<b>APTIM</b> THE METAIRIE CENTRE 2024 EDENBORO AVE. SUITE 450 METAIRIE, LA 70001 504.832.4878			
DESIGNED	SCALE	07/25/18	REVISED CITATION & ADDED ACRES SPL
CHECKED		03/16/18	PERMIT PLANS RE-ISSUED SPL
DETAILED	DATE	NO. DATE	REVISION DESCRIPTION SPL
	TIME		
 <b>AIMS Group, Inc.</b> Consulting Engineers 4421 Zenith Street Metairie, LA 70001 Ph. 504.887.7045 Fax 504.887.7088			
LONG DISTANCE SEDIMENT PIPELINE WEST OF BARATARIA WATERWAY		PIPELINE CORRIDOR LAYOUT SHEETS (7 OF 7)	
PROJECT NO. 153455		DATE MAY 2017	
SHEET NO. 307			

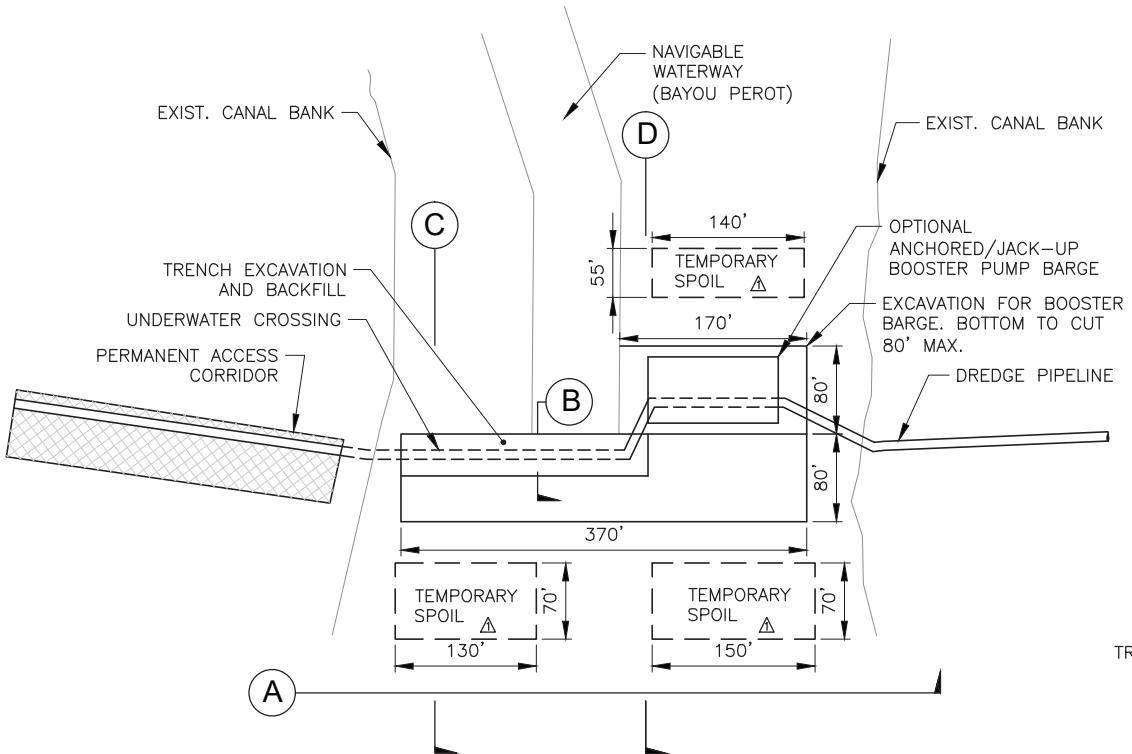


**TEMPORARY CANAL CROSSING (BURIED)**

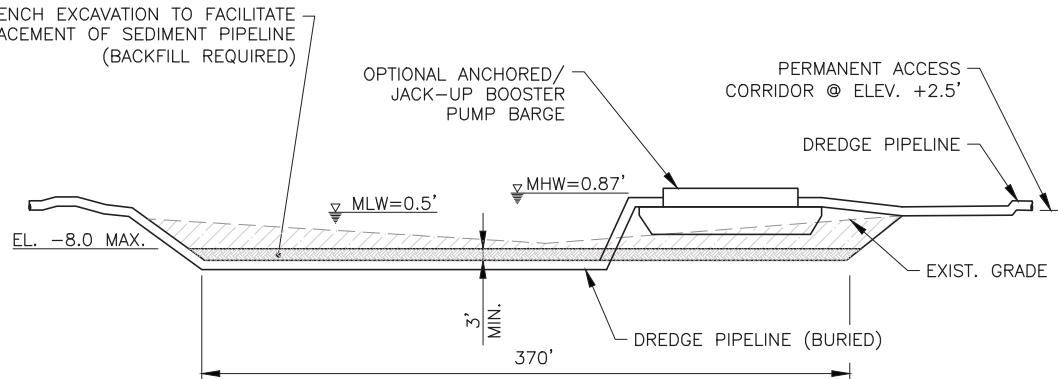


# CROSS SECTION


N.T.S.

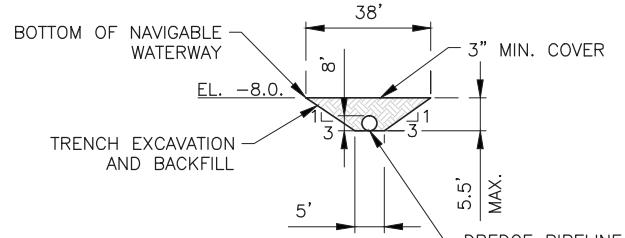

**TRENCH DETAIL** **N.T.S.** **B**

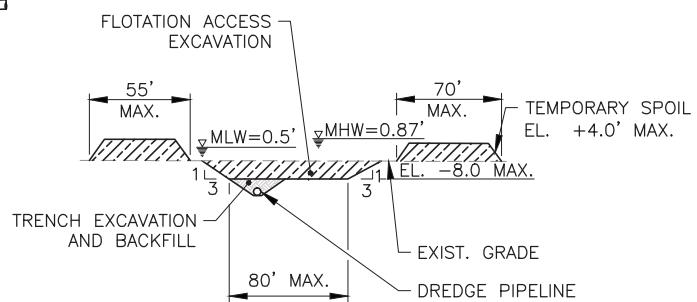

**CROSS SECTION**   
N.T.S.

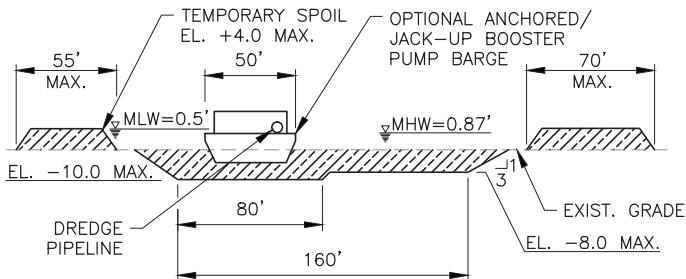

CROSS SECTION N.T.S. D



**SPL**  
**SPL**  
**BY**



YLINE  
YIED)

LONG DISTANCE SEDIMENT PIPE  
WEST OF BARATARIA WATERWAY



TEMPORARY CANAL CROSSING (BUR)

PROJECT NO.  
153455  
DATE  
MAY 2017  
SHEET NO.  
401





AIMS Group, Inc.  
Consulting Engineers  
1 Zenith Street      Ph. 504.887.7045  
Bain, LA 70001      Fax. 504.887.7088

Engineers  
Ph. 504.887.7045  
Fax. 504.887.7088

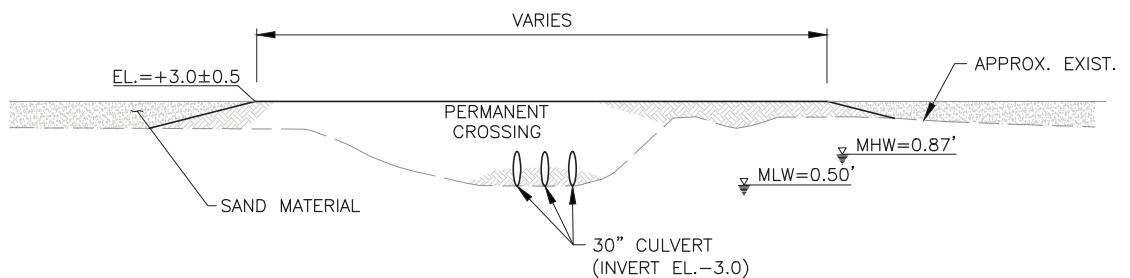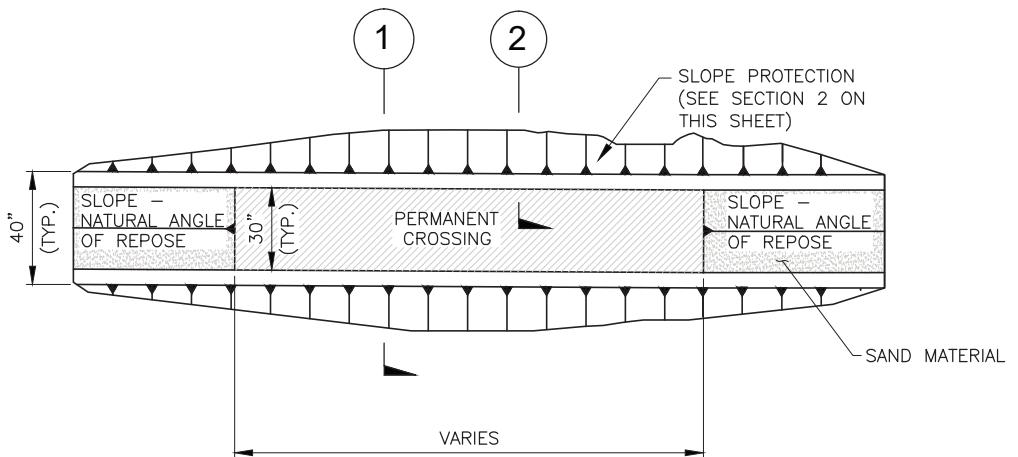


## PERMANENT CANAL CROSSING DETAILS

N.T.S.

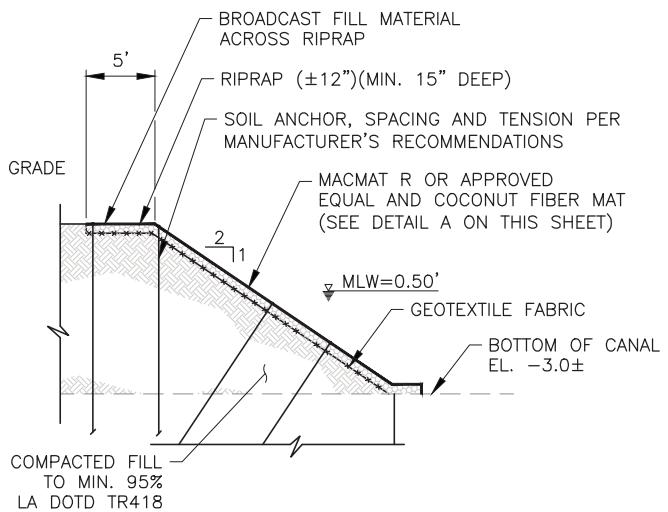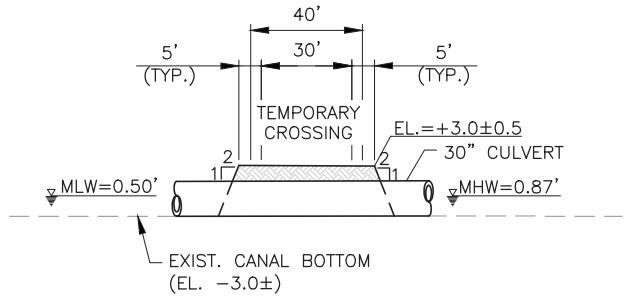

		PROJECT NO. 153455	
		DATE MAY 2017	
		SHEET NO. 402	
		LONG DISTANCE SEDIMENT PIPELINE WEST OF BARATARIA WATERWAY	
		PERMANENT CROSSING DETAIL	
		APTIM THE METAIRIE CENTRE SUITE 460 METAIRIE, LA 70001 504.832.4878	
DESIGNED BY	SCALE	DATE 03/16/18	PERMIT PLANS RE-ISSUED NO. DATE
CHECKED BY	TIME	REVISION DESCRIPTION SPL BY	

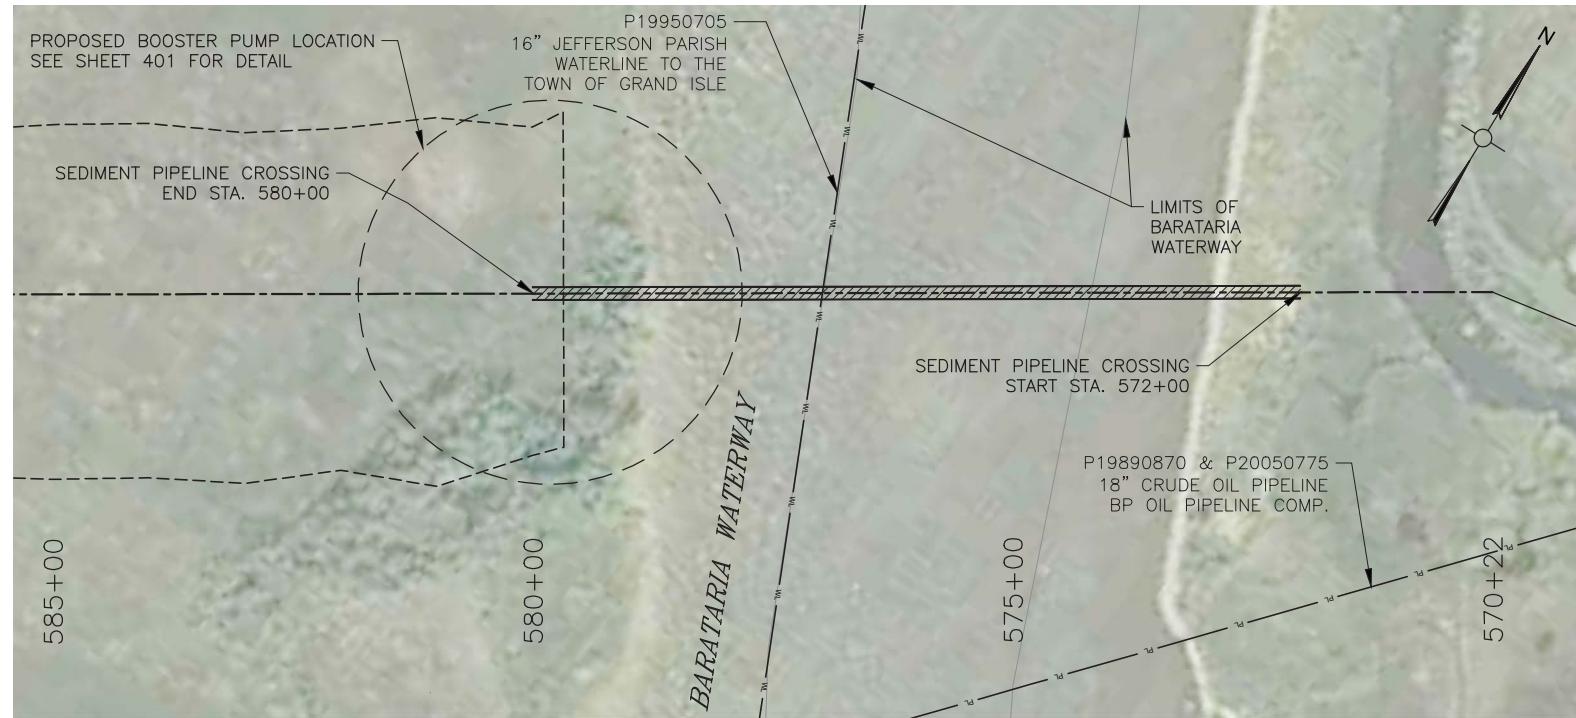


DESIGNED	SCALE		
CHECKED			
DETAILED			
DATE			
TIME			
A 03/16/18		PERMIT PLANS RE-ISSUED	SP1
		NO. DATE	REVISION DESCRIPTION



504.832.4878



APTIM

LONG DISTANCE SEDIMENT PIPELINE WEST OF BARATARIA WATERWAY	CROSSING DETAIL - BARATARIA TEMPORARY
PROJECT NO.	153455
DATE	MAY 2017
SHEET NO.	403

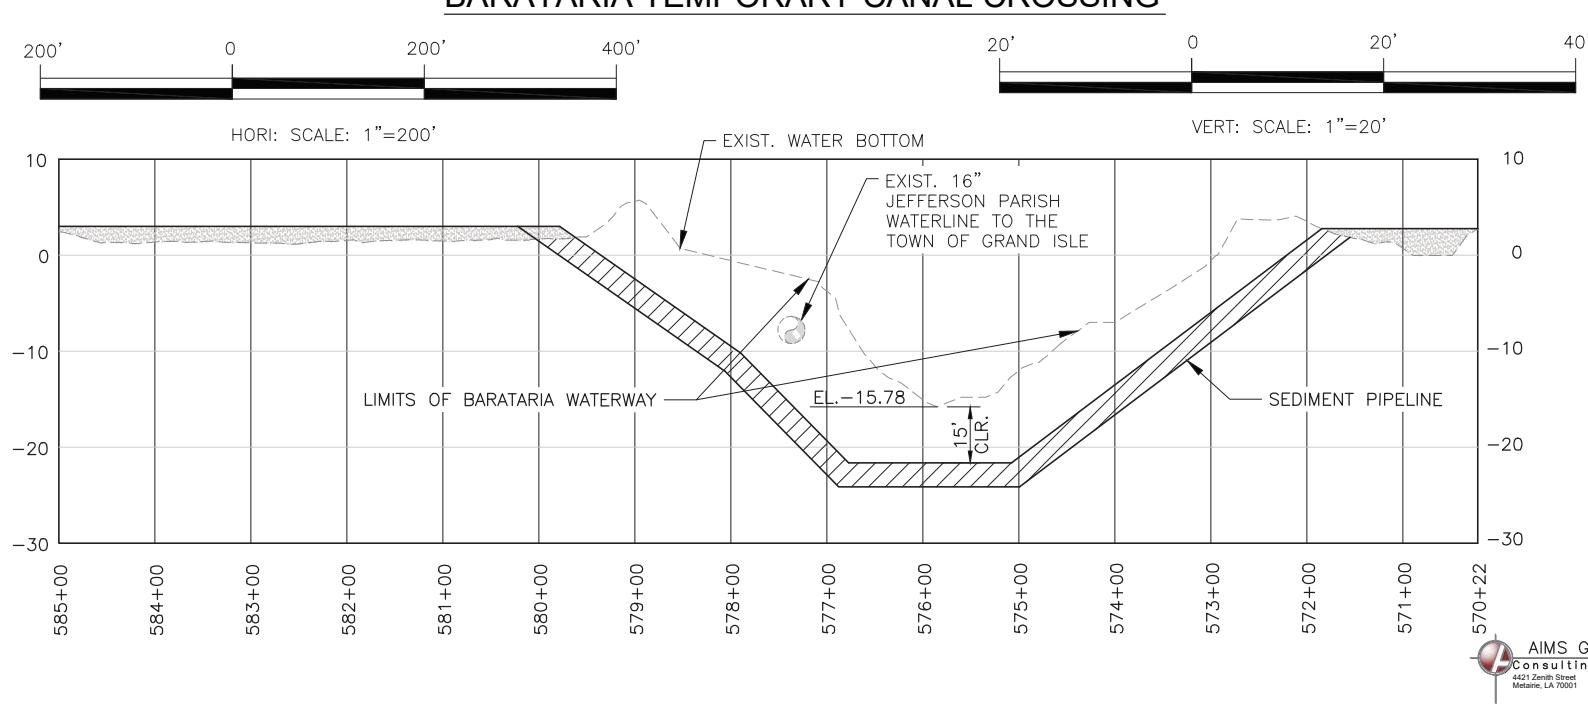

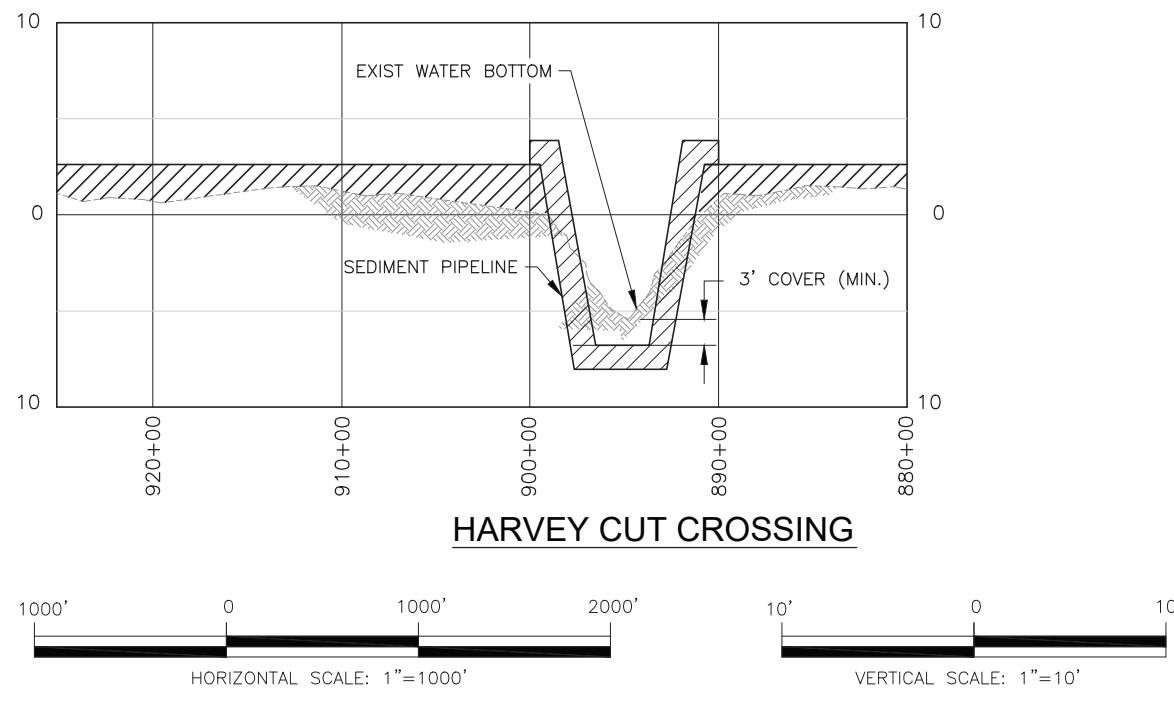
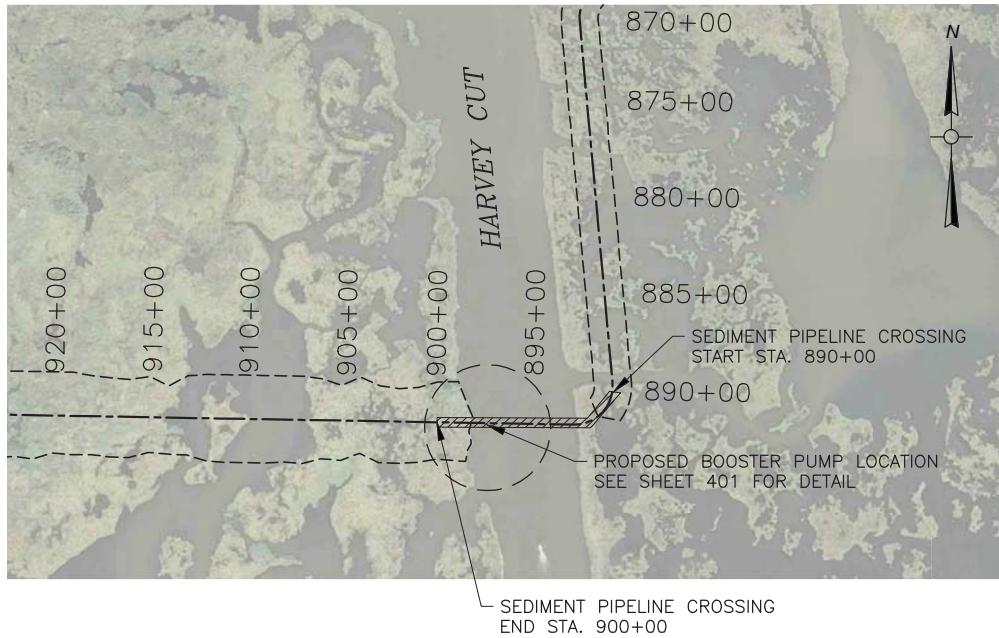


 **AIMS Group, Inc.**  
Consulting Engineers

4421 Zenith Street  
Metairie, LA 70001  
Ph. 504.887.7045  
Fax. 504.887.7088

<b>LONG DISTANCE SEDIMENT PIPELINE</b>		<b>WEST OF BARATARIA WATERWAY</b>	
<b>CROSSING DETAIL - HARVEY CUT</b>			
<b>PROJECT NO.</b>	153455		
<b>DATE</b>	MAY 2017		
<b>SHEET NO.</b>	404		
<b>DESIGNED</b>	<b>SCALE</b>	<b>PERMIT PLANS RE-ISSUED</b>	<b>SP1</b>
<b>CHECKED</b>			
<b>DETAILED</b>	<b>DATE</b>	<b>NO. DATE</b>	<b>REVISION DESCRIPTION</b>
<b>CHECKED</b>	<b>TIME</b>		


**APTIM**  
THE METAIRIE CENTRE  
2024 EDENBORO AVE.  
SUITE 460  
METAIRIE, LA 70001 504.832.4878

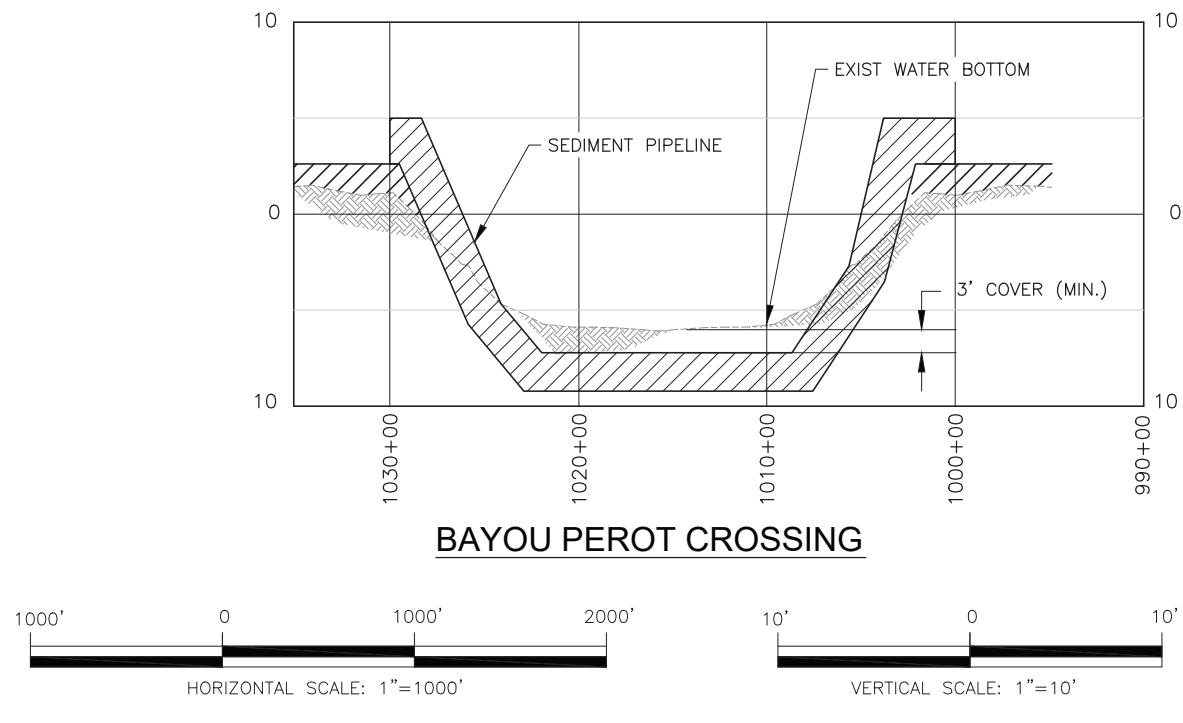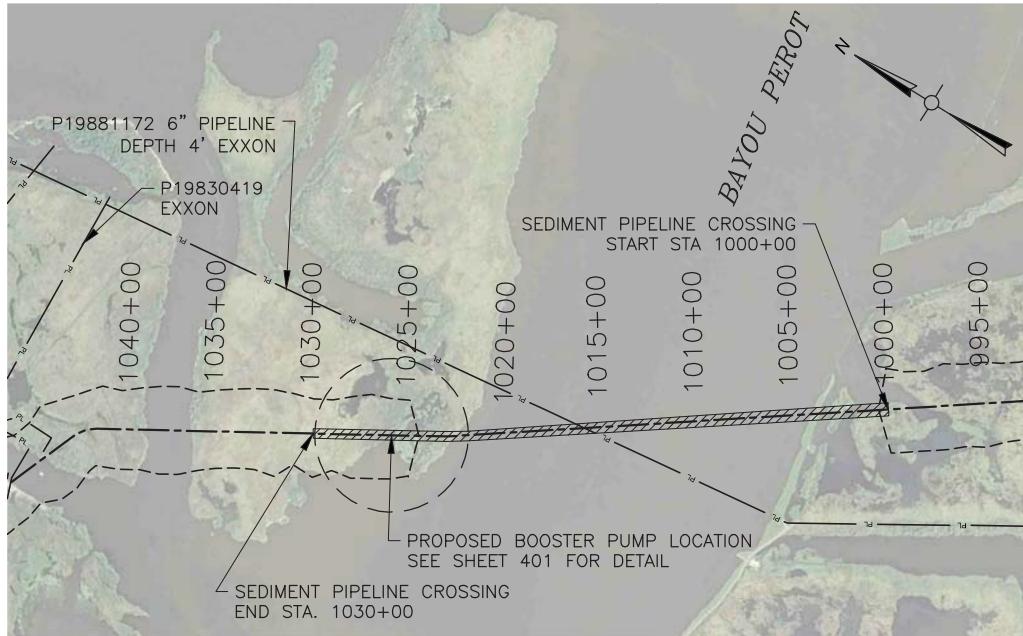

<b>LONG DISTANCE SEDIMENT PIPELINE</b>	
<b>WEST OF BARATARIA WATERWAY</b>	
<b>CROSSING DETAIL - BAYOU PEROT</b>	
PROJECT NO.	153455
DATE	MAY 2017
SHEET NO.	405
DESIGNED	SCALE
CHECKED	
DETAILED	DATE
CHECKED	TIME
A 03/16/18 PERMIT PLANS RE-ISSUED	
NO. DATE	REVISION DESCRIPTION
BY	

**APTIM**  
THE METAIRIE CENTRE  
2024 EDENBORO AVE.  
SUITE 460  
METAIRIE, LA 70001 504.832.4878

**APTIM**

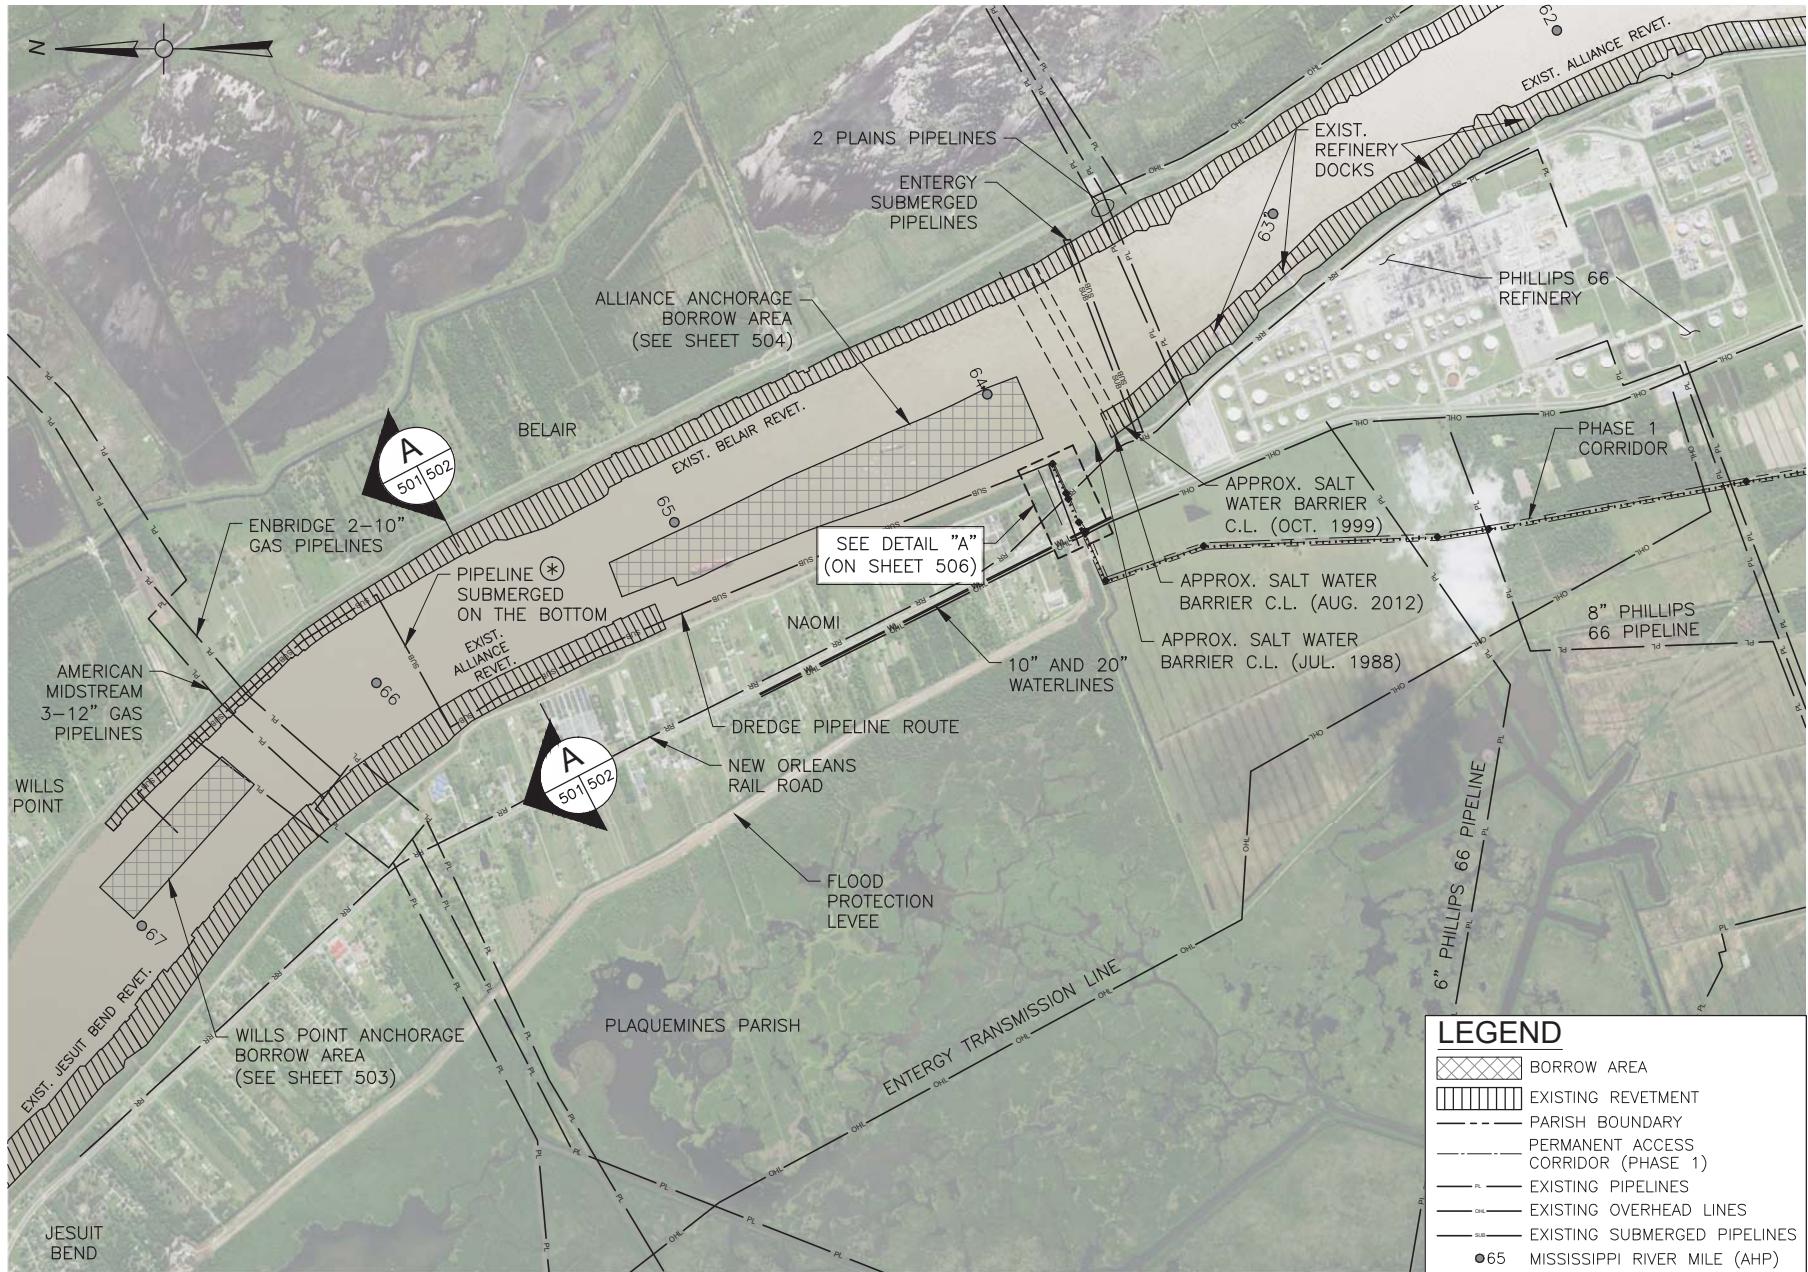

**NOTE:**  
CONTRACTOR TO PROVIDE CROSS SECTION  
OF RIVER PRIOR TO INSTALLATION FOR APPROVAL.

## BORROW AREAS

3,000' 1,500' 0 3,000' 6,000'  
SCALE: 1"=3,000'

**NOTE:**  
SEE SHEET 006 FOR IMAGERY DISCLAIMER CITATION PROVIDED BY  
THE REGIONAL PLANNING COMMISSION AND THE UNITED STATES  
DEPARTMENT OF AGRICULTURE (USDA).



APTIM  
Long Distance Sediment Pipeline  
West of Barataria Waterway

Project No. 153455  
Date May 2017  
Sheet No. 501


07/25/18 ADDED PIPELINE NOTE  
07/25/18 CITATION NOTE REVISION  
03/16/18 PERMIT PLANS RE-ISSUED

No. Date Revision Description

## LEGEND

- BORROW AREA
- EXISTING REVETMENT
- PARISH BOUNDARY
- PERMANENT ACCESS CORRIDOR (PHASE 1)
- EXISTING PIPELINES
- EXISTING OVERHEAD LINES
- EXISTING SUBMERGED PIPELINES
- MISSISSIPPI RIVER MILE (AHP)

LONG DISTANCE SEDIMENT PIPELINE  
WEST OF BARATARIA WATERWAY  
BORROW AREAS

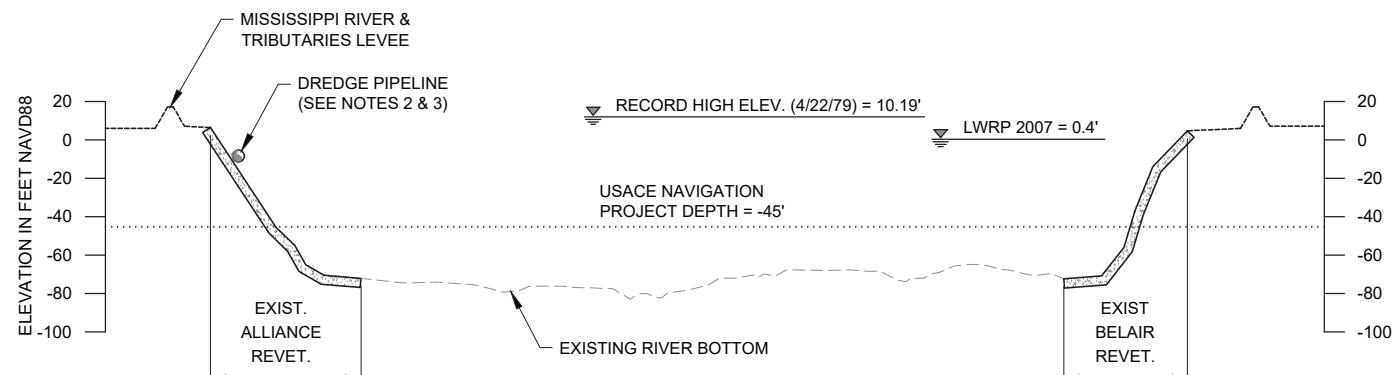


A  
501502

### TYPICAL DREDGE PIPELINE ROUTE SECTION

RIVER MILE 65.6

NOTES:

1. MISSISSIPPI RIVER BOTTOM PROFILE BASED ON OSI SURVEY DATED AUGUST 17, 2011.
2. DREDGE PIPELINE TO BE ROUTED ALONG RIVER BANK AT AN OFFSET 30 FT. MINIMUM FROM THE LWRP.
3. DREDGE PIPELINE MAY BE SUBMERGED OR FLOATING.

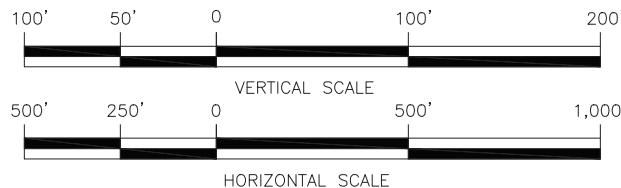

### LEGEND

- AUGUST 2011 SURVEY (dashed line)
- EXISTING REVETMENT (solid line)
- DREDGE PIPELINE (circle)



DESIGNED	SCALE	PERMIT PLANS RE-ISSUED
CHECKED	DATE	NO. DATE
DETAILED	TIME	REVISION DESCRIPTION
CHECKED		SP/ BY

**APTIM**  
THE METairie CENTRE  
2024 EDENBORO AVE.  
SUITE 450  
METairie, LA 70001 504.832.4878

**APTIM**

LONG DISTANCE SEDIMENT PIPELINE  
WEST OF BARATARIA WATERWAY

PROJECT NO.  
153455

DATE  
MAY 2017


SHEET NO.  
502

Ph. 504.887.7045  
Fax. 504.887.7088




BORROW AREA (TOP OF CUT)		
PT.	EASTING	NORTHING
1	3,707,219.41	446,014.82
2	3,707,522.21	445,208.58
3	3,707,389.03	445,148.38
4	3,707,535.24	444,787.54
5	3,707,753.86	444,338.67
6	3,708,221.68	443,197.83
7	3,708,374.70	442,776.59
8	3,708,765.43	441,617.89
9	3,709,691.75	439,435.96
10	3,710,654.49	439,851.98
11	3,710,479.21	440,313.58
12	3,710,215.12	440,847.15
13	3,710,024.70	441,265.93
14	3,709,790.84	441,838.96
15	3,709,723.64	441,987.70
16	3,709,471.22	442,546.40
17	3,709,080.21	443,441.64
18	3,708,739.13	444,118.08
19	3,708,370.45	444,880.29
20	3,708,087.76	445,497.48
21	3,707,751.08	446,217.16

BUOYS MARKING DREDGE ANCHOR LIMIT		
PT.	EASTING	NORTHING
A	3,707,815.11	446,375.28
B	3,710,813.77	439,784.64

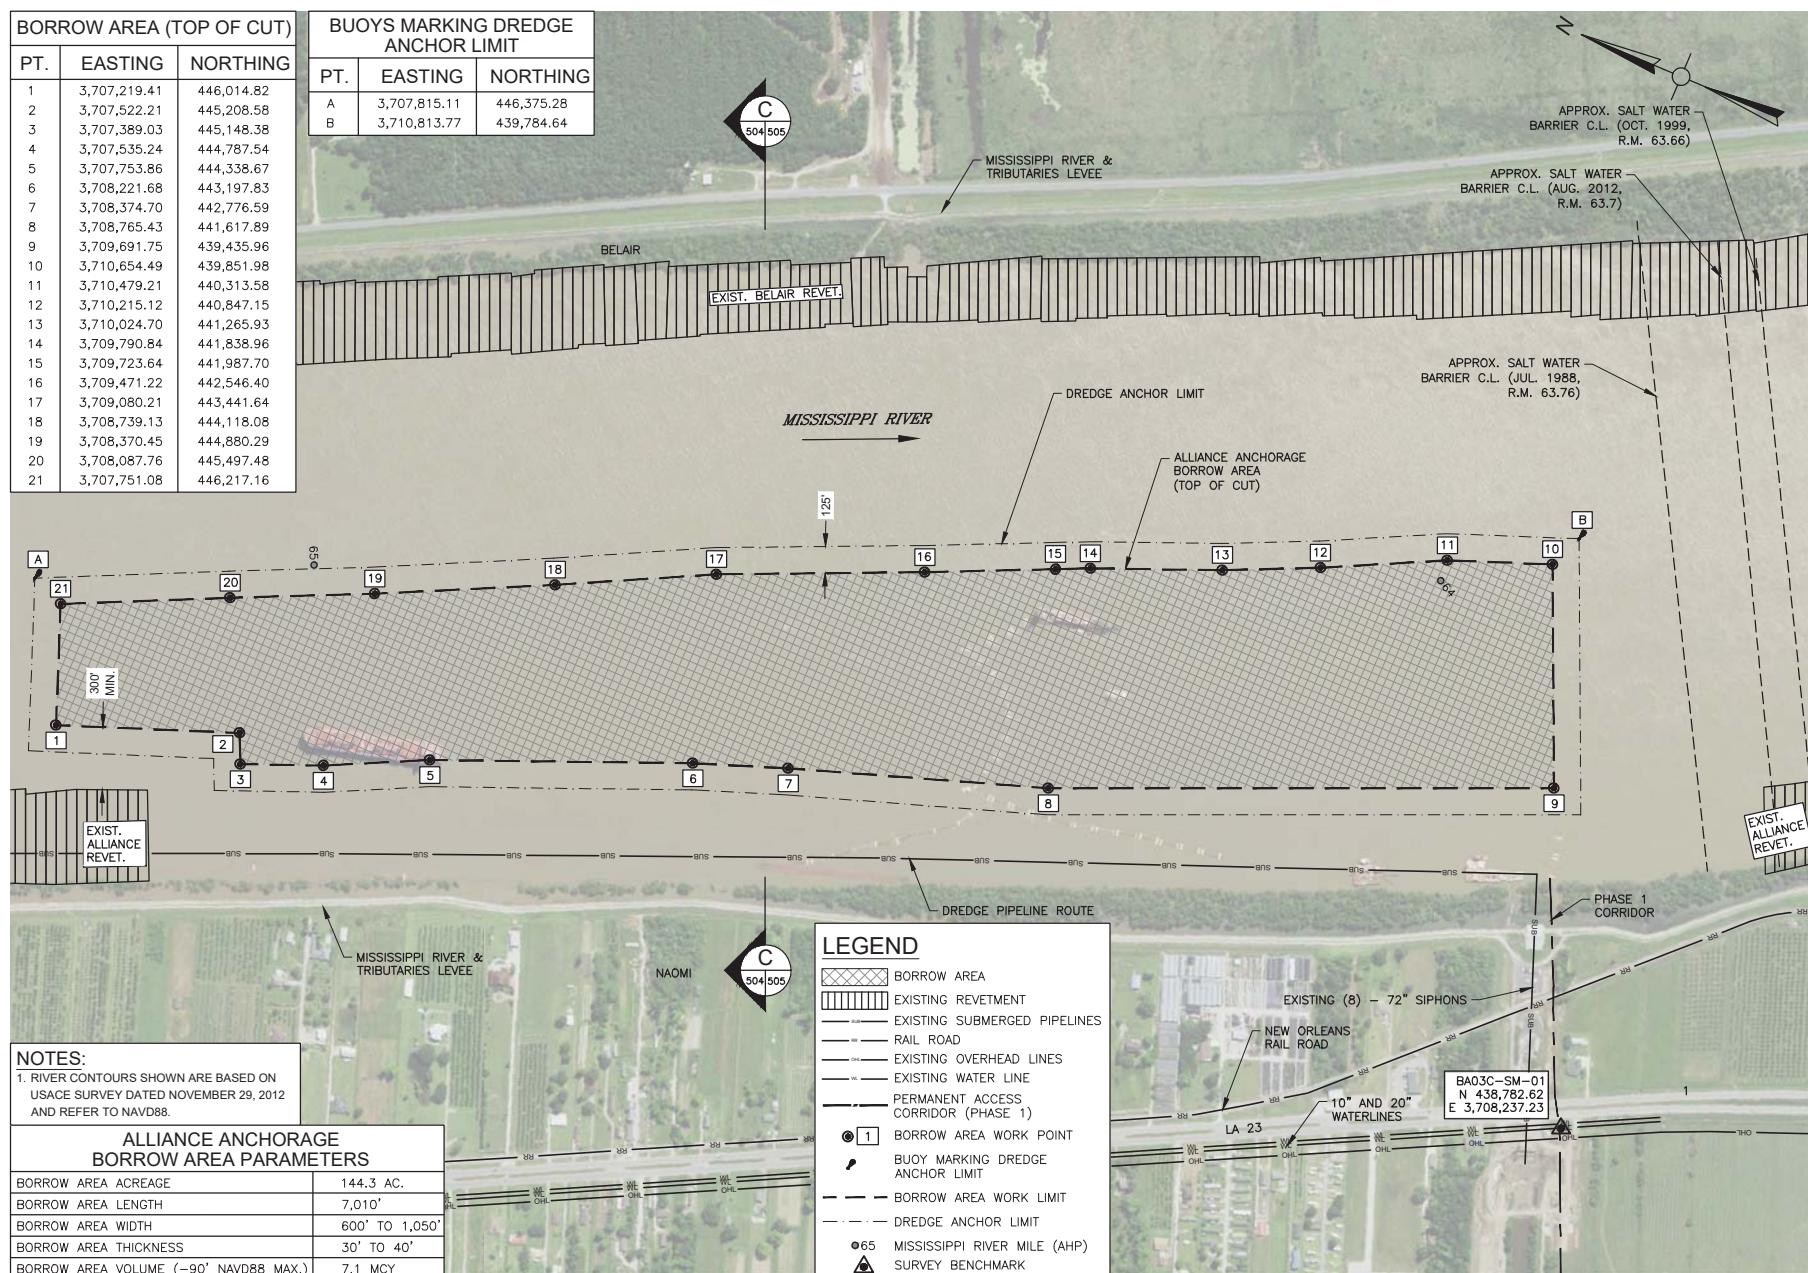

**NOTE:**  
SEE SHEET 006 FOR IMAGERY DISCLAIMER CITATION PROVIDED BY THE REGIONAL PLANNING COMMISSION AND THE UNITED STATES DEPARTMENT OF AGRICULTURE (USDA).

## ALLIANCE ANCHORAGE BORROW AREA LAYOUT

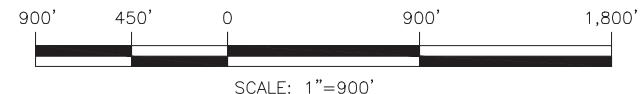


DESIGNED	SCALE	SPL.
CHECKED	DATE	SPL.
DETAILED	TIME	BY
07/25/18 CITATION NOTE REVISION 03/16/18 PERMIT PLANS RE-ISSUED		
NO. DATE REVISION DESCRIPTION		


DESIGNED	SCALE	SPL.
CHECKED	DATE	SPL.
DETAILED	TIME	BY



LONG DISTANCE SEDIMENT PIPELINE WEST OF BARATARIA WATERWAY	ALLIANCE ANCHORAGE BORROW AREA LAYOUT
PROJECT NO.	153455
DATE	MAY 2017
SHEET NO.	504

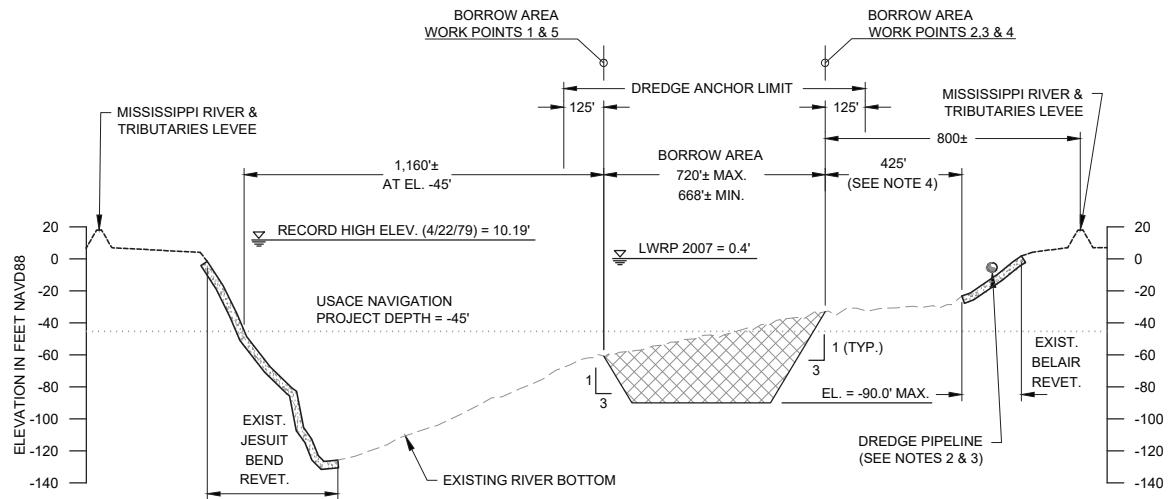

**B** WILLS POINT ANCHORAGE BORROW AREA  
503 505 RIVER MILE 66.7

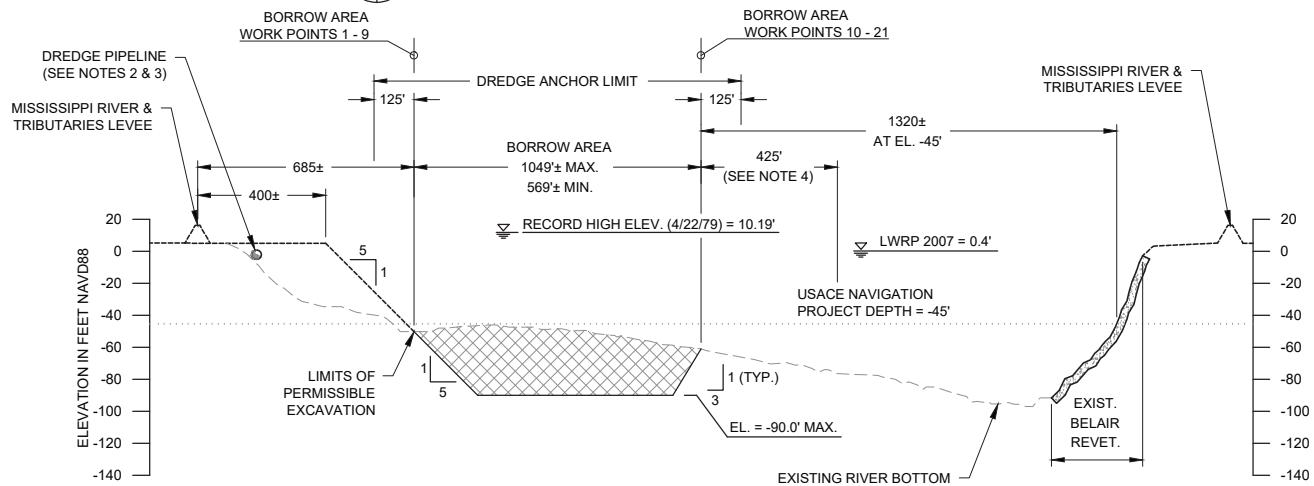

 ALLIANCE ANCHORAGE BORROW AREA  
504 | 505 RIVER MILE 64.6

## LEGEND

BORROW AREA

----- AUGUST 2011 SURVEY

----- APPROXIMATE EXISTING

EXISTING REVENUE      DESIGN GRADE

ADE

120' 60' 0 120' 240' 600' 300' 0 600' 1,200'

VERTICAL SCALE

HORIZONTAL SCALE

## **NOTES:**

1. MISSISSIPPI RIVER BOTTOM PROFILE BASED ON OSI SURVEY DATED AUGUST 17, 2011.
  2. DREDGE PIPELINE TO BE ROUTED ALONG RIVER BANK AT AN OFFSET ±30 FT. MINIMUM FROM THE LWVR.
  3. DREDGE PIPELINE MAY BE SUBMERGED OR FLOATING.
  4. THE MINIMUM DISTANCE BETWEEN TOP OF CUT AND TOE OF BELAIR REVETMENT VARIES FROM 300 TO 450 FT.
  5. THE MINIMUM DISTANCE BETWEEN TOP OF CUT AND TOE OF ALLIANCE REVETMENT IS 300 FT. WHERE OCCURS, SEE SHEET 50A FOR EXTENTS.



**AIMS Group, Inc.**  
**Consulting Engineer**  
4421 Zenith Street Ph. 504.887.7041  
Metairie, LA 70001 Fax. 504.887.7084







**LONG DISTANCE SEDIMENT PIPELINE  
WEST OF BARATARIA WATERWAY**


**BORROW AREAS TYPICAL SECTIONS**

PROJECT NO.  
153455  
DATE  
MAY 2017  
SHEET NO.  
505

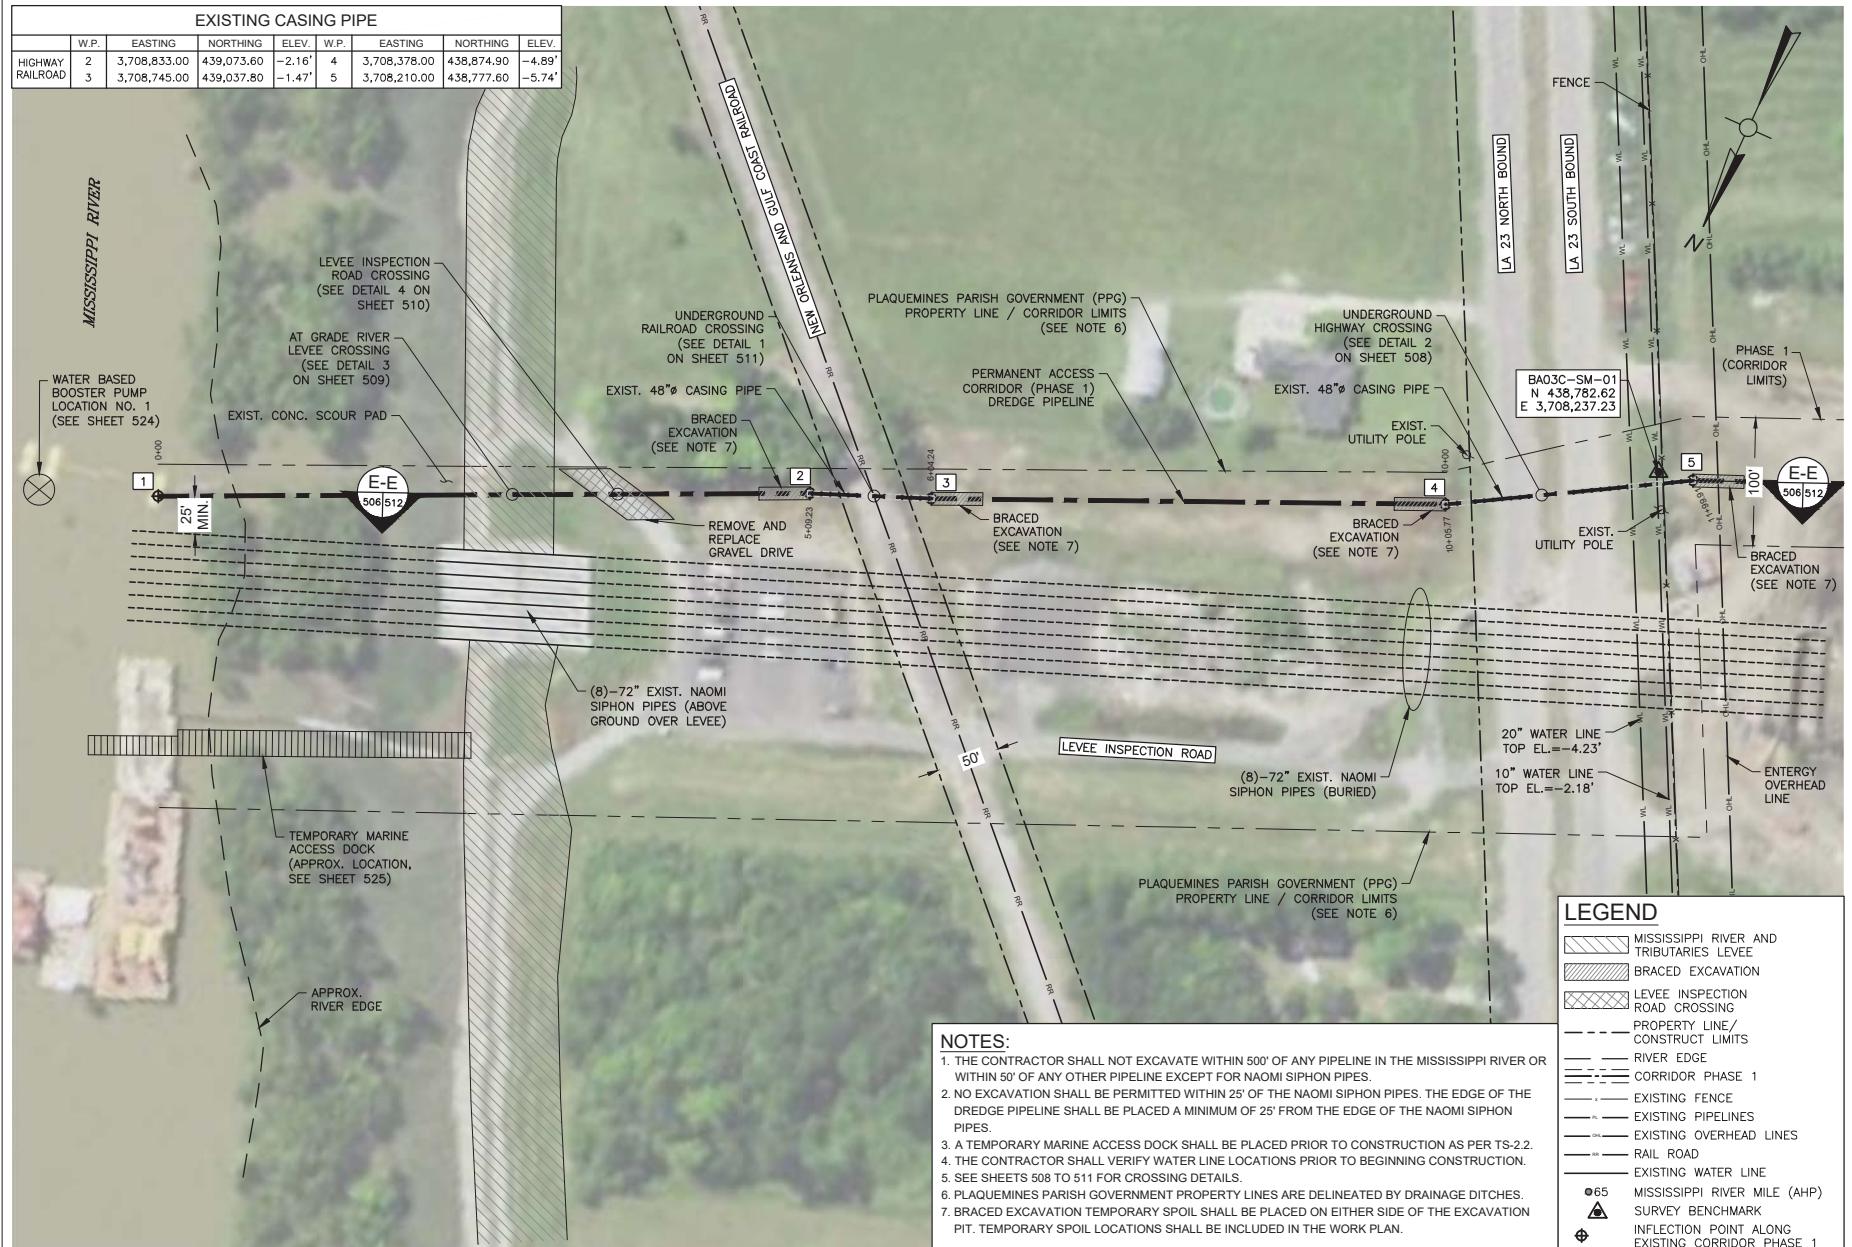

**NOTE:**  
SEE SHEET 006 FOR IMAGERY DISCLAIMER CITATION PROVIDED BY  
THE REGIONAL PLANNING COMMISSION AND THE UNITED STATES  
DEPARTMENT OF AGRICULTURE (USDA).

## DETAIL "A"

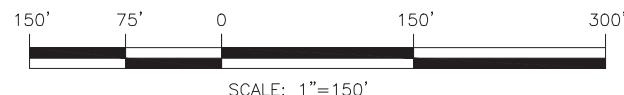


LONG DISTANCE SEDIMENT PIPELINE	
WEST OF BARATARIA WATERWAY	
PROJECT NO.	153455
DATE	MAY 2017
SHEET NO.	506



DESIGNED	SCALE	CHECKED	DETAILED	DATE	TIME	SPL	SPL	BY
				07/25/18	CITATION NOTE REVISION			
				03/16/18	PERMIT PLANS RE-ISSUED			

ELEVATION IN FEET NAVD88

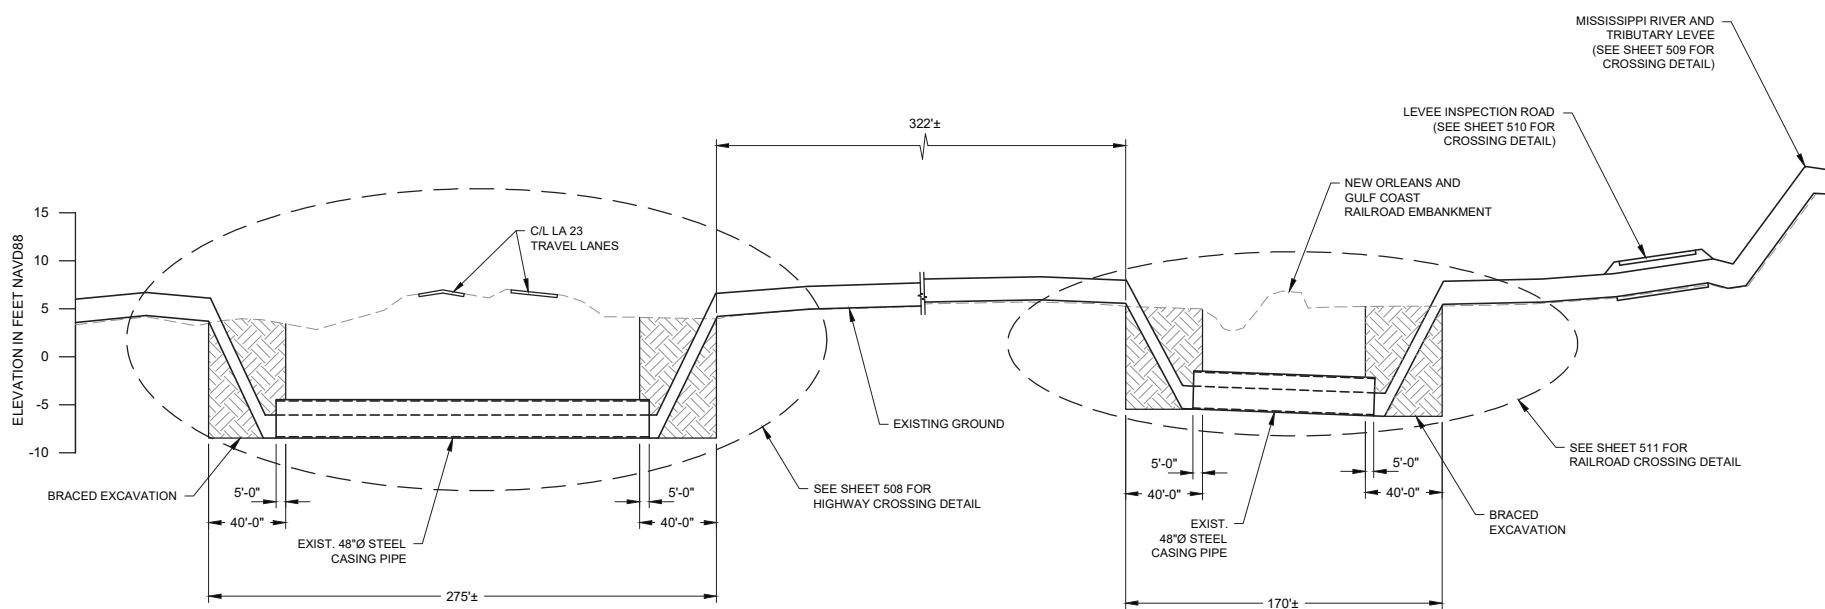E-E  
506507

## DREDGE PIPELINE CORRIDOR SECTION

## LEGEND

- BRACED EXCAVATION
- EXISTING GROUND

20' 10' 0 20' 40' 100' 50' 0 100' 200'

VERTICAL SCALE

HORIZONTAL SCALE

AIMS Group, Inc.  
Consulting Engineers  
4421 Zenith Street  
Metairie, LA 70001  
Ph. 504.887.7045  
Fax. 504.887.7088




DESIGNED	SCALE	DATE	PERMIT PLANS RE-ISSUED
CHECKED		TIME	NO. DATE
DETAILED			REVISION DESCRIPTION
		A 03/16/18	

DESIGNED	SCALE	DATE	PERMIT PLANS RE-ISSUED
CHECKED		TIME	NO. DATE
DETAILED			REVISION DESCRIPTION

**APTIM**  
THE METAIRIE CENTRE  
2024 EDENBORO LANE  
SUITE 450  
METAIRIE, LA 70001 504.832.4878

LONG DISTANCE SEDIMENT PIPELINE WEST OF BARATARIA WATERWAY	DREDGE PIPELINE CORRIDOR SECTION
PROJECT NO.	153455
DATE	MAY 2017
SHEET NO.	507

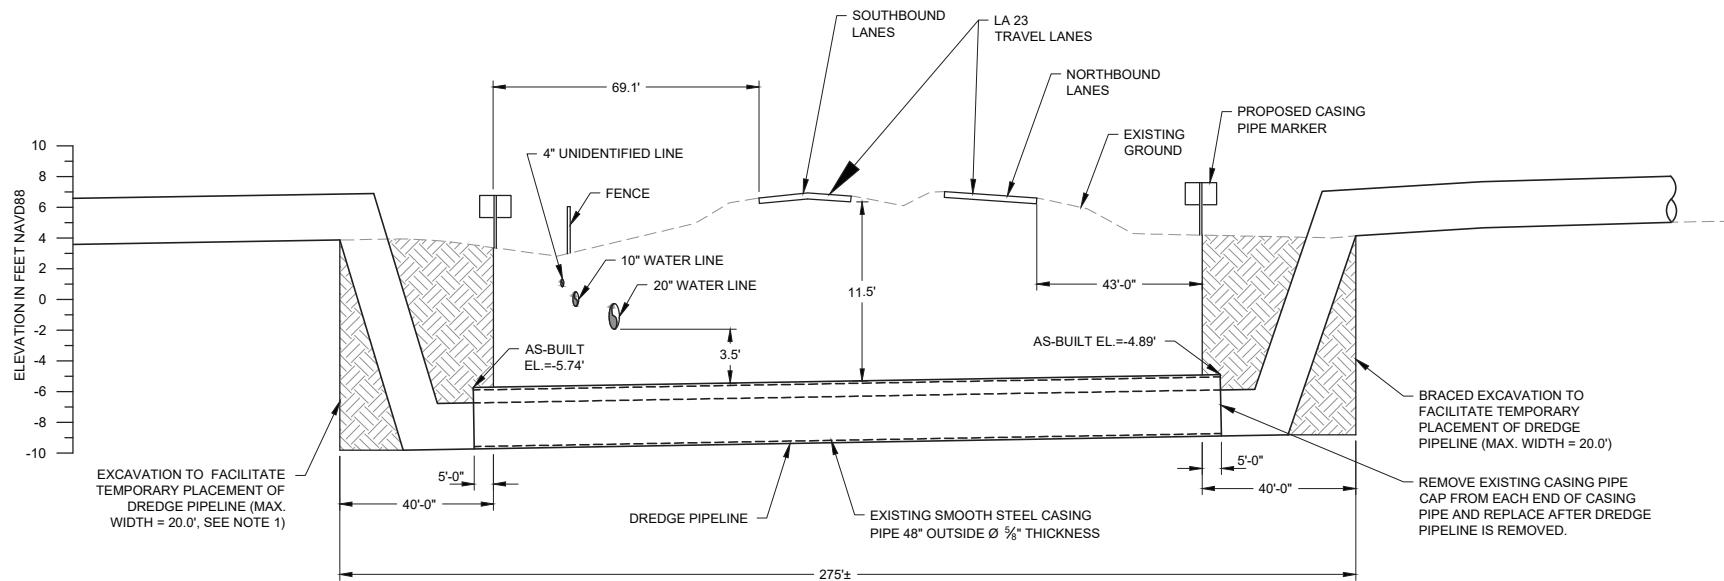

## NOTES:

1. TEMPORARY SPOIL SHALL BE PLACED ADJACENT TO THE EXCAVATION ON BOTH SIDES WITHIN CONSTRUCTION LIMITS. LOCATION TO BE APPROVED BY ENGINEER AND INCLUDED IN WORK PLAN.
2. THE TEMPORARY SPOIL SHALL BE BACKFILLED INTO EXCAVATION AFTER COMPLETION OF CONSTRUCTION.

2  
506508

## HIGHWAY CROSSING DETAIL





DESIGNED	SCALE	DATE	PERMIT PLANS RE-ISSUED
CHECKED			
DETAILED			
CHECKED			
		TIME	NO. DATE
			REVISION DESCRIPTION
			SP. BY

**APTIM**  
THE METAIRIE CENTRE  
2024 EDENBOROUGH AVE.  
SUITE 450  
METAIRIE, LA 70001 504.832.4878

**APTIM**

LONG DISTANCE SEDIMENT PIPELINE WEST OF BARATARIA WATERWAY	HIGHWAY CROSSING DETAIL
PROJECT NO.	153455
DATE	MAY 2017
SHEET NO.	508

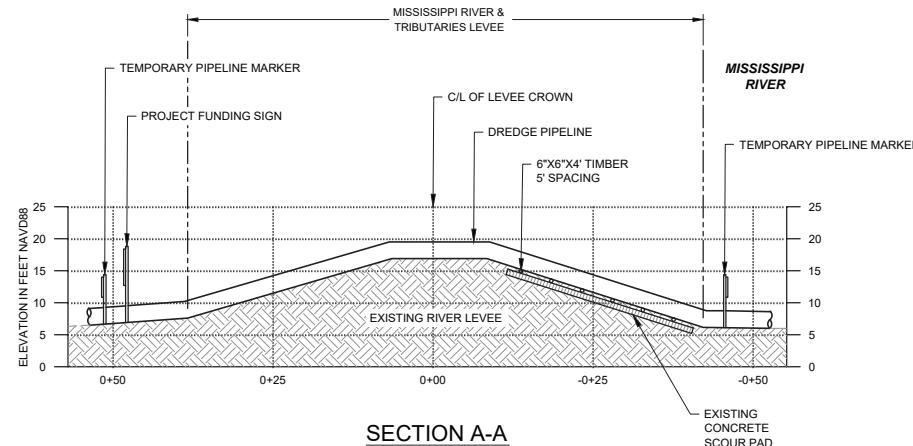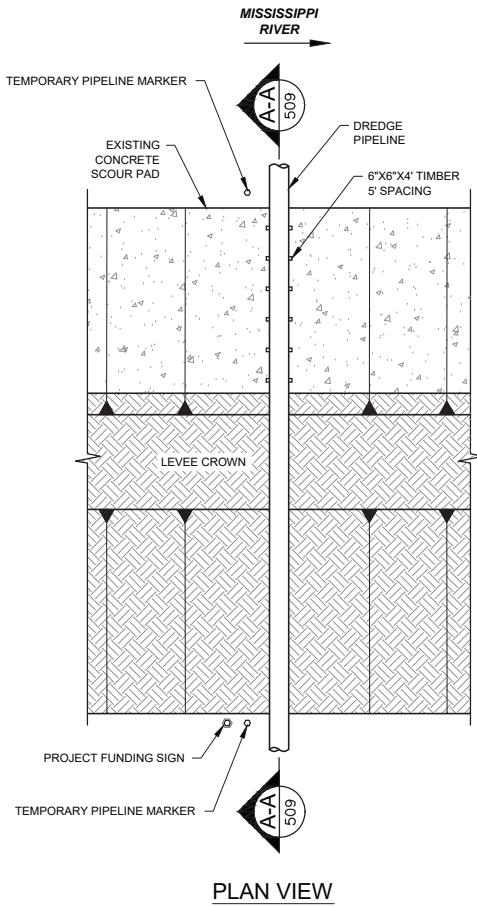NOTES:

1. TEMPORARY PIPELINE MARKERS INDICATING OWNER, CONTENTS, AND ADDRESS FOR CONTACTING OWNER SHALL BE PLACED AND MAINTAINED AT EACH TOE OF LEVEE NEAR DREDGE PIPELINE. LOCATION TO BE APPROVED BY ENGINEER AND INCLUDED IN WORK PLAN.
2. EXISTING GRADE BASED ON JANUARY 2012 TBS SURVEY.

3  
506 509

MISSISSIPPI RIVER LEVEE CROSSING DETAIL

30' 15' 0 30' 60'  
SCALE: 1"=30'

AIMS Group, Inc.  
Consulting Engineers  
4421 Zenith Street  
Metairie, LA 70001  
Ph. 504.887.7045  
Fax. 504.887.7088






LONG DISTANCE SEDIMENT PIPELINE	PERMIT PLANS RE-ISSUED
WEST OF BARATARIA WATERWAY	DATE
MISSISSIPPI RIVER LEVEE	NO. DATE
CROSSING DETAIL	REVISION DESCRIPTION
SP1	
A 03/16/18	
DETAILED TIME	
CHECKED	
DESIGNED	SCALE
CHECKED	DATE
DETAILED	TIME
CHECKED	DATE

**APTIM**  
THE METAIRIE CENTRE  
2024 LEDGERBORG AVENUE  
SUITE 450  
METAIRIE, LA 70001 504.832.4878

**APTIM**  
Consulting Engineers

PROJECT NO. 153455  
DATE MAY 2017  
SHEET NO. 509

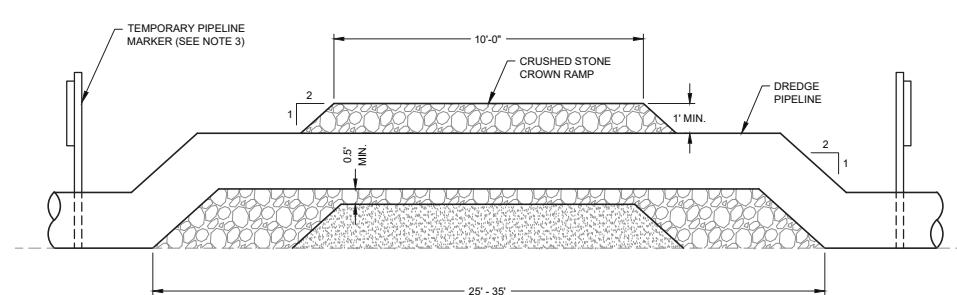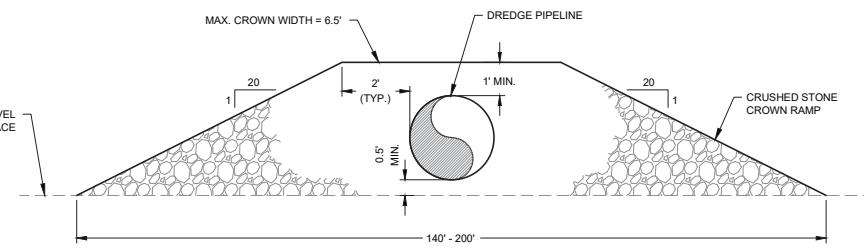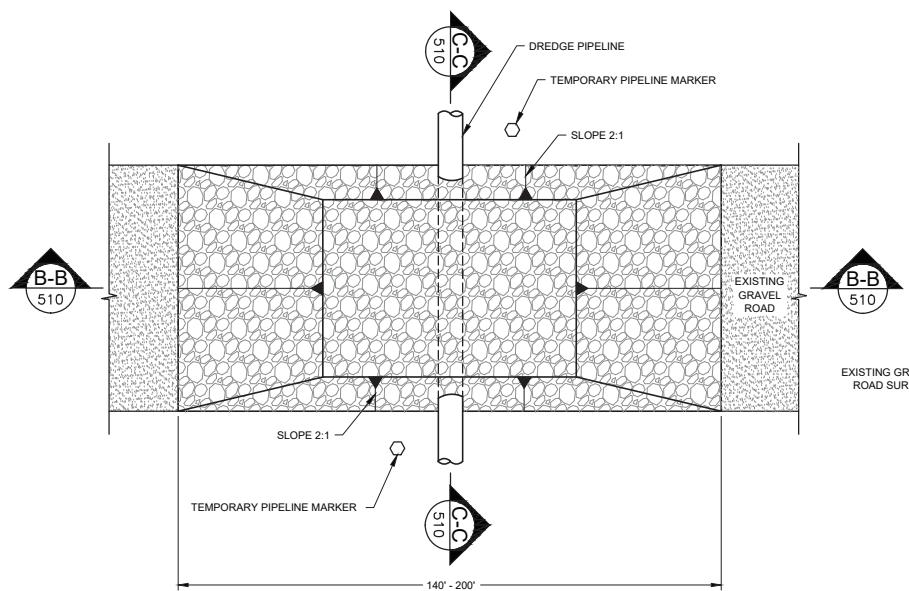NOTES:

- MISSISSIPPI RIVER LEVEE INSPECTION ROAD IS AT THE LANDSIDE TOE OF THE MISSISSIPPI RIVER LEVEE.
- THE CROWN RAMP OVER THE PIPELINE CROSSINGS SHALL CONSIST OF CRUSHED STONE FOR FULL WIDTH AND LENGTH OF RAMP. THE CRUSH STONE MATERIAL SHALL CONFORM TO LA DOTD 2006 SPECIFICATION 1003.04 (a).
- TEMPORARY PIPELINE MARKERS INDICATING OWNER, CONTENTS, AND ADDRESS FOR CONTACTING OWNER SHALL BE PLACED AND MAINTAINED AT EACH TOE OF LEVEE NEAR DREDGE PIPELINE. LOCATION TO BE APPROVED BY ENGINEER AND INCLUDED IN WORK PLAN.

4  
506 510


**MISSISSIPPI RIVER LEVEE INSPECTION ROAD CROSSING DETAIL**  
NOT TO SCALE




DESIGNED	SCALE	RE-ISSUED
CHECKED	DATE	PERMIT PLANS RE-ISSUED
DETAILED	TIME	NO. DATE



LONG DISTANCE SEDIMENT PIPELINE WEST OF BARATARIA WATERWAY	LEVEE INSPECTION ROAD CROSSING DETAIL
PROJECT NO.	153455
DATE	MAY 2017
SHEET NO.	510

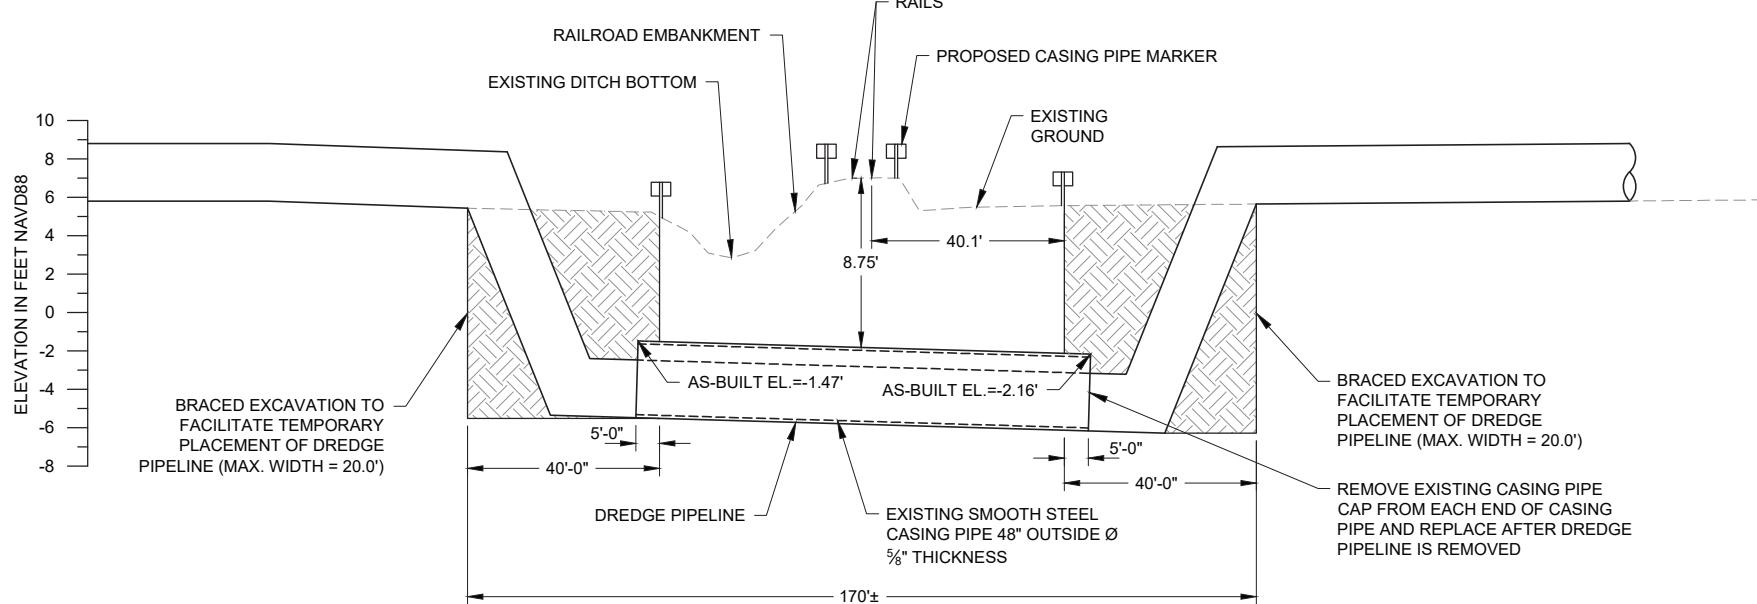1  
506511**RAILROAD CROSSING DETAIL****LEGEND**

- BRACED EXCAVATION**: Shaded area.
- EXISTING GROUND**: Dashed line.

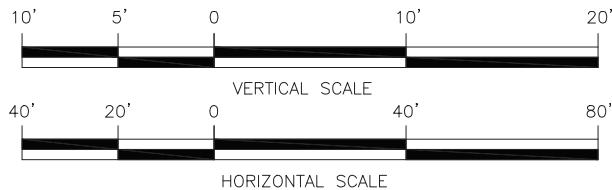**NOTES:**



1. TEMPORARY SPOIL SHALL BE PLACED ADJACENT TO THE EXCAVATION ON BOTH SIDES. LOCATION TO BE APPROVED BY ENGINEER AND INCLUDED IN WORK PLAN.
2. THE TEMPORARY SPOIL SHALL BE BACKFILLED INTO EXCAVATION AFTER COMPLETION OF CONSTRUCTION.



DESIGNED	SCALE	DATE	PERMIT PLANS RE-ISSUED
CHECKED			
DETAILED			
CHECKED			
TIME			



LONG DISTANCE SEDIMENT PIPELINE WEST OF BARATARIA WATERWAY	RAILROAD CROSSING DETAIL
PROJECT NO.	153455
DATE	MAY 2017
SHEET NO.	511

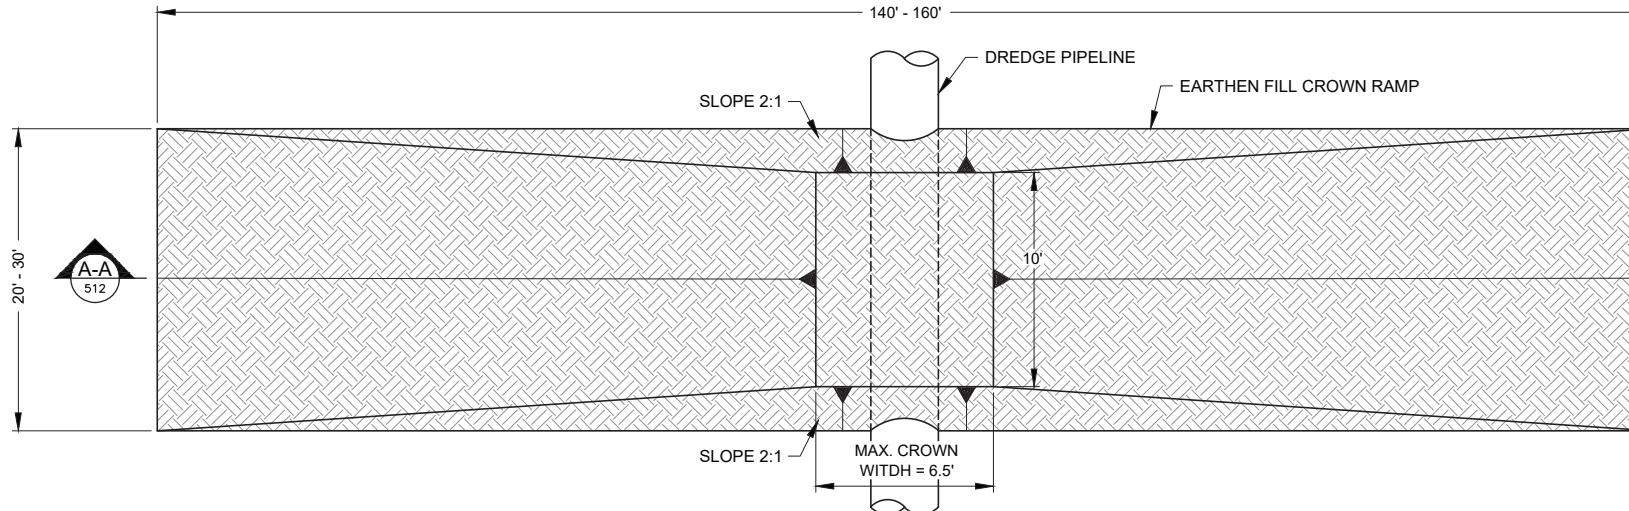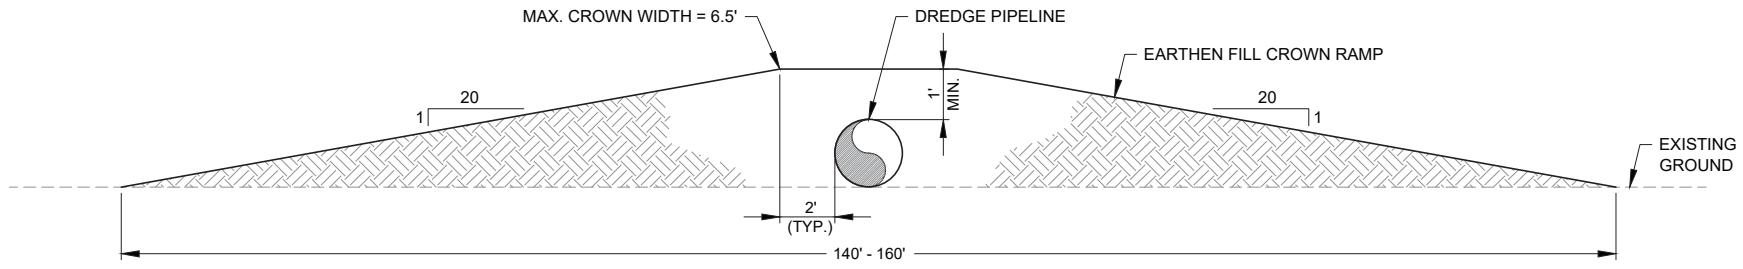PLAN VIEWSECTION A-A

## CATTLE CROSSING DETAIL

N.T.S.



DESIGNED	SCALE	PERMIT PLANS RE-ISSUED
CHECKED	DATE	NO. DATE
DETAILED	TIME	REVISION DESCRIPTION
CHECKED		

03/16/18

APTIM

THE METAIRIE CENTRE  
2024 EDENBORO AVE.  
SUITE 450  
METAIRIE, LA 70001 504.832.4878

APTIM



LONG DISTANCE SEDIMENT PIPELINE  
WEST OF BARATARIA WATERWAY

CATTLE CROSSING DETAIL

PROJECT NO.  
153455

DATE  
MAY 2017

SHEET NO.  
512

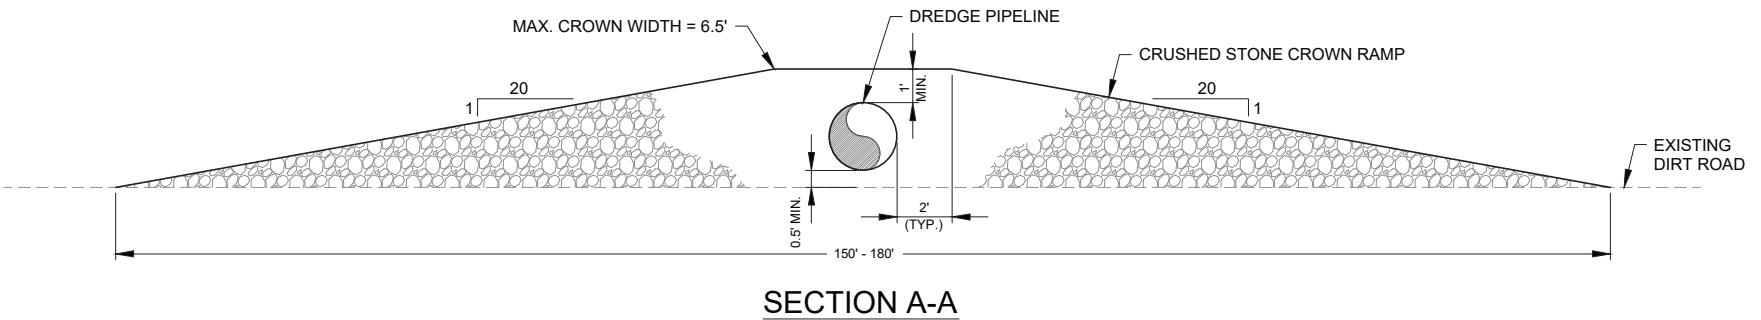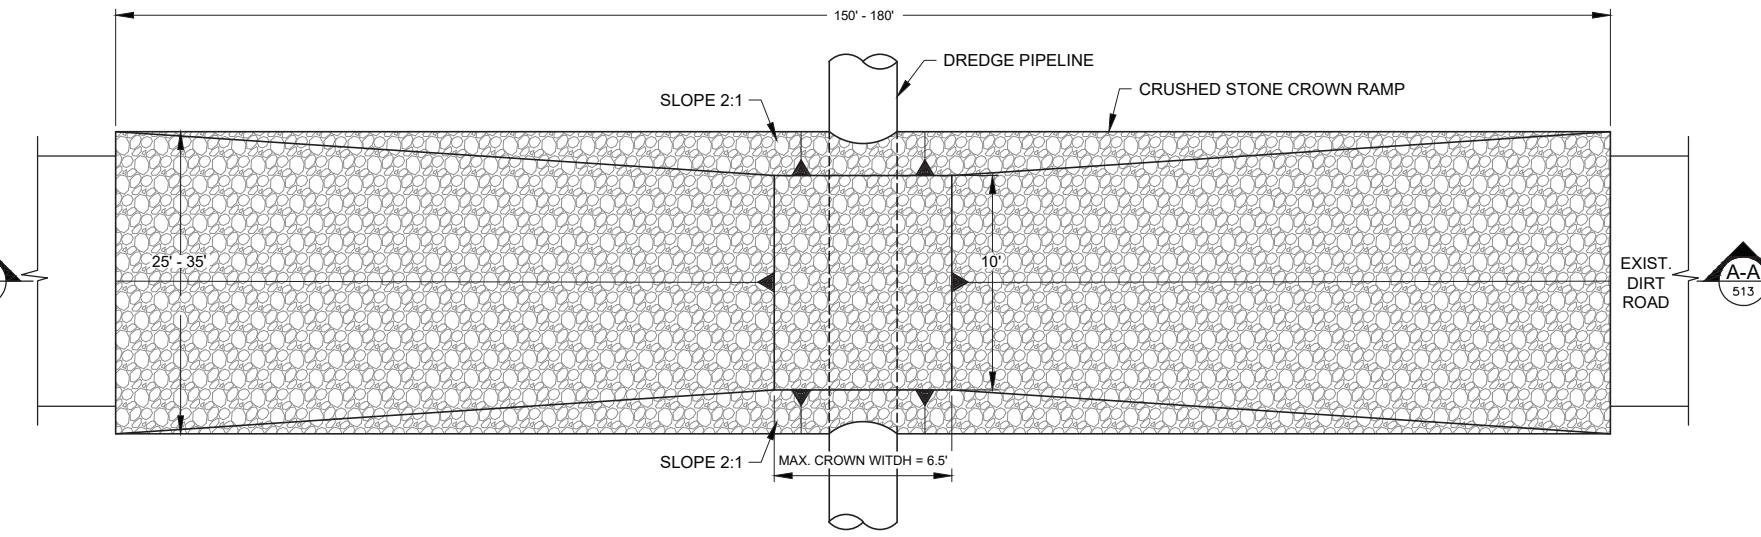


## DIRT ROAD CROSSING DETAIL

N.T.S.

**NOTE:**  
THE CROWN RAMP OVER THE PIPELINE CROSSINGS  
SHALL CONSIST OF CRUSHED STONE FOR FULL  
WIDTH AND LENGTH OF RAMP. THE CRUSH STONE  
MATERIAL SHALL CONFORM TO LA DOTD 2006  
SPECIFICATION 1003.04 (a).





DESIGNED	SCALE	RE-ISSUED
CHECKED	DATE	NO. DATE
DETAILED	TIME	REV. DESCRIPTION
		A 03/16/18
		PERMIT PLANS RE-ISSUED
		SPL BY

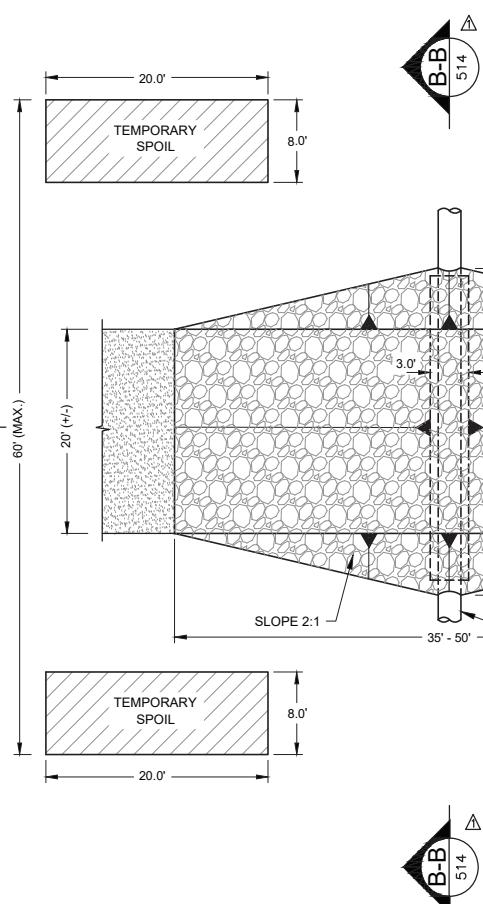

## GRAVEL ROAD CROSSING DETAIL NOT TO SCALE

**NOTE:**  
THE CROWN RAMP OVER THE PIPELINE CROSSINGS  
SHALL CONSIST OF CRUSHED STONE FOR FULL  
WIDTH AND LENGTH OF RAMP. THE CRUSH STONE  
MATERIAL SHALL CONFORM TO LA DOTD 2006  
SPECIFICATION 1003.04 (a).

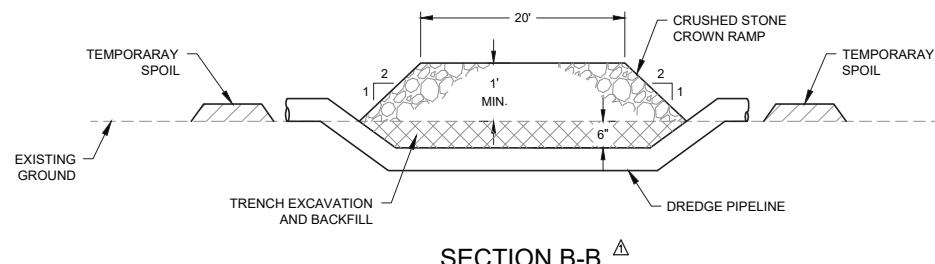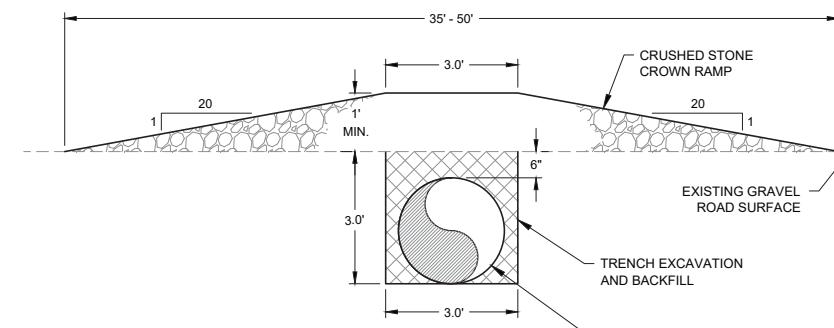


		PROJECT NO.	153455
DATE		MAY 2017	
SHEET NO.		514	
DESIGNED	SCALE		
CHECKED			
DETAILED	DATE	03/16/18	PERMIT PLANS RE-ISSUED
CHECKED	TIME	06/01/17	ADDED DETAIL
NO. DATE	NO. DATE	SP1	SP1
REVISION DESCRIPTION	BY		



**APTIM**  
THE METAIRIE CENTRE  
SUITE 450  
2024 EDENBORO AVE.  
METAIRIE, LA 70001 504.832.4878

**LONG DISTANCE SEDIMENT PIPELINE  
WEST OF BARATARIA WATERWAY**

**GRAVEL ROAD CROSSING DETAIL**

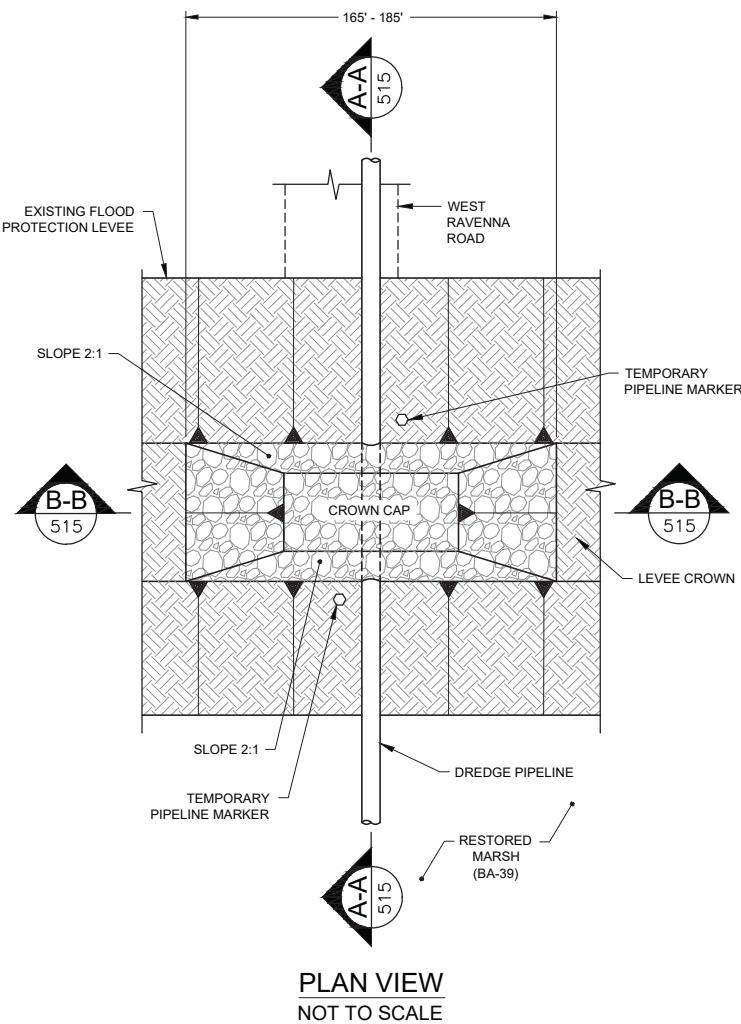

FLOOD PROTECTION LEVEE CROSSING DETAIL  
NOT TO SCALE

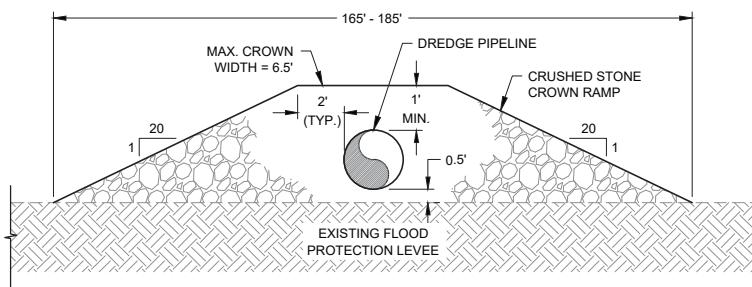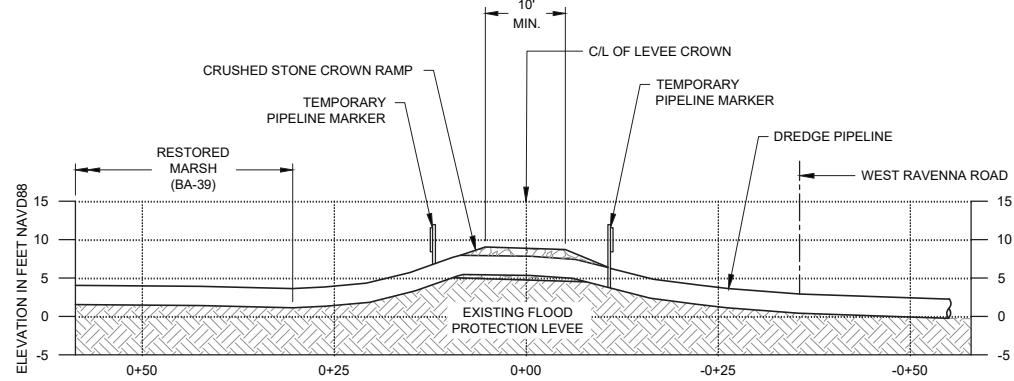

## NOTE:

1. THE CROWN RAMP OVER THE PIPELINE CROSSINGS SHALL CONSIST OF CRUSHED STONE FOR FULL WIDTH AND LENGTH OF RAMP. THE CRUSH STONE MATERIAL SHALL CONFORM TO LA DOTD 2006 SPECIFICATION 1003.04 (a).
2. TEMPORARY PIPELINE MARKERS INDICATING OWNER, CONTENTS, AND ADDRESS FOR CONTACTING OWNER SHALL BE PLACED AND MAINTAINED AT EACH TOE OF LEVEE NEAR DREDGE PIPELINE. LOCATION TO BE APPROVED BY ENGINEER AND INCLUDED IN WORK PLAN.
3. EXISTING GRADE BASED ON JANUARY 2012 TBS SURVEY.

		PROJECT NO. 153455	DATE MAY 2017	SHEET NO. 515
LONG DISTANCE SEDIMENT PIPELINE WEST OF BARATARIA WATERWAY		FLOOD PROTECTION LEVEE CROSSINGS DETAIL		
DESIGNED CHECKED DETAILED CHECKED	SCALE DATE TIME	APRIL 2018	PERMIT PLANS RE-ISSUED NO. DATE	SP-1 BY
		03/16/18		
APTIM THE METAIRIE CENTRE SUITE 450 2024 LEDGERBROOK AVE. METAIRIE, LA 70001 504.832.4878				

**PHASE - 1  
CORRIDOR ALIGNMENT**

PT.	EASTING	NORTHING
1	3,709,295.15	439,287.46
2	3,708,833.00	439,073.60
3	3,708,745.00	439,037.80
4	3,708,378.00	438,874.90
5	3,708,210.00	438,777.60
6	3,707,468.37	438,457.08
7	3,708,010.71	436,924.44
8	3,708,151.13	433,271.33
9	3,708,274.87	432,470.08
10	3,709,020.90	428,442.06
11	3,709,207.34	427,358.82
12	3,709,640.03	426,810.80
13	3,701,112.29	423,381.44
14	3,700,741.69	423,294.08
15	3,700,538.00	423,185.19
16	3,700,424.62	422,753.89
17	3,700,308.53	422,659.59
18	3,700,145.88	422,615.52
19	3,699,761.50	422,478.14
20	3,699,047.76	421,979.44
21	3,698,472.93	421,778.59
22	3,698,209.03	421,735.03
23	3,697,614.62	421,819.58
24	3,697,345.59	421,817.02
25	3,696,976.65	421,653.04
26	3,696,595.44	421,288.58
27	3,696,457.72	420,983.63
28	3,696,265.66	420,853.30
29	3,695,810.63	420,487.43
30	3,695,480.80	420,305.26
31	3,694,958.57	420,150.54
32	3,694,425.06	420,098.06
33	3,693,702.83	420,090.22
34	3,693,324.98	419,970.64
35	3,693,181.49	419,664.54
36	3,693,138.44	419,339.30
37	3,693,047.57	419,061.89
38	3,692,722.33	418,884.92
39	3,692,387.88	418,732.22
40	3,691,538.80	418,212.58
41	3,690,560.34	417,459.37
42	3,689,830.18	416,790.07
43	3,689,499.31	416,263.43
44	3,689,218.65	415,281.97
45	3,689,054.74	414,815.39
46	3,688,249.91	413,214.21
47	3,688,283.09	407,203.22
48	3,687,861.43	407,299.85
49	3,687,344.87	407,141.21
50	3,687,223.27	408,938.83
51	3,687,273.39	403,722.11
52	3,686,355.04	403,722.11
53	3,685,124.98	403,693.14
54	3,684,546.62	403,857.35
55	3,681,882.06	403,197.09

**PROPOSED PHASE - 2  
CORRIDOR ALIGNMENT**

PT.	EASTING	NORTHING
56	3,681,100.11	402,626.99
57	3,676,992.87	399,632.47
58	3,676,936.35	399,568.85
59	3,676,414.36	398,640.11
60	3,676,388.75	398,538.26
61	3,676,545.34	390,428.13
62	3,676,348.61	390,224.30
63	3,662,353.17	389,998.57
64	3,662,157.57	389,776.99
65	3,662,361.55	387,899.71
66	3,662,162.72	387,678.11
67	3,653,271.75	387,678.11
68	3,653,108.61	387,762.40
69	3,650,837.37	390,964.68
70	3,650,828.15	390,977.80
71	3,649,905.77	392,540.35
72	3,649,807.12	392,624.61
73	3,648,475.83	393,151.03
74	3,648,447.17	393,159.94
75	3,647,367.25	393,408.65
76	3,647,313.05	393,413.54
77	3,641,033.07	393,120.88
78	3,640,843.74	392,897.85
79	3,641,050.34	391,132.34
80	3,640,952.75	390,936.50
81	3,638,956.56	389,767.81
82	3,638,926.63	389,746.36
83	3,637,500.36	388,510.40
84	3,637,457.55	388,458.25
85	3,635,676.12	385,330.91

**ACCESS CHANNEL ALIGNMENT**


PT.	EASTING	NORTHING
1	3,674,003.32	417,761.76
2	3,674,374.61	417,984.33
3	3,674,549.10	417,843.37
4	3,674,605.34	417,650.30
5	3,674,768.33	417,626.30
6	3,874,891.14	417,524.69
7	3,675,173.97	417,404.50
8	3,675,374.37	417,400.08
9	3,675,899.41	417,192.18
10	3,676,242.80	417,171.66
11	3,676,428.65	417,358.88
12	3,676,548.44	417,686.20
13	3,676,739.59	417,811.17
14	3,677,375.53	417,869.55
15	3,677,870.90	417,830.11
16	3,678,337.82	417,708.89
17	3,678,811.83	417,514.80
18	3,679,772.32	416,805.21
19	3,679,930.74	416,596.04
20	3,680,221.29	416,069.93
21	3,680,593.81	415,970.76
22	3,680,718.25	415,816.36
23	3,680,950.88	415,619.43
24	3,681,378.51	415,564.60
25	3,681,635.27	415,496.11
26	3,681,977.36	415,432.46
27	3,682,205.59	415,229.13
28	3,682,250.83	415,129.57
29	3,682,397.09	414,968.27
30	3,683,138.30	414,802.76
31	3,683,474.36	414,513.64
32	3,683,792.94	414,308.27
33	3,884,035.91	414,239.78
34	3,684,285.57	414,253.96
35	3,684,542.75	414,352.05
36	3,684,764.87	414,409.57
37	3,685,015.36	414,387.73
38	3,685,168.42	414,252.81
39	3,685,281.66	414,088.33
40	3,685,359.42	414,002.16
41	3,685,450.50	413,949.56
42	3,685,898.07	413,778.66
43	3,686,447.21	413,686.62
44	3,686,740.16	413,671.24
45	3,687,188.62	413,691.73
46	3,687,438.03	413,721.65
47	3,687,616.06	413,782.04
48	3,687,710.79	413,852.06
49	3,687,766.22	414,034.24
50	3,687,811.91	414,175.11
51	3,687,930.02	414,339.53
52	3,688,053.13	414,460.19
53	3,688,138.44	414,524.38
54	3,688,306.59	414,717.17
55	3,688,397.69	414,842.33
56	3,688,450.73	414,937.10
57	3,688,547.73	415,047.00
58	3,688,627.47	415,092.91
59	3,688,728.80	415,115.08
60	3,888,878.22	415,127.36
61	3,689,243.43	415,004.47



DESIGNED	SCALE
CHECKED	
DETAILED	DATE
DETAILED	TIME
CHECKED	

APTIM  
THE METARIA C. CENTRE  
SUITE 202 EDENBROOK LANE  
METARIA, LA 70001 504.832.4878

LONG DISTANCE SEDIMENT PIPELINE WEST OF BARATARIA WATERWAY	PROJECT ALIGNMENT TABLES
PROJECT NO.	153455
DATE	MAY 2017
SHEET NO.	516

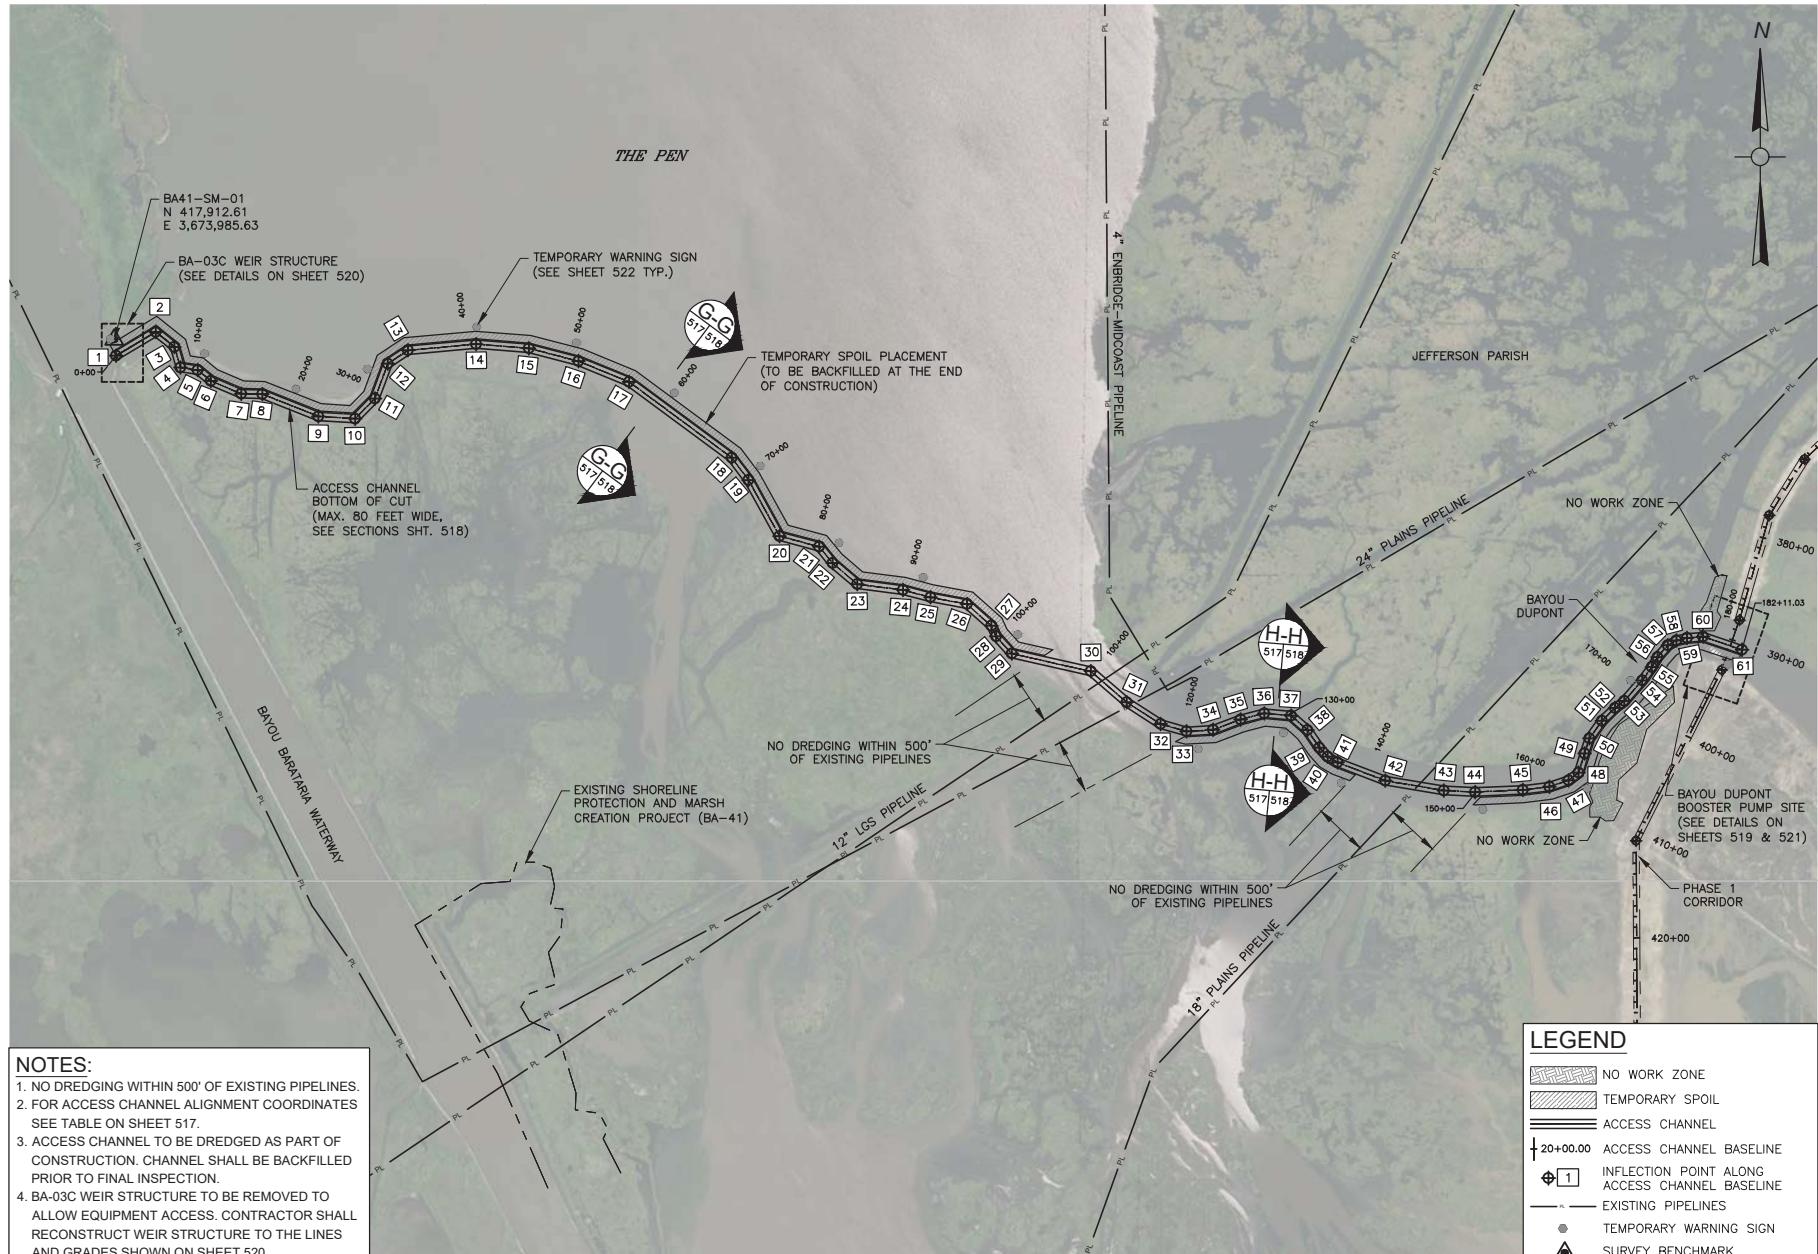

## ACCESS CHANNEL LAYOUT



**NOTE:**  
SEE SHEET 006 FOR IMAGERY DISCLAIMER CITATION PROVIDED BY  
THE REGIONAL PLANNING COMMISSION AND THE UNITED STATES  
DEPARTMENT OF AGRICULTURE (USDA).





DESIGNED	SCALE	CHECKED	DATE	TIME	PL	SPL	SPL


**APTIM**  
THE METARIE CENTRE  
205 E GENOISEN AVE  
METARIE, LA 70001 504.832.4878



LONG DISTANCE SEDIMENT PIPELINE WEST OF BARATARIA WATERWAY	ACCESS CHANNEL LAYOUT
PROJECT NO.	153455
DATE	MAY 2017
SHEET NO.	517

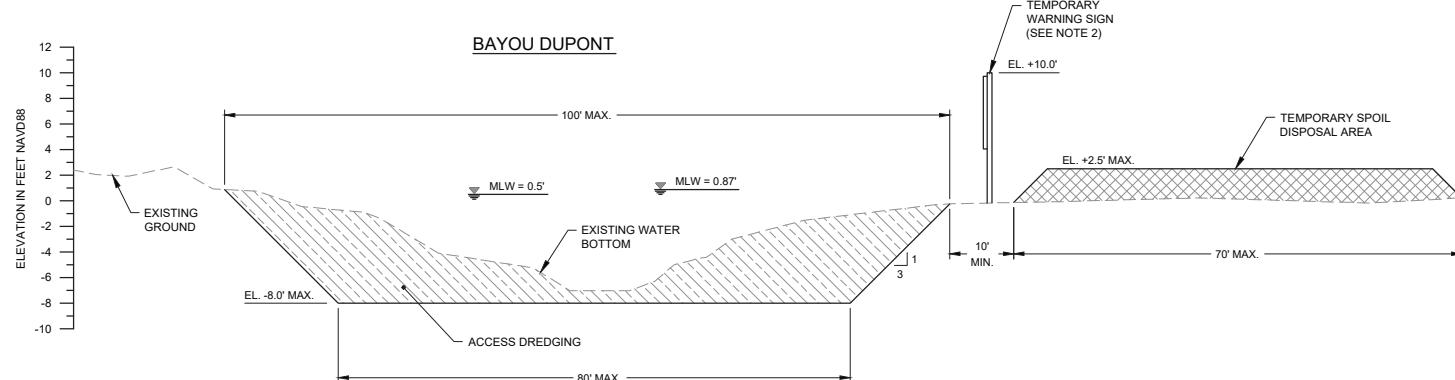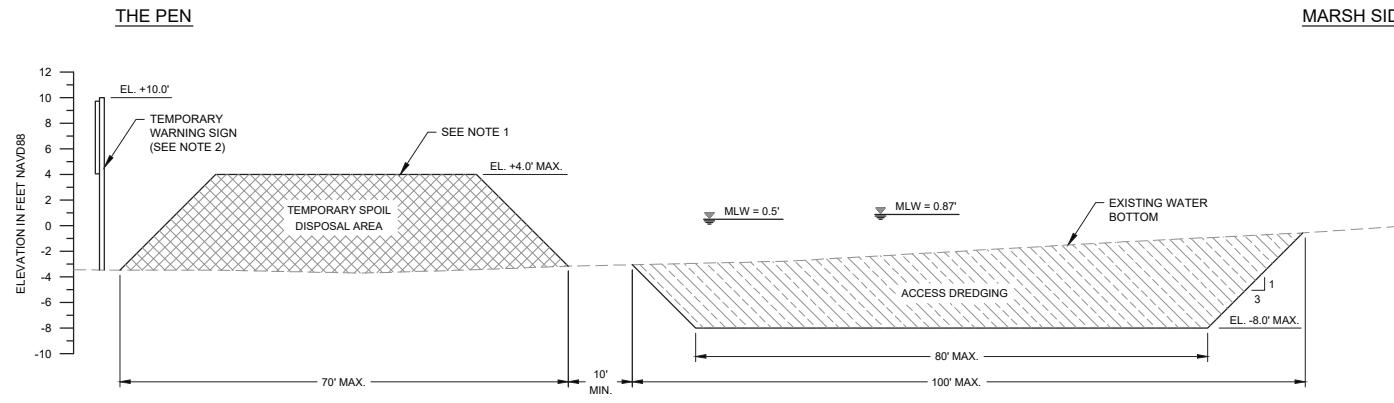**LEGEND**


- TEMPORARY SPOIL DISPOSAL AREA
- ACCESS DREDGING
- DESIGN GRADE
- EXISTING GRADE

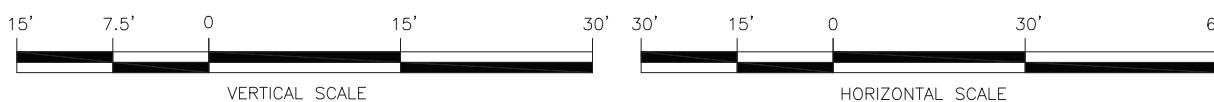**NOTES:**

1. MATERIAL EXCAVATED TO CONSTRUCT THE ACCESS CHANNEL SHALL BE PLACED ON THE LAKE SIDE AND BACKFILLED INTO THE ACCESS CHANNEL PRIOR TO FINAL INSPECTION. TEMPORARY SPOIL SHALL NOT BE PLACED ON EXISTING MARSH.
2. TEMPORARY WARNING SIGNS SHALL BE PLACED AT A MAXIMUM SPACING OF 1,000 FT. ALONG ALL TEMPORARY SPOIL DISPOSAL AREAS.
3. ACCESS CHANNEL TO BE DREDGED AS PART OF CONSTRUCTION. CHANNEL SHALL BE BACKFILLED PRIOR TO FINAL INSPECTION.

<b>APTIM</b> THE METAIRIE CENTRE 2024 LEDGERBORG LANE SUITE 450 METAIRIE, LA 70001 504.832.4878		DESIGNED CHECKED DETAILED CHECKED	SCALE DATE TIME	PERMIT PLANS RE-ISSUED NO. DATE	REVISION DESCRIPTION SPL BY
LONG DISTANCE SEDIMENT PIPELINE WEST OF BARATARIA WATERWAY TYPICAL ACCESS CHANNEL SECTIONS					
PROJECT NO. 153455		DATE MAY 2017	SHEET NO. 518		



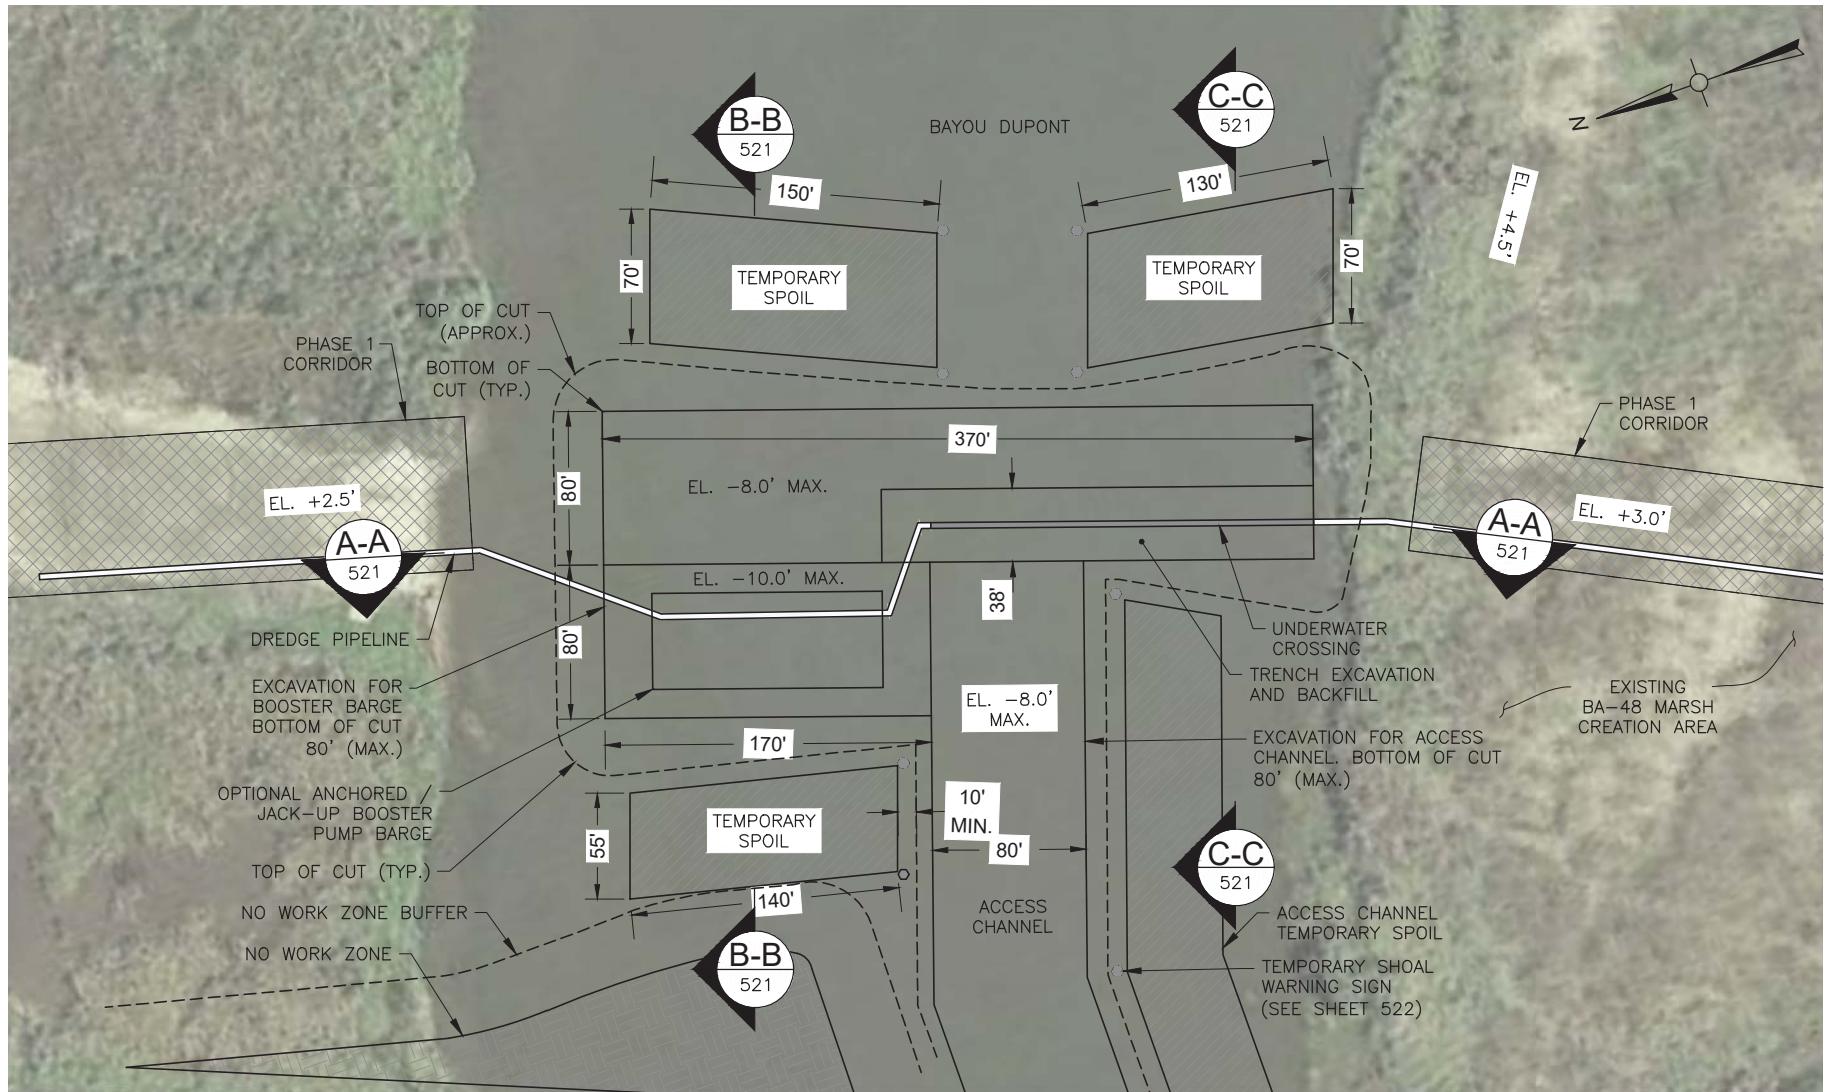

**NOTE:**  
SEE SHEET 006 FOR IMAGERY DISCLAIMER CITATION PROVIDED BY  
THE REGIONAL PLANNING COMMISSION AND THE UNITED STATES  
DEPARTMENT OF AGRICULTURE (USDA).

100' 50' 0 100' 200'  
SCALE: 1"=100'




SPL.  
SPL.  
SPL.  
SPL.

07/25/18 CITATION NOTE REVISION  
03/16/18 PERMIT PLANS RE-ISSUED  
No. DATE Revision Description

DESIGNED  
CHECKED  
DETAILED  
DATE  
TIME

APTIM  
THE METairie CENTRE  
205 E GENOERA AVE.  
SUITE 450  
METairie, LA 70001 504.832.4878

APTIM

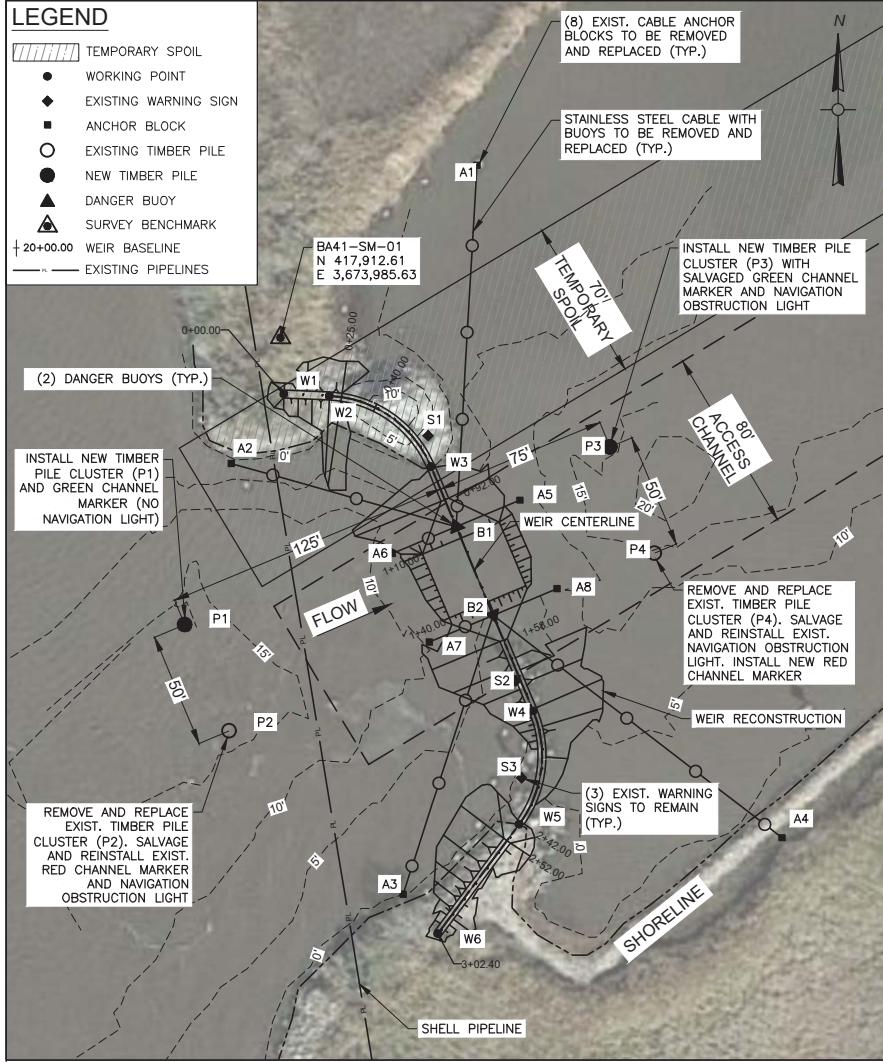


## NOTES:

1. CONTOURS SHOWN ARE BASED ON SIGMA SURVEY DATED DECEMBER 2011.

**PLAN VIEW**  
NOT TO SCALE

**NOTE:**  
SEE SHEET 006 FOR IMAGERY DISCLAIMER CITATION PROVIDED BY THE REGIONAL PLANNING COMMISSION AND THE UNITED STATES DEPARTMENT OF AGRICULTURE (USDA).

1  
517 520

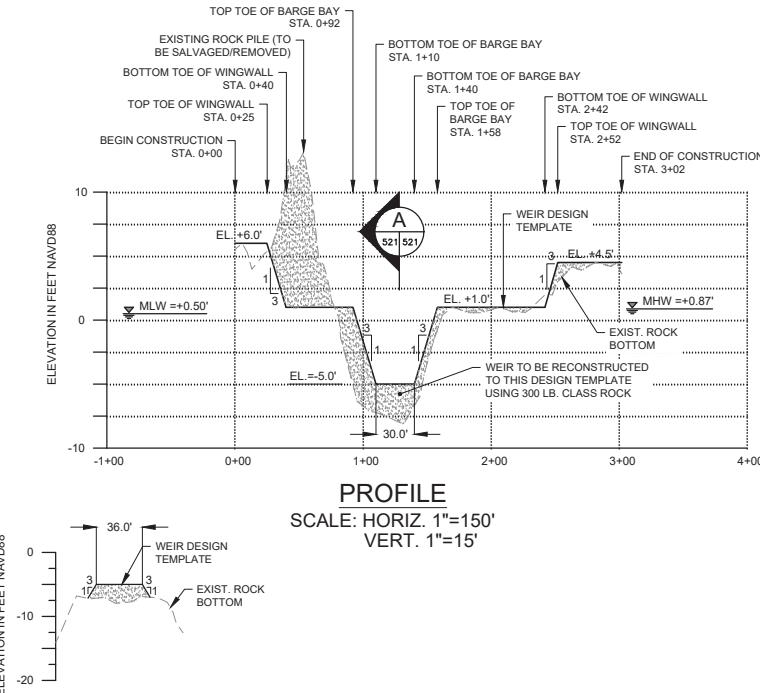**BAYOU DUPONT WEIR STRUCTURE DETAILS****TYPICAL CROSS SECTION 'A'**  
(STA. 1+25.00)SCALE: HORIZ. 1"=150'  
VERT. 1"=30'

NAVIGATION SIGNS AND OBSTRUCTION LIGHTS COORDINATES		
PT.	EASTING	NORTHING
P1	3,673,944.08	417,788.05
P2	3,673,963.36	417,741.92
P3	3,674,128.80	417,865.19
P4	3,674,147.89	417,819.06

ANCHOR BLOCK COORDINATES		
PT.	EASTING	NORTHING
A1	3,674,070.89	417,987.48
A2	3,673,964.21	417,858.02
A3	3,674,038.87	417,671.12
A4	3,674,203.23	417,695.60
A5	3,674,089.51	417,842.12
A6	3,674,034.15	417,818.97
A7	3,674,050.22	417,780.53
A8	3,674,105.58	417,803.68

WEIR CENTERLINE COORDINATES		
PT.	EASTING	NORTHING
W1	3,673,987.11	417,888.11
W2	3,674,006.87	417,887.29
W3	3,674,050.93	417,856.62
W4	3,674,095.27	417,750.57
W5	3,674,089.21	417,701.38
W6	3,674,053.83	417,653.97

NAVIGATIONAL BUOY COORDINATES		
PT.	EASTING	NORTHING
B1	3,674,061.83	417,830.55
B2	3,674,077.90	417,792.11







DESIGNED	SCALE
CHECKED	DATE
DETAILED	TIME
APTIM	APTIM
THE METARIE CENTRE	THE METARIE CENTRE
SUITE 450	SUITE 450
METARIE, LA 70001	METARIE, LA 70001
504.832.4878	504.832.4878

APTIM	APTIM
LONG DISTANCE SEDIMENT PIPELINE	LONG DISTANCE SEDIMENT PIPELINE
WEST OF BARATARIA WATERWAY	WEST OF BARATARIA WATERWAY
BAYOU DUPONT	BAYOU DUPONT
WEIR STRUCTURE DETAILS	WEIR STRUCTURE DETAILS



PROJECT NO.	153455
DATE	MAY 2017
SHEET NO.	520
AIMS Group, Inc.	Consulting Engineers
4421 Zenith Street	Ph. 504.887.7045
Metairie, LA 70001	Fax. 504.887.7088

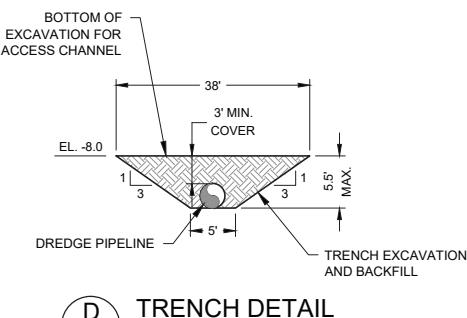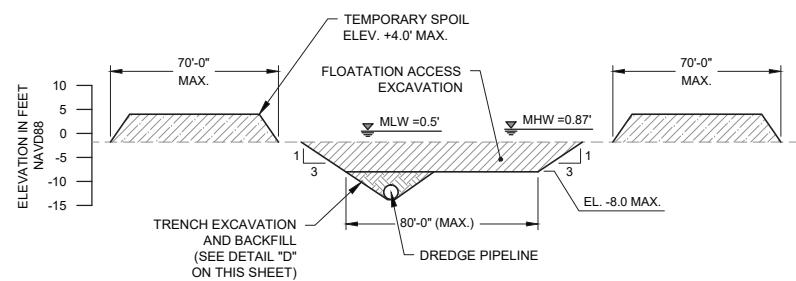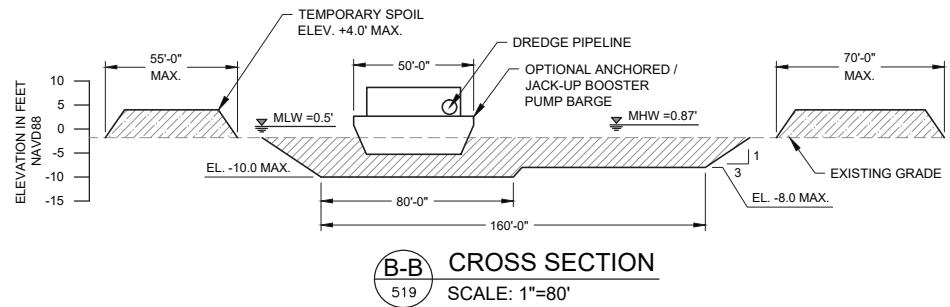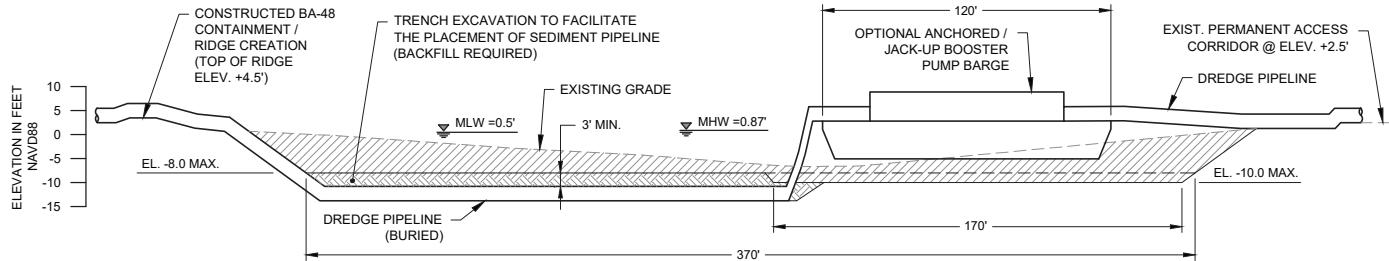

40' 20' 0 40' 80' 80' 40' 0 80' 160'

VERTICAL SCALE HORIZONTAL SCALE



PROJECT NO.	153455	DATE	MAY 2017	PERMIT PLANS RE-ISSUED	
NO. DATE		TIME		REVISION DESCRIPTION	SPL BY
03/16/18					




LONG DISTANCE SEDIMENT PIPELINE  
WEST OF BARATARIA WATERWAY  
BAYOU DUPONT BOOSTER PUMP SITE  
TYPICAL DETAILS

PROJECT NO.  
153455

DATE  
MAY 2017

SHEET NO.  
521

APTIM  
THE METAIRIE CENTRE  
SUITE 460  
2024 LEDGERDALE AVENUE  
METAIRIE, LA 70001 504.832.4878

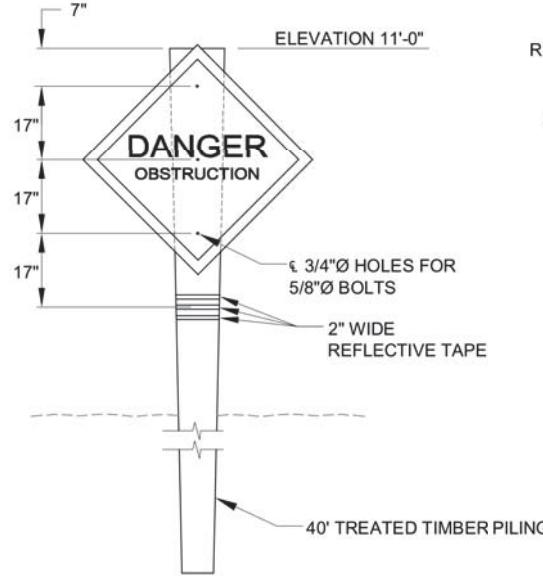
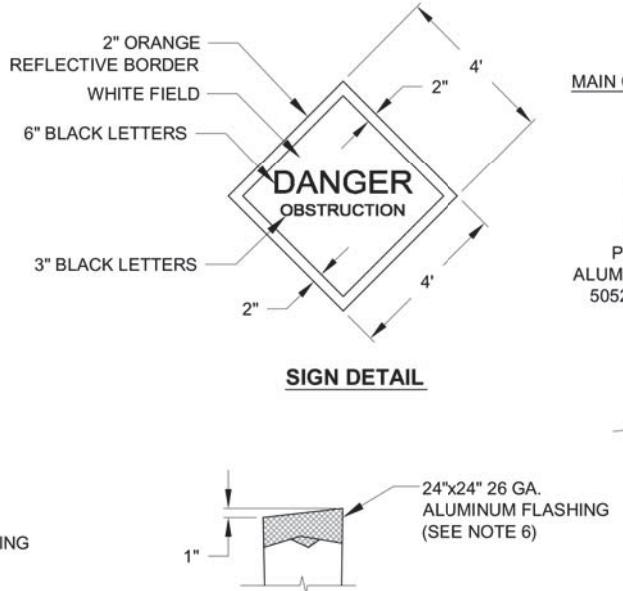
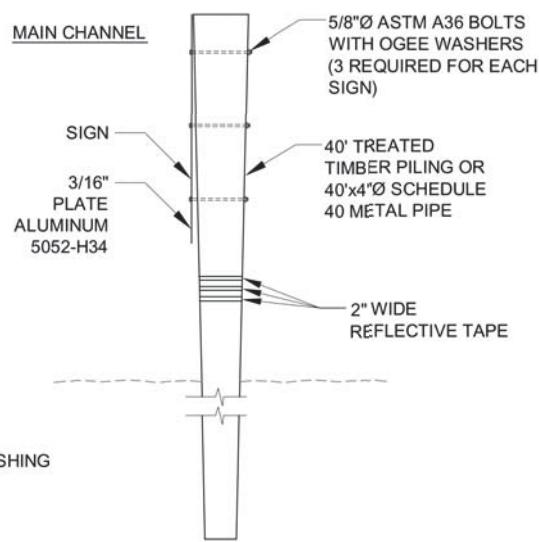
WARNING SIGN ELEVATIONTYPICAL TIMBER PILE CAPWARNING SIGN SIDE DETAILTEMPORARY WARNING SIGN DETAILS

NOT TO SCALE

WARNING SIGN NOTES

1. TWENTY-FIVE (25) TEMPORARY WARNING SIGNS, INCLUDING TIMBER PILES, SHALL BE INSTALLED AT LOCATIONS SHOWN ON SHEETS 21 AND 23. THE 2" BORDER ON THE WARNING SIGN WILL BE REFLECTIVE MATERIAL OF ORANGE COLOR. THE LETTERING FIELD WILL BE A REFLECTIVE MATERIAL OF WHITE COLOR. THE LETTERING FOR THE WARNING SIGNS WILL BE BLACK. ALL SIGNS MUST MEET U.S. COAST GUARD STANDARDS; IN ACCORDANCE WITH 33 CFR 330.4 (a)(1) WHICH CAN BE DOWNLOADED AT [http://www.access.gpo.gov/nara/cfr/waisidx\\_0233cf330\\_02.html](http://www.access.gpo.gov/nara/cfr/waisidx_0233cf330_02.html)
2. NEOPRENE WASHERS SHALL BE PLACED BETWEEN THE SIGN AND THE PILING AT ALL POINTS OF CONTACT.
3. HARDWARE FOR TIMBER CONNECTIONS SHALL BE HOT DIP GALVANIZED IN ACCORDANCE WITH SECTION 811.5 OF THE LOUISIANA STANDARD SPECIFICATIONS FOR ROADS AND BRIDGES, AS PUBLISHED BY THE LOUISIANA DEPARTMENT OF TRANSPORTATION AND DEVELOPMENT, LATEST EDITION.
4. TIMBER PILES SHALL CONFORM TO SECTIONS 804 AND 1014 OF THE LOUISIANA STANDARD SPECIFICATIONS FOR ROADS AND BRIDGES, AS PUBLISHED BY THE LOUISIANA DEPARTMENT OF TRANSPORTATION AND DEVELOPMENT, LATEST EDITION. PILES SHALL BE TREATED WITH A CREOSOTE SOLUTION CONFORMING TO AWPA P2 TO A MINIMUM RETENTION OF 20 PCF AND CAPPED ACCORDING TO LA DOTD SPECIFICATION 812.06.
5. TIMBER PILINGS SHALL BE 40' IN LENGTH WITH A NOMINAL 12" DIAMETER BUTT AND 7" MINIMUM DIAMETER AT THE TIP.
6. THE TOP OF THE PILES SHALL BE COATED WITH COAL TAR EPOXY PAINT PRIOR TO PLACING CAP. THE PILE CAP SHALL BE ATTACHED USING ALUMINUM OR STAINLESS STEEL NAILS.

<p>AIMS Group, Inc. Consulting Engineers</p> <p>4421 Zenith Street Metairie, LA 70001</p> <p>Ph. 504.887.7045 Fax. 504.887.7088</p>		LONG DISTANCE SEDIMENT PIPELINE WEST OF BARATARIA WATERWAY		TEMPORARY SHOAL WARNING SIGN DETAILS	
		PROJECT NO.	153455	DATE	MAY 2017

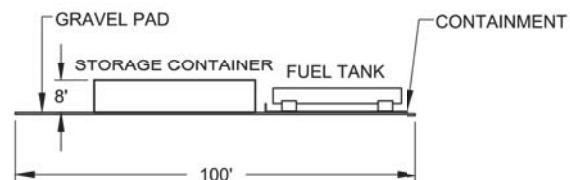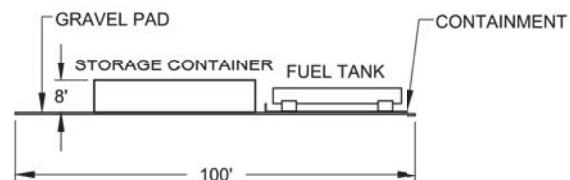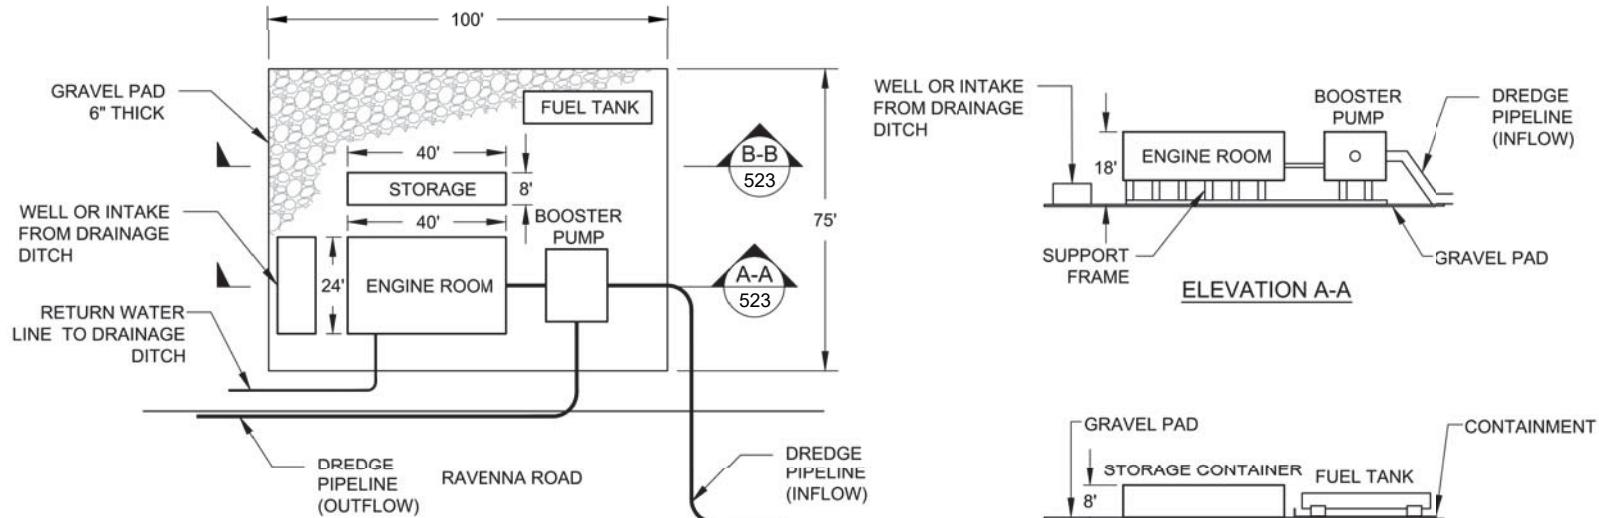


**LANDSIDE BOOSTER PUMP DETAILS**

203

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202  
NOT TO SCALE

NOTE:  
TYPICAL LANDSIDE BOOSTER SETUP. ACTUAL MAY VARY.


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LONG DISTANCE SEDIMENT PIPELINE WEST OF BARATARIA WATERWAY		DATE MAY 2017	
LANDSIDE BOOSTER PUMP PLAN AND ELEVATIONS		SHEET NO. 523	
THE METAIRIE CENTRE 2024 EDENBORO AVE. SUITE 450 METAIRIE, LA 70001		PERMIT PLANS RE-ISSUED NO. DATE A 03/16/18	
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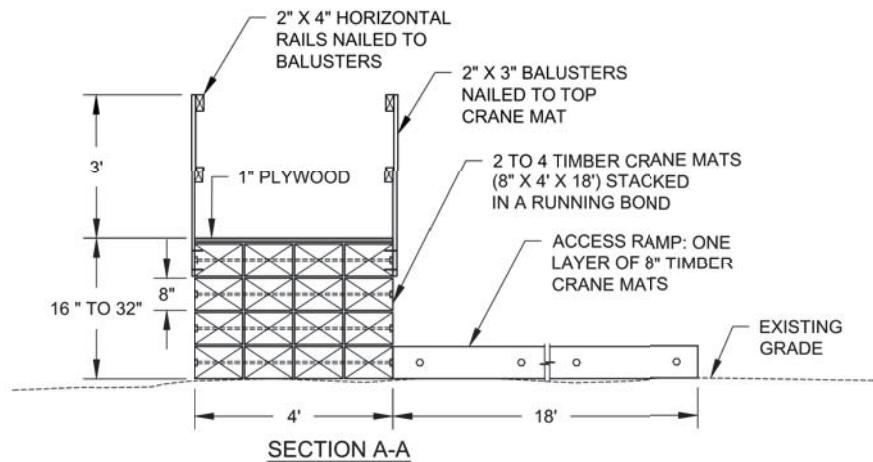
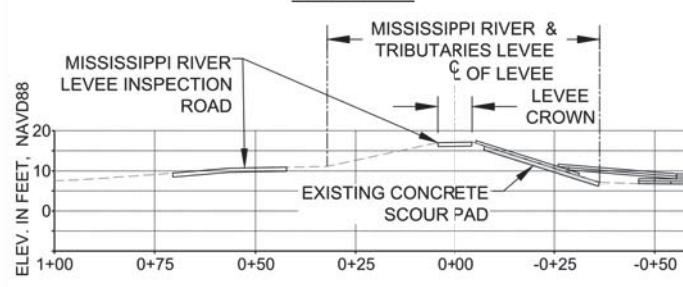
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506 FLOWING BOOSTER PUMP DETAILS  
NOT TO SCALE

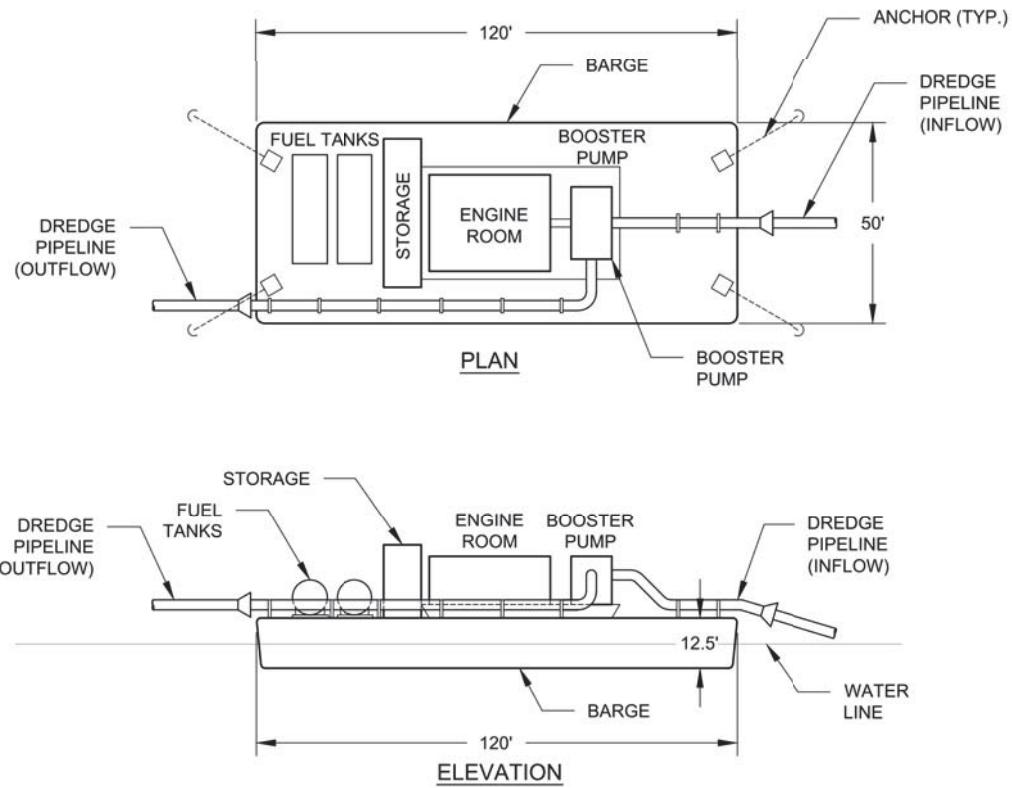NOTE:  
TYPICAL FLOWING BOOSTER SETUP.  
ACTUAL MAY VARY.

		PROJECT NO.		153455	
		DATE		MAY 2017	
		SHEET NO.		524	
LONG DISTANCE SEDIMENT PIPELINE WEST OF BARATARIA WATERWAY		FLOATING BOOSTER PUMP PLAN AND ELEVATIONS			
APTIM THE METAIRIE CENTRE SUITE 450 METAIRIE, LA 70001 504.832.4878					
DESIGNED	SCALE	DATE	PERMIT PLANS RE-ISSUED		
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PLAN VIEW




## NOTES:

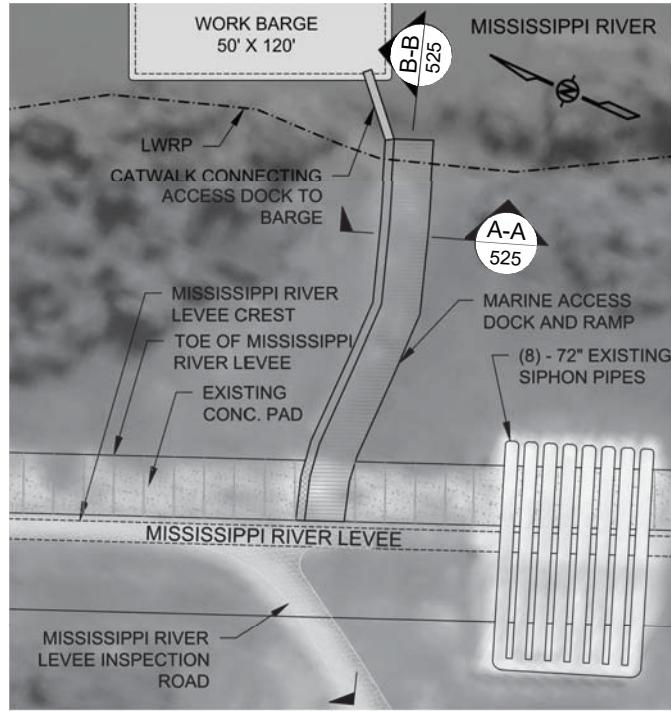1. EXISTING GRADES BASED ON JANUARY 2012 TBS SURVEY.
2. TEMPORARY MARINE ACCESS DOCK WILL BE PLACED TO FACILITATE CONSTRUCTION PERSONNEL ACCESS TO THE MISSISSIPPI RIVER.
3. ACCESS DOCK DETAILS BASED ON BA-39 PROJECT CONSTRUCTION. ACTUAL DETAILS MAY VARY BUT WILL HAVE TO BE INCLUDED IN THE CONTRACTOR'S WORK PLAN FOR APPROVAL BY THE ENGINEER PRIOR TO CONSTRUCTION AND PLACED WITHIN THE CONSTRUCTION LIMITS.
4. ACCESS DOCK TO BE COMPLETELY REMOVED AFTER PROJECT IS COMPLETE.

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## TEMPORARY MARINE ACCESS DOCK DETAILS

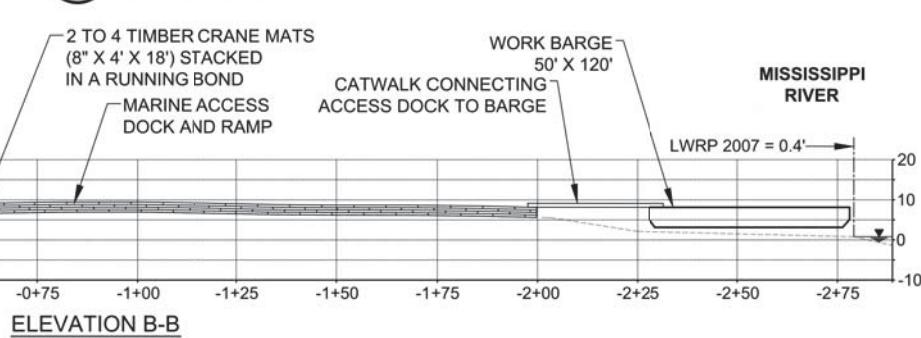

DESIGNED	SCALE	CHECKED	DATE	TIME	PERMIT PLANS RE-ISSUED	SP.
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LONG DISTANCE SEDIMENT PIPELINE WEST OF BARATARIA WATERWAY	TEMPORARY MARINE ACCESS DOCK DETAILS
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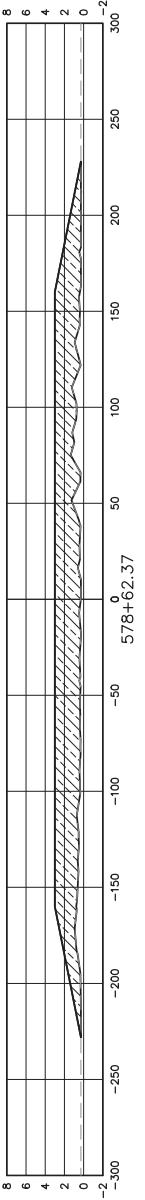
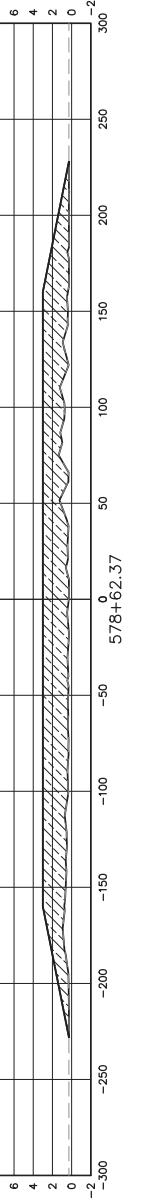
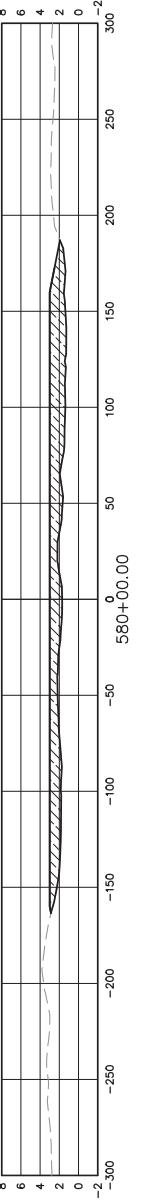
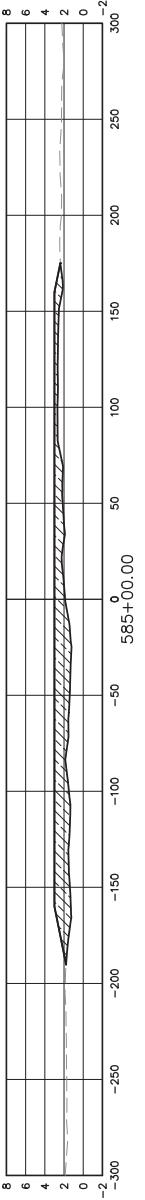
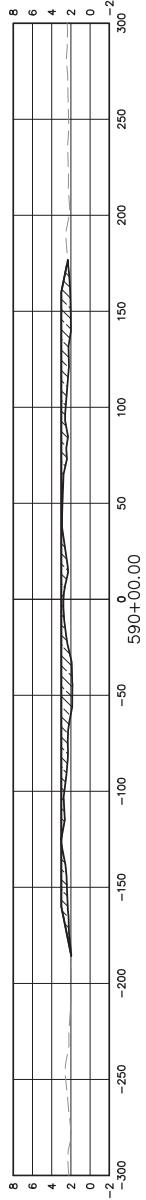
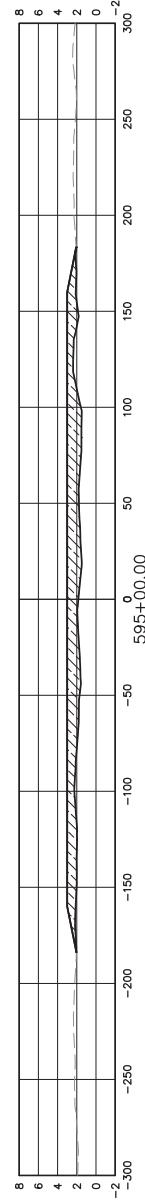
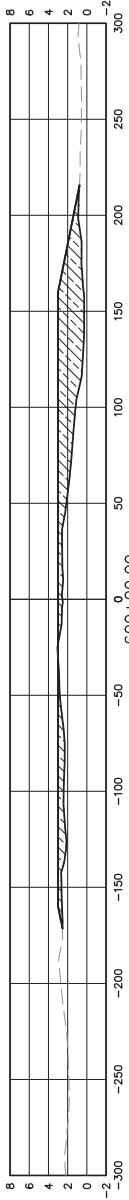
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SHEET NO. 525	



SNC-Lavalin

Group Inc.

www.snc-lavalin.com



AIMS Group, Inc.  
Consulting Engineers  
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Email: info@aimsinc.com  
8/6/2018 1:14 PM

PROJECT NO. 153455  
DATE MAY 2017  
SHEET NO. 601



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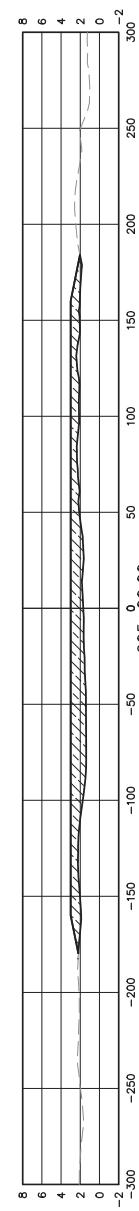
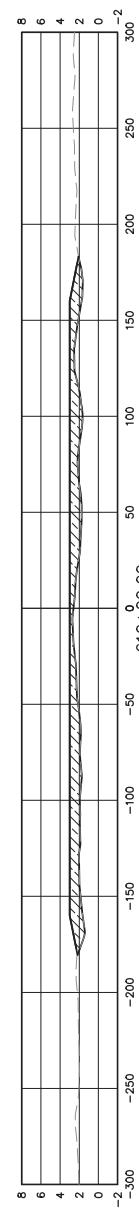
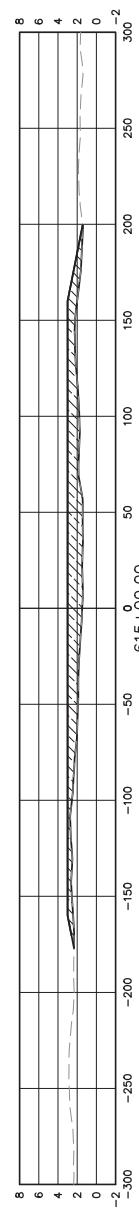
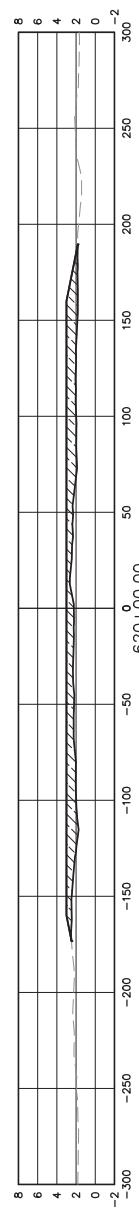
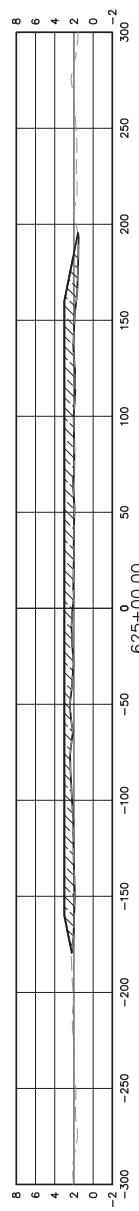
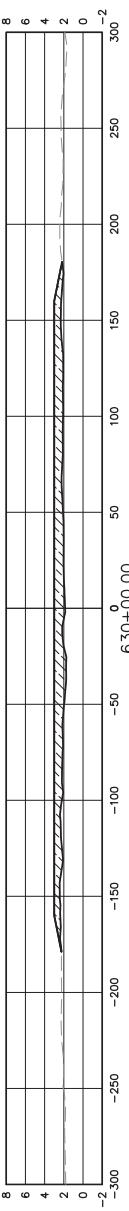
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LA, 70001 504-832-4878  
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DESIGN CROSS SECTIONS  
PROJECT NO.

153455	DATE MAY 2017	SHEET NO. <b>602</b>
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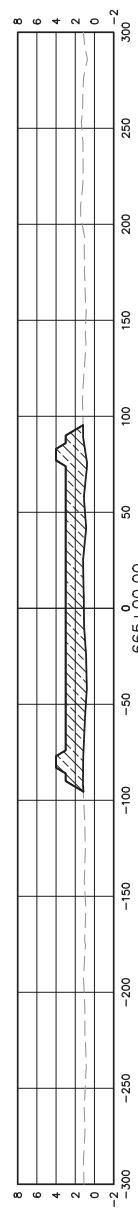
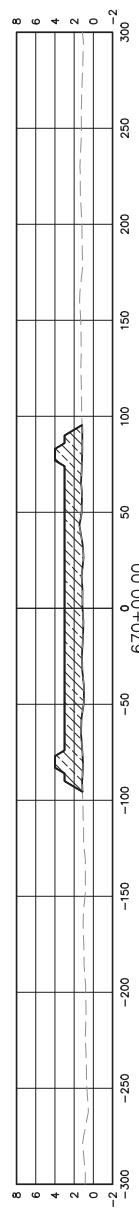
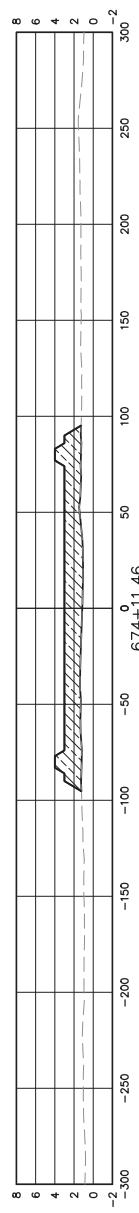
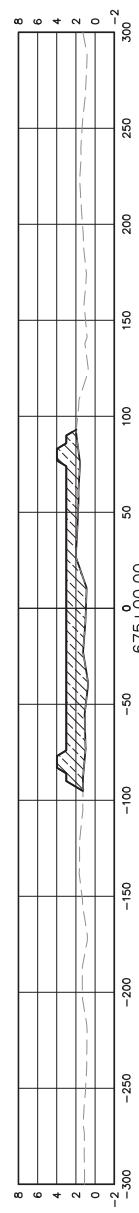
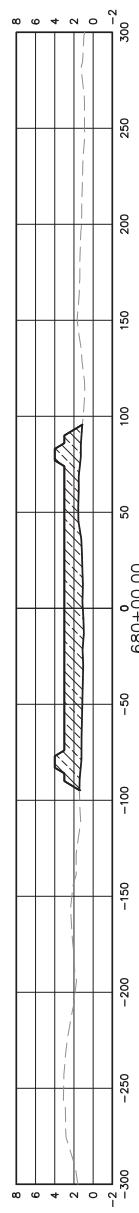
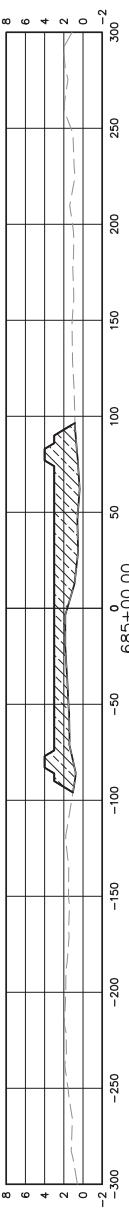
REVISI ON DESCRIPT ION	BY
OR PERMIT RE-ISSUE	SPL

DESIGNER	CHEKED
DETAILD	TRAINEE, LA, 70001 504-832-4878
CHIEF	242 E BENDIBORN AVE.
PTIM	ME MARTIAN CENTER



DESIGN CROSS SECTIONS  
PROJECT NO. 1

153455	DATE	MAY 2017	SHEET NO.	604
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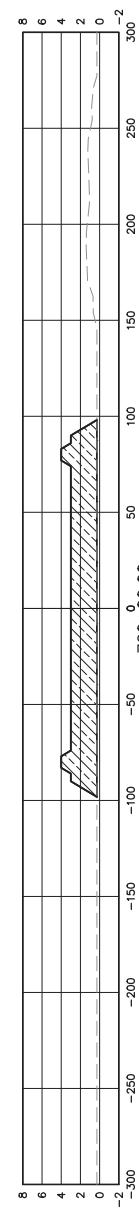
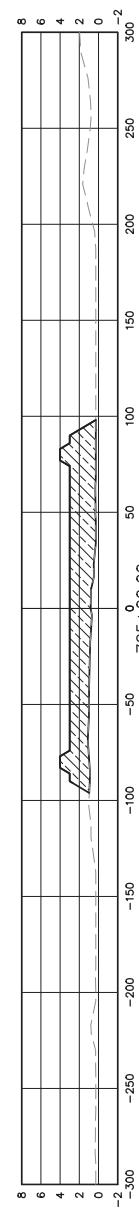
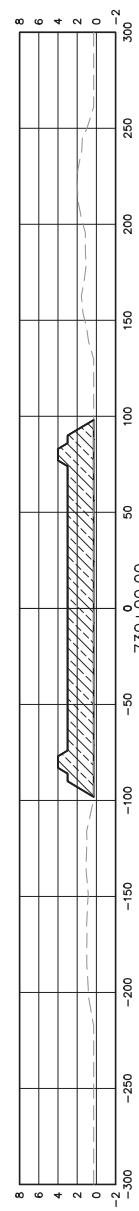
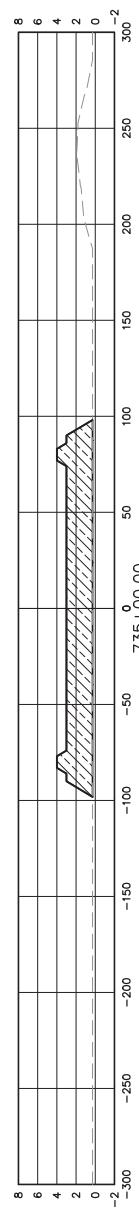
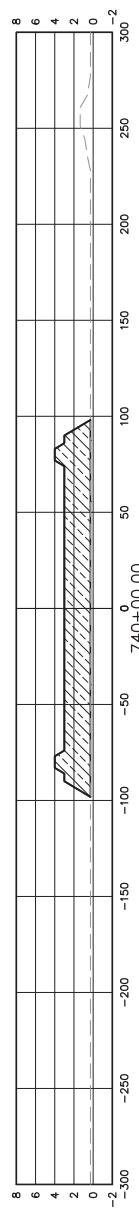
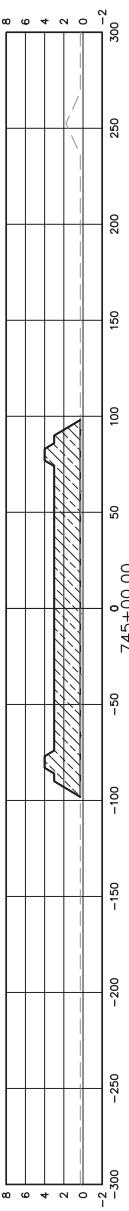
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DESIGNER	CHEKED
DETAILD	TRAINEE, LA, 70001 504-832-4878
CHIEF	242 E BENDIBORN AVE.
PTIM	ME MARTIAN CENTER



DESIGN CROSS SECTIONS  
WEST OF BARATRAIA MILEWAY  
LONG DISTANCE SEMI-MT PILELINE  
PROJECT NO.

153455	DATE	MAY 2017	SHEET NO.	606
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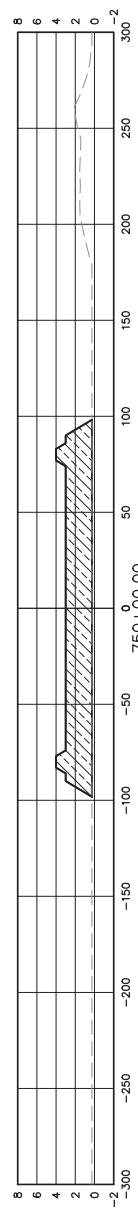
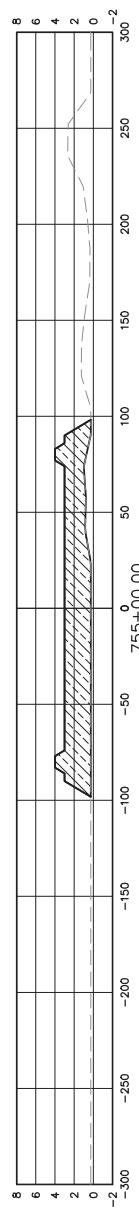
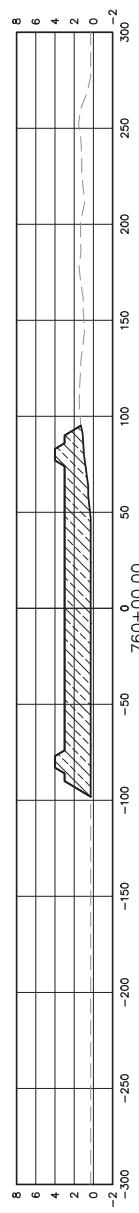
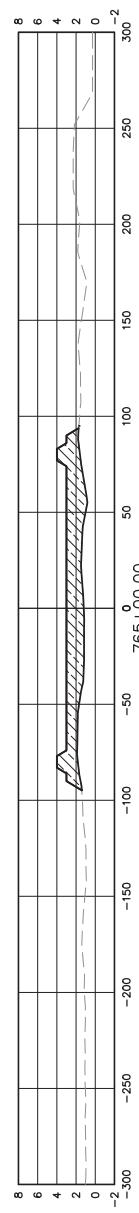
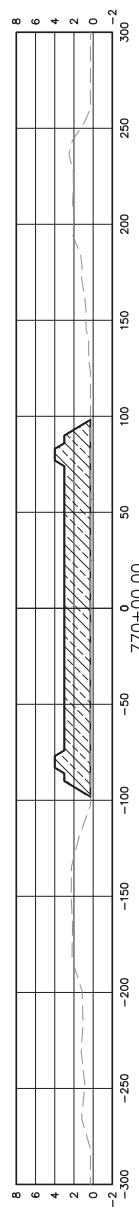
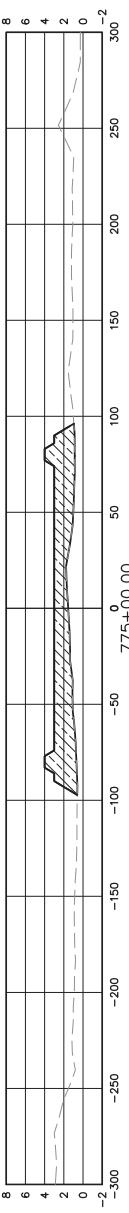
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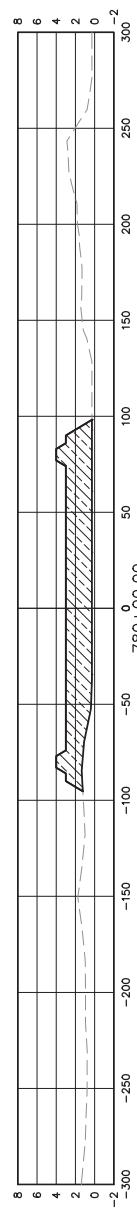
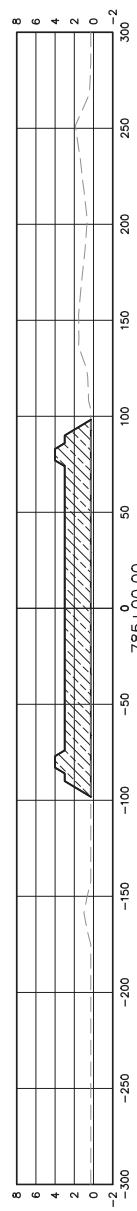
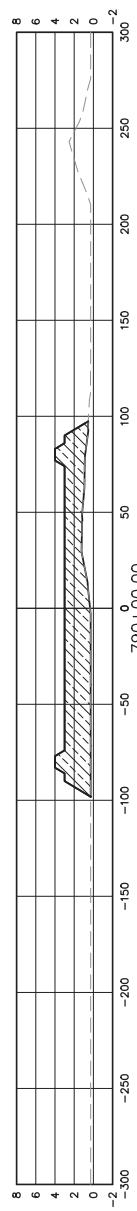
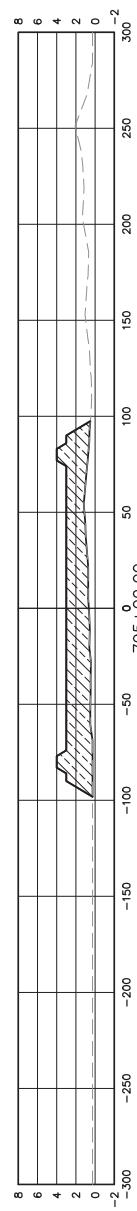
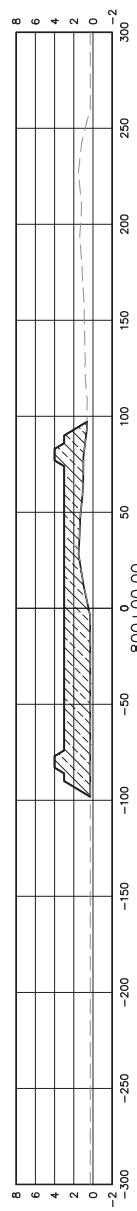
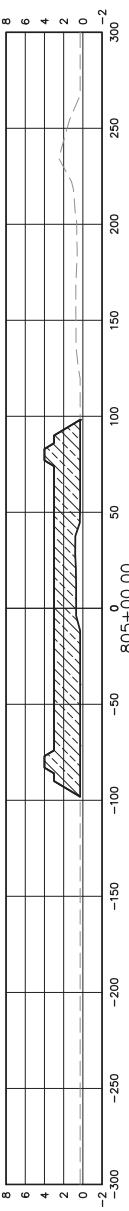
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DESIGNER	CHEKED
DETAILD	TRAINEE, LA, 70001 504-832-4878
CHIEF	242 E BENDIBORN AVE.
PTIM	ME MARTIAN CENTER



DESIGN CROSS SECTIONS  
WEST OF BARATRAIA MILEWAY  
LONG DISTANCE SEDIMENT PIPELINE  
PROJECT NO.

153455	DATE MAY 2017	SHEET NO. 608
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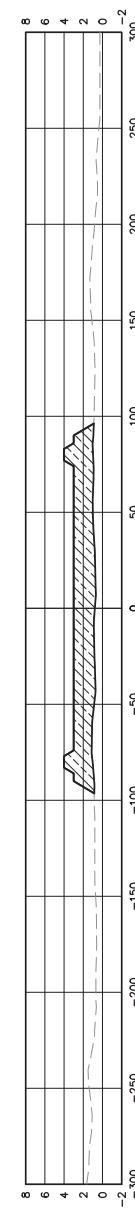
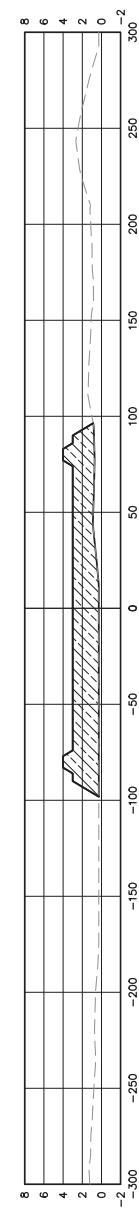
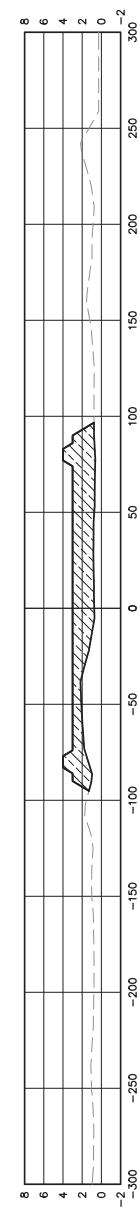
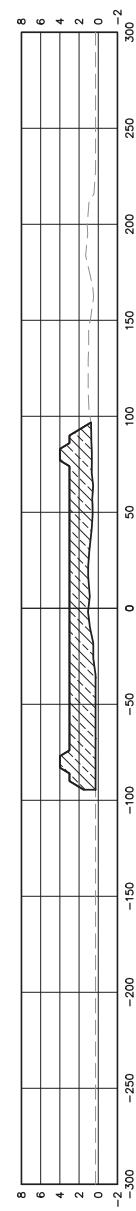
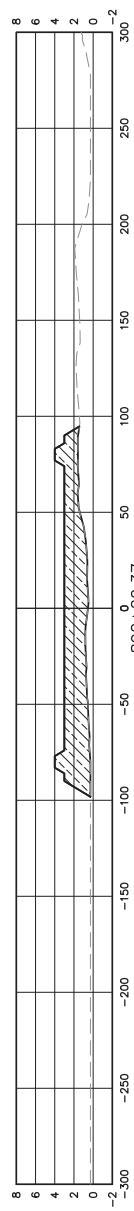
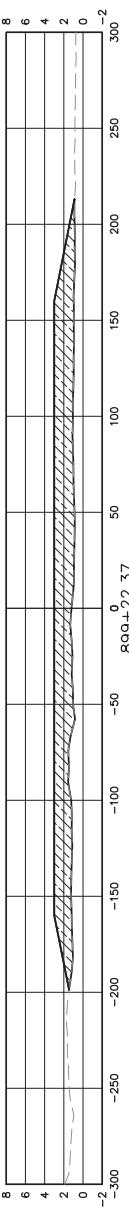
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DESIGN CROSS SECTIONS  
WEST OF BARTHARIA WATERWAY  
LONG DISTANCE SEDIMENT PIPELINE

153455	DATE MAY 2017	SHEET NO. <b>611</b>
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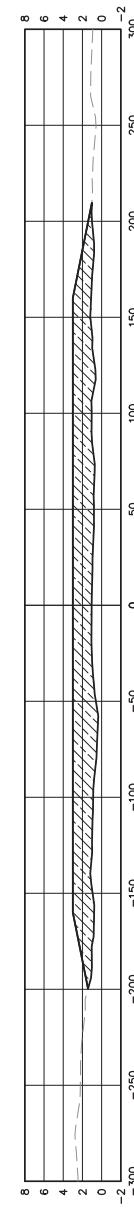
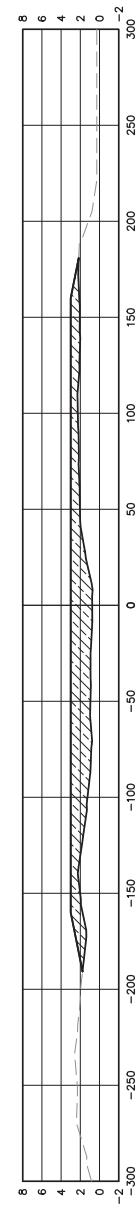
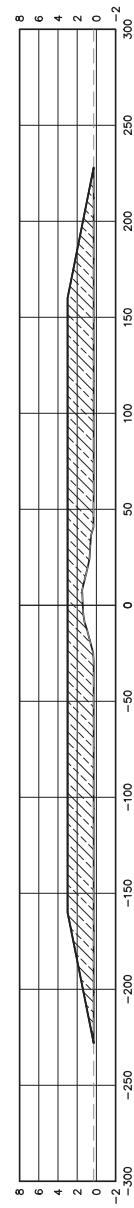
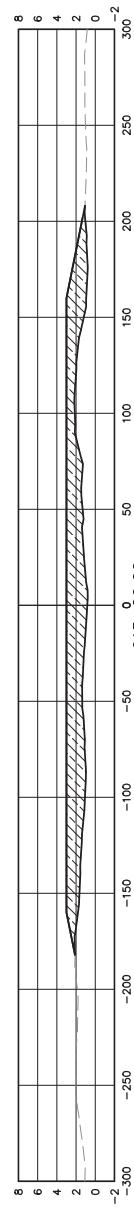
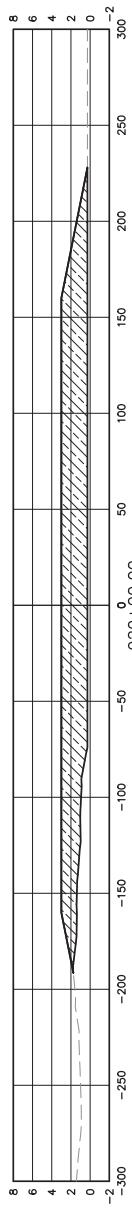
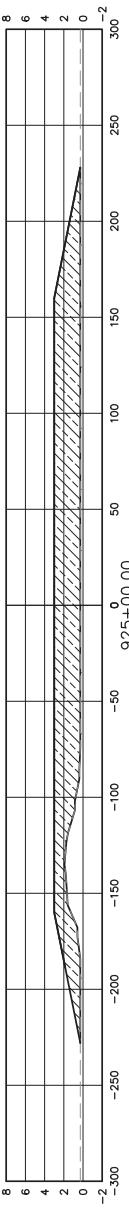
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DESIGN CROSS SECTIONS







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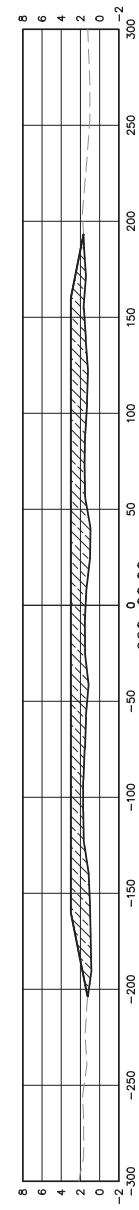
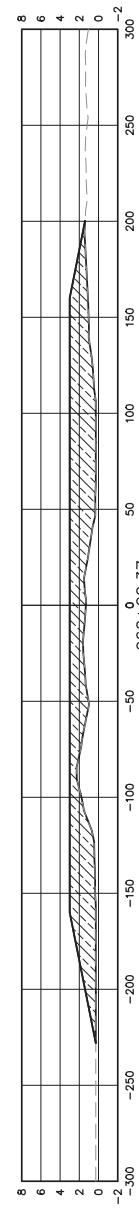
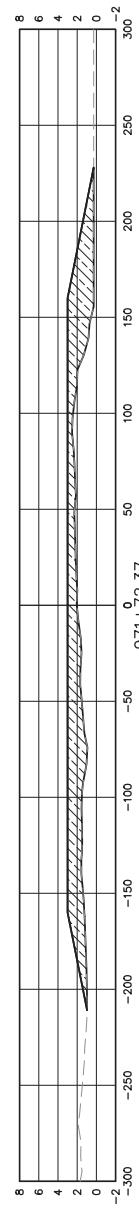
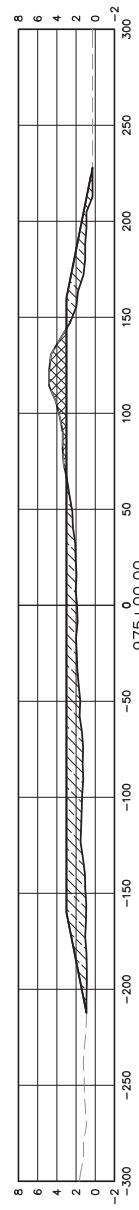
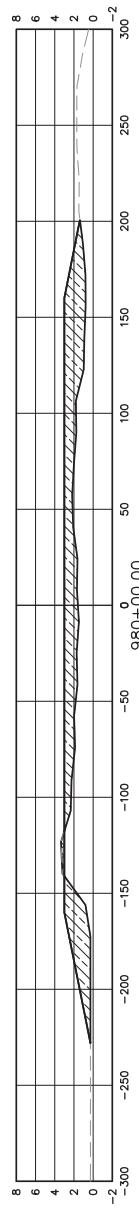
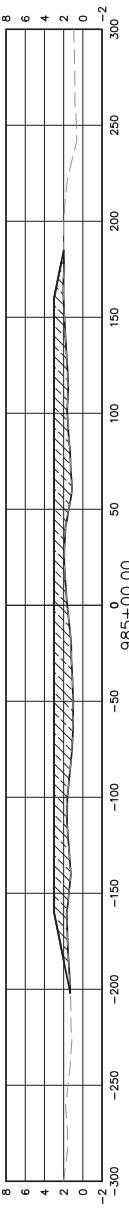
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DESIGN CROSS SECTIONS  
WEST OF BARATARIA WATERWAY  
LONG DISTANCE SEDIMENT PIPELINE

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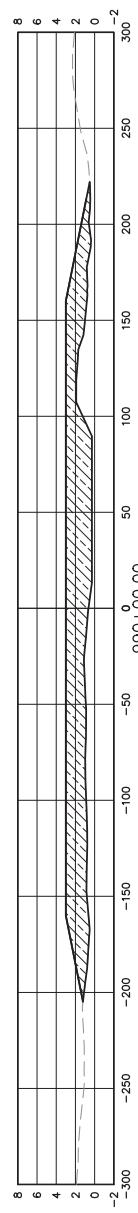
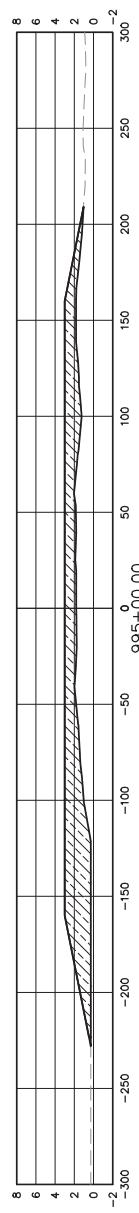
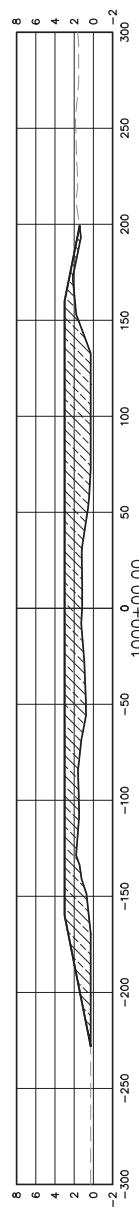
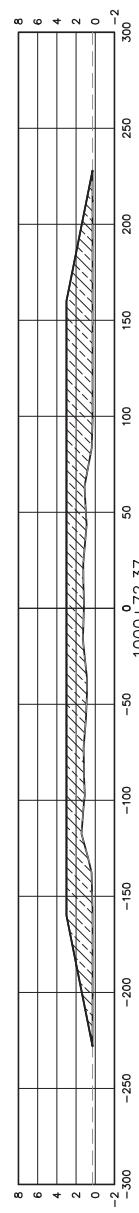
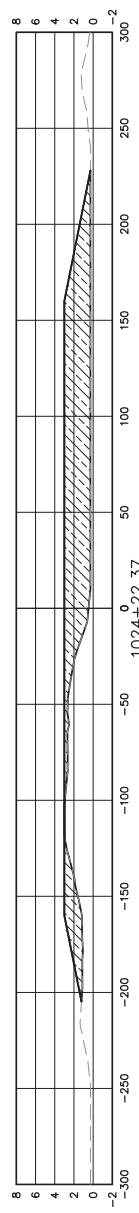
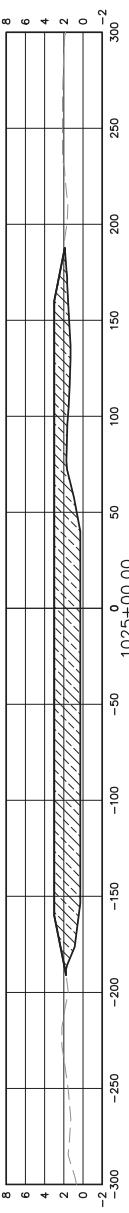
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WEST OF BARATARIA WATERWAY  
LONG DISTANCE SEDIMENT PIPELINE





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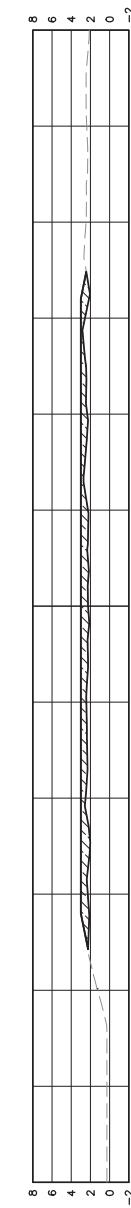
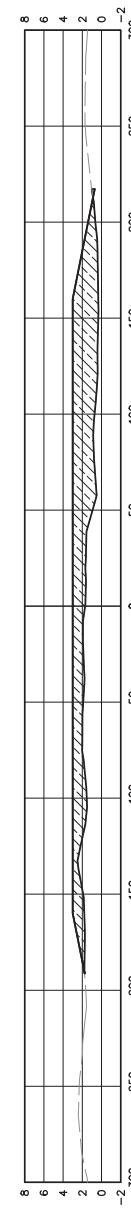
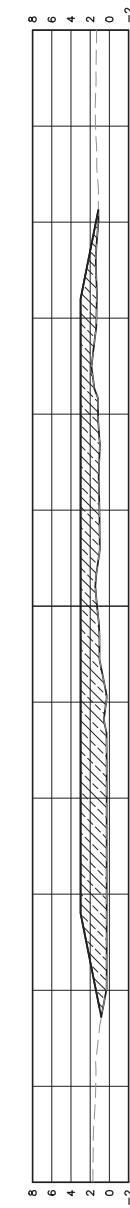
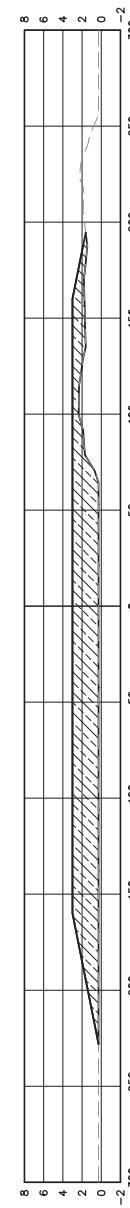
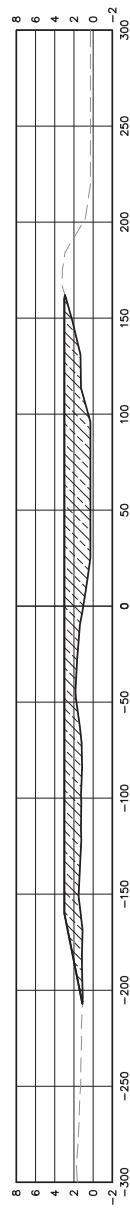
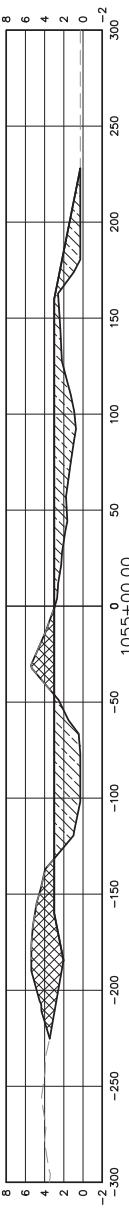
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- LONG DISTANCE SEDIMENT PIPELINE
- WEST OF BARATARIA WATERWAY
- DESIGN CROSS SECTIONS

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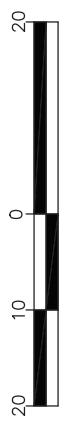
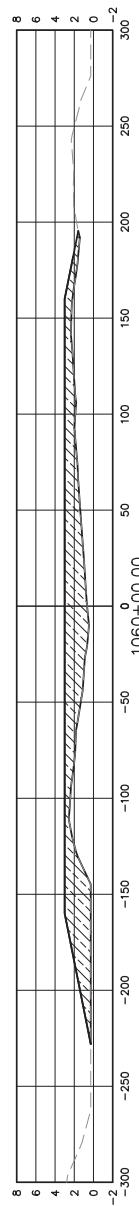
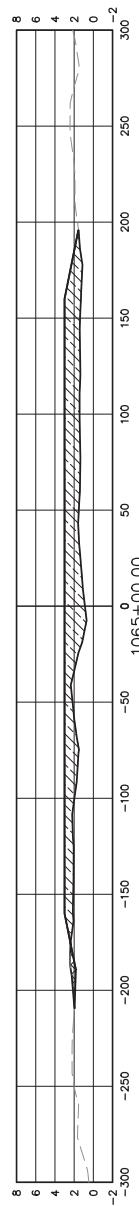
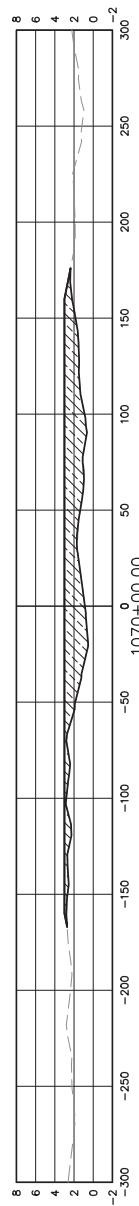
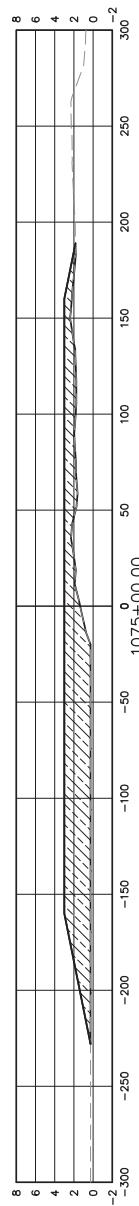
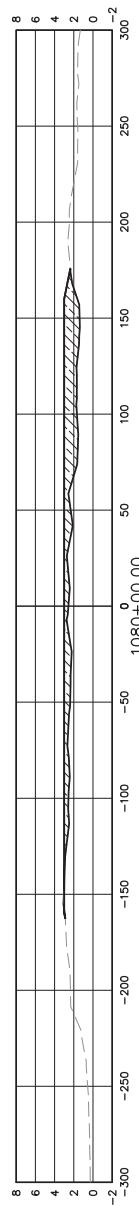
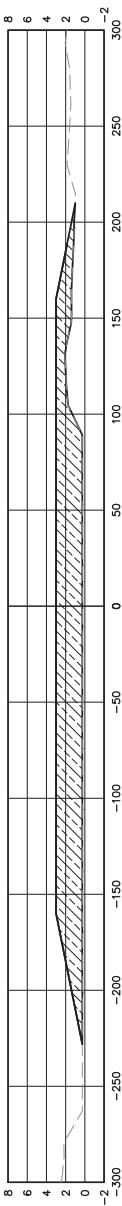
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LONG DISTANCE SEDIMENT PIPELINE

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