

DEPARTMENT OF THE ARMY U.S. ARMY CORPS OF ENGINEERS, NEW ORLEANS DISTRICT 7400 LEAKE AVENUE NEW ORLEANS LA 70118-3651

December 25, 2023

Regulatory Division
Eastern Evaluation Branch

Project Manager: Damon Morse (504) 862-2041 Damon.Morse@usace.army.mil

Application #: MVN-2022-00623-EDM

PUBLIC NOTICE

Interested parties are hereby notified that a permit application has been received by the New Orleans District of the U.S. Army Corps of Engineers pursuant to: [X] Section 10 of the Rivers and Harbors Act of March 3, 1899 (30 Stat. 1151; 33 USC 403); and/or [X] Section 404 of the Clean Water Act (86 Stat. 816; 33 USC 1344), and/or [X] Section 14 of the Rivers and Harbors Act of 1899 (33 U.S.C. Section 408)

Blue Ammonia Production Facility in Saint Charles Parish

NAME OF APPLICANT: St. Charles Clean Fuels, LLC, attn.: Kris Knudsen, 11111 Katy Freeway, Houston, Texas 77079.

LOCATION OF WORK: Located to the north of the existing International-Matex Tank Terminals (IMTT) and connects to the Mississippi River around Mile Point 119 at 11842 River Road, Saint Rose, Saint Charles Parish, Louisiana, (lat. 29.959211, long. - 90.332609), as shown within the attached drawings. (Hydrologic Unit Code 08090203; Lower Mississippi – Lake Pontchartrain).

CHARACTER OF WORK: To construct and maintain a Blue Ammonia Facility that proposes to produce, store, and ship ammonia for commercial use. The proposed ammonia facility would include the construction of access roads, two processing areas, two detention ponds, four storage tanks, a drainage servitude, and various common facilities needed for operations. A temporary barge mooring area and an access road would be constructed that is proposed to extend from the shoreline of the Mississippi River to the proposed facility. Construction of the road would require filling the batture with material for the temporary grade/slope, a temporary bridge, permanent bridge, and excavation and filling of wetlands near the proposed facility for construction access. Transportation of ammonia would require expansion and modification of the existing pipe rack that would extend from the proposed new ammonia facility, over the levee,

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and to existing docks on the Mississippi River. Modifications to the existing docks would include a pipe bridge, pipe rack, equipment platform, water intake platform, dock extensions, walkways, dock supports, and dolphins. The entire project is expected to permanently impact approximately **220 acres** of jurisdictional wetlands and waters of the United States.

<u>MITIGATION:</u> If a DA permit is issued for the proposed work, the applicant has agreed to purchase mitigation credits through an approved mitigation bank to offset the direct adverse impacts to jurisdictional wetlands.

The comment period on the requested Department of the Army Permit will close 30 days from the date of this public notice. Written comments, including suggestions for modifications or objections to the proposed work, stating reasons thereof, are being solicited from anyone having interest in this permit request, and must be submitted so as to be received before or by the last day of the comment period. Letters and/or comments concerning the subject permit application must reference the Applicant's Name and the Permit Application Number and can be preferably emailed to the Corps of Engineer's project manager listed above or forwarded to the Corps of Engineers at the address above, **ATTENTION: REGULATORY DIVISION, RGE, Damon Morse.** The Branch Chief will review the request and the requester will be promptly notified of the decision to grant or deny the request. If granted, the time extension will be continuous and inclusive of the initial comment period and will not exceed a total of 30 calendar days. This public notice is also available for review online at https://go.usa.gov/xennJ.

Corps of Engineers Permit Criteria

The decision whether to issue a permit will be based on an evaluation of the probable impacts, including cumulative impacts of the proposed activity on the public interest. That decision will reflect the national concern for both protection and utilization of important resources. The benefit which reasonably may be expected to accrue from the proposal must be balanced against its reasonably foreseeable detriments. All factors which may be relevant to the proposal will be considered including the cumulative effects thereof; among those are conservation, economics, aesthetics, general environmental concerns, wetlands, historic properties, fish and wildlife values, flood hazards, floodplain values, land use, navigation, shoreline erosion and accretion, recreation, water supply and conservation, water quality, energy needs, safety, food and fiber production, mineral needs, considerations of property ownership and, in general, the needs and welfare of the people.

This request will also be reviewed pursuant to Section 408 and USACE Engineering Circular (EC) 1165-2-220, which provides policy and procedural guidance for processing requests to alter USACE civil works projects.

The decision whether to grant permission for the requested alteration will be based on several factors. The benefits that reasonably may be expected to accrue from the proposal will be balanced against its reasonably foreseeable detriments. Review of the requests for modification will be reviewed by a USACE technical review team considering the following factors:

- 1) Potential to Impair the Usefulness of the Project. Proposed alterations will be reviewed to determine whether the alteration would limit the ability of the USACE project to function as authorized, or would compromise or change any authorized project conditions, purposes or outputs. If USACE determines that the usefulness of the authorized project would be impaired, the request will be denied.
- 2) Potential to be Injurious to the Public Interest. Proposed alterations will be reviewed to determine the probable impacts, including cumulative impacts, on the public interest. Factors that may be relevant to the public interest depend upon the type of USACE project being altered and may include, but are not limited to, such things as conservation, economic development, historic properties, cultural resources, environmental impacts, water supply, water quality, flood hazards, floodplains, residual risk, induced damages, navigation, shore erosion or accretion, and recreation. This evaluation will consider information received from the interested parties, including tribes, agencies, and the public. The decision whether to approve an alteration will be determined by the consideration of whether benefits are commensurate with risks. If the potential detriments are found to outweigh the potential benefits, then it may be determined that the proposed alteration is injurious to the public interest.

The U.S. Army Corps of Engineers is soliciting comments from area residents, the public, federal, state, and local agencies and officials, Indian Tribes, and other interested parties in order to consider and evaluate the impacts of this proposed activity. Any comments received will be considered by the U.S. Army Corps of Engineers to determine whether to make, modify, condition, or deny a permit for this proposal. To make this decision, comments are used to assess impacts on communities with Environmental Justice concerns, endangered species, historic properties, water quality, general environmental effects, and other public interest factors listed above. Comments are used in the preparation of an Environmental Assessment and/or an Environmental Impact Statement pursuant to the National Environmental Policy Act. Comments are also used to determine the need for a public hearing and to determine the overall public interest of the proposed activity. Further, all factors that may be relevant to the proposal will be considered, including the potential cumulative effects associated with the proposed project. The Section 408 review will consider the potential impact to the usefulness of the Federal project and whether the proposed alteration would be injurious to the public interest. Policy and legal compliance will also be considered.

The possibility exists that the proposed work may damage or destroy presently unknown archeological, scientific, prehistorical, historical sites, or data. As deemed necessary, copies of this public notice will be sent to the State Archeologist, State Historic Preservation Officer, and federally listed tribes regarding potential impacts to cultural resources.

Our initial finding is that the proposed work would have no effect on any species listed as endangered by the U.S. Department of Commerce, nor affect any habitat designated as critical to the survival and recovery of any such species.

The New Orleans District has determined that the work is located in waters known to be utilized by the Pallid Sturgeon (*Scaphirhynchus albus*) and concluded the activity is not likely to adversely affect this species based on the Information Planning and Consultation (IPaC) tool for Endangered Species in Louisiana, as signed on January 27, 2020, between the U.S. Army Corps of Engineers, New Orleans and the U.S. Fish and Wildlife Service.

This notice initiates the Essential Fish Habitat (EFH) consultation requirements of the Magnuson-Stevens Fishery Conservation and Management Act. The applicant's proposal may result in the destruction, alteration, and/or disturbance of **N/A** acres of EFH utilized by various life stages of red drum and penaeid shrimp. Our initial determination is that the proposed action would not have a substantial adverse impact on EFH or federally managed fisheries in the Gulf of Mexico. Our final determination relative to project impacts and the need for mitigation measures is subject to review by and coordination with the National Marine Fisheries Service.

If the proposed work involves deposits of dredged or fill material into navigable waters, the evaluation of the probable impacts will include the application of guidelines established by the Administrator of the Environmental Protection Agency. Also, a certification that the proposed activity will not violate applicable water quality standards will be required from the LA Department of Environmental Quality before a Department of the Army permit is issued.

Any person may request, (preferably by email to the project manager, or in writing), within the comment period specified in this notice, that a public hearing be held to consider this application. Requests for public hearings shall state, with particularity, the reasons for holding a public hearing.


The applicant has certified that the proposed activity described in the application complies with and will be conducted in a manner that is consistent with the Louisiana Coastal Resources Program (Louisiana Coastal Zone Application P20230672). The Department of the Army permit will not be issued unless the applicant received approval or a waiver of the Coastal Use Permit by the Department of Natural Resources.

You are invited to communicate the information contained in this notice to any other parties whom you deem likely to have interest in the matter.

Brad P. LaBorde Chief, Eastern Evaluation Branch Regulatory Division

Enclosures



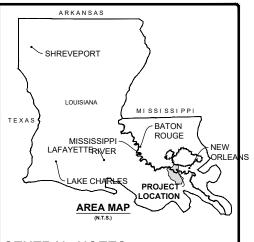

GENERAL NOTES:

- PRIOR TO COMMENCEMENT OF WORK, THE CONTRACTOR SHALL ENSURE ALL APPLICABLE PERMITS ARE SECURED & THE LOUISIANA ONE CALL SYSTEM HAS BEEN CONTACTED.
- ALL ELEVATIONS REFER TO NAVD 88 UNLESS NOTED
- THE USACE FEATURES REPRESENTED ARE BASED ON THE APPROVED JURISDICTIONAL DETERMINATION ISSUED WITH THE USACE, DATED MONTH DAY YEAR.
- MULTIPLE DESIGNERS ARE RESPONSIBLE FOR THIS WORK, AS
 - PROPOSED IMPROVEMENTS FOR SHIP DOCK DESIGNED. SEE PLANS PREPARED BY LANIER & ASSOCIATES FOR DETAILS.
 - PROPOSED IMPROVEMENTS FOR THE TEMPORARY HEAVY HAUL DOCK DESIGNED. SEE PLANS PREPARED BY MAMMOET FOR DETAILS.

ST. CHARLES PARISH LATITUDE: 29° 57' 26" N LONGITUDE: 90° 20' 01" W



SCALE IN FEET

3,000' 1,500' 3,000'

PREPARER: **KMB** REVIEWER: SMT ISSUE DATE: 08-14-2023

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PRELIMINARY FOR PERMIT PURPOSES ONLY

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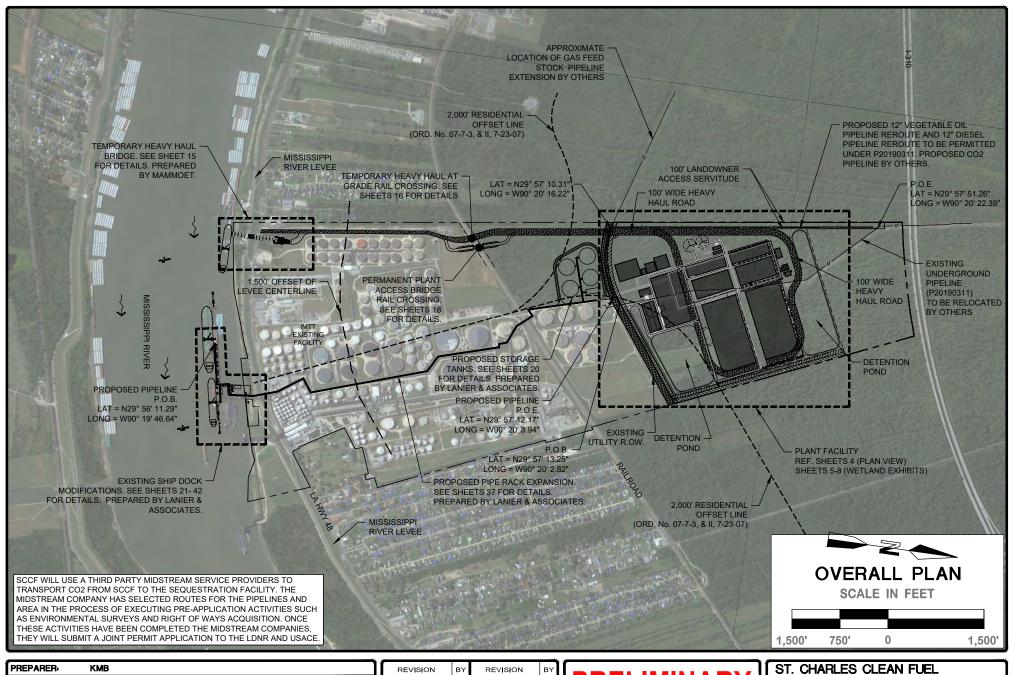
Scott M. Tabary LA PE #40541

ST. CHARLES CLEAN FUEL ST. ROSE, LOUISIANA

ST. CHARLES PARISH

SHEET NUMBER

A-1 OF A-42





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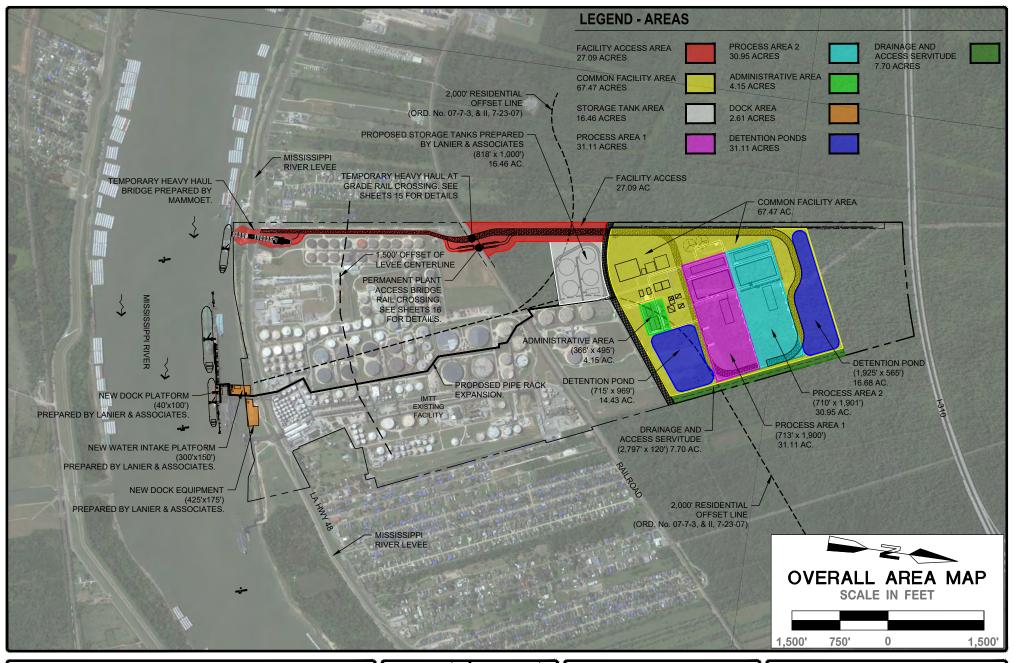
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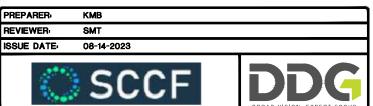
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ST. CHARLES PARISH

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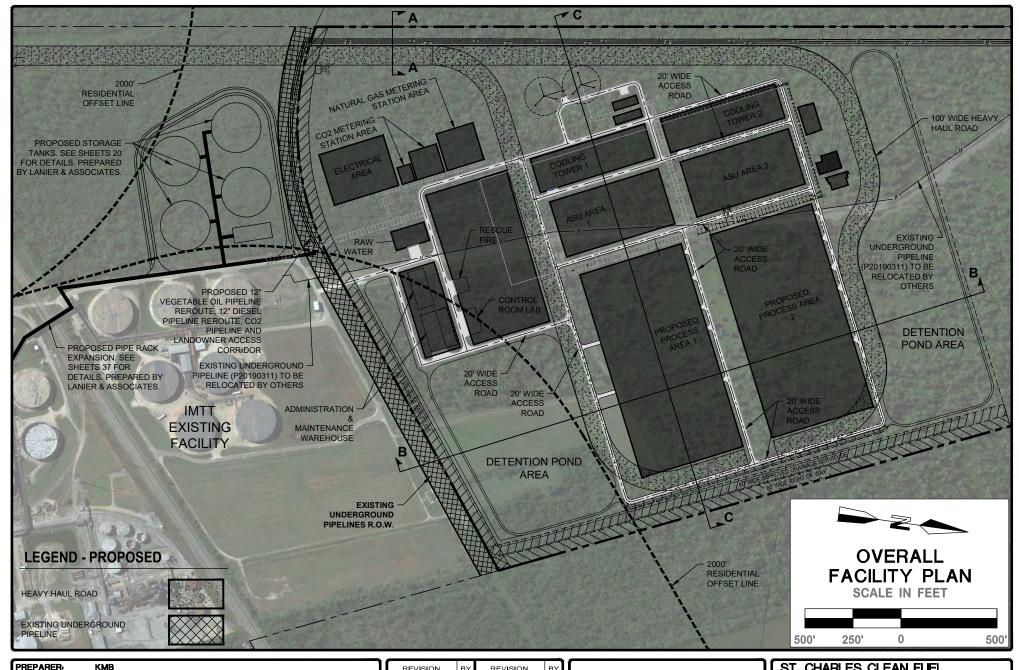


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ST. CHARLES CLEAN FUEL ST. ROSE, LOUISIANA ST. CHARLES PARISH
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FACILITY SITE PERMIT DRAWING





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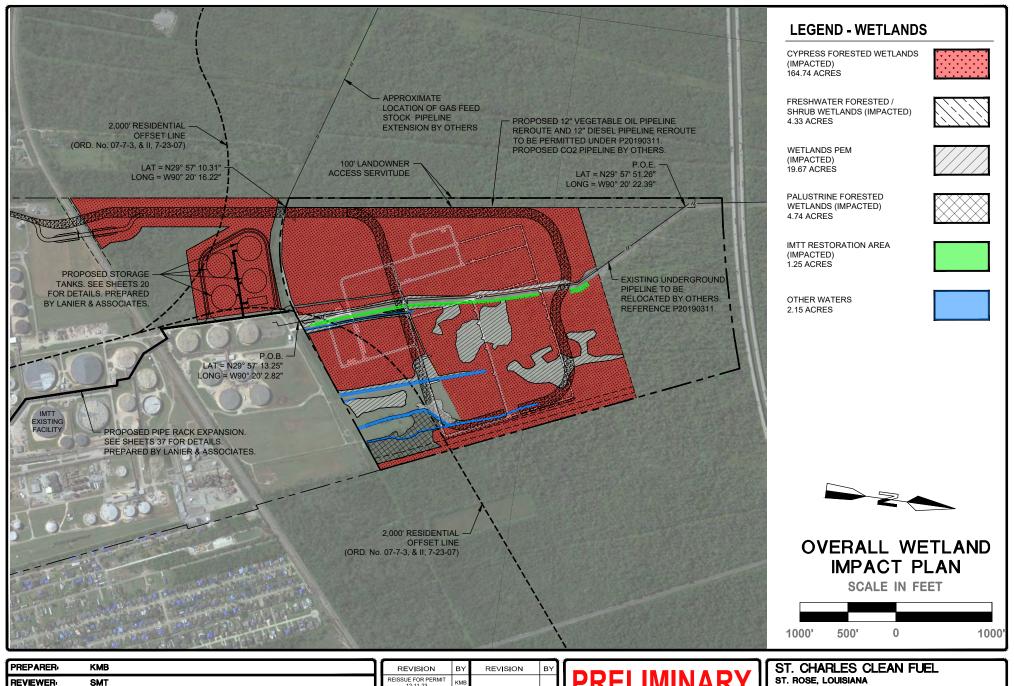
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ST. ROSE, LOUISIANA ST. CHARLES PARISH

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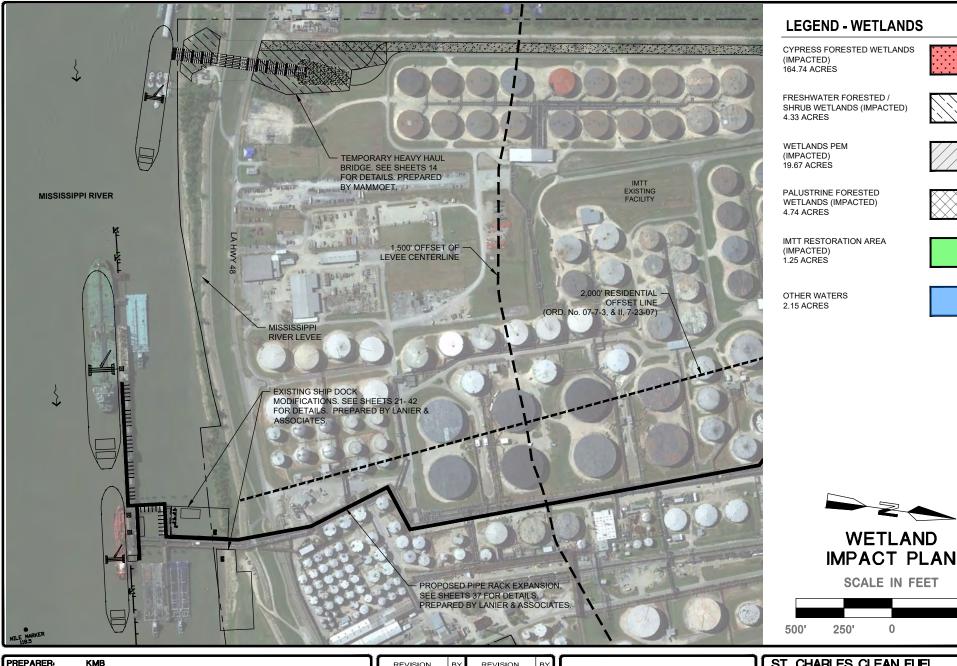
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Scott M. Tabary LA PE #40541

ST. CHARLES PARISH

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A-5 OF A-42



PREPARER:	КМВ	
REVIEWER:	SMT	
ISSUE DATE:	08-14-2023	
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Duplantis Design Group, P.C.

LA PE #40541


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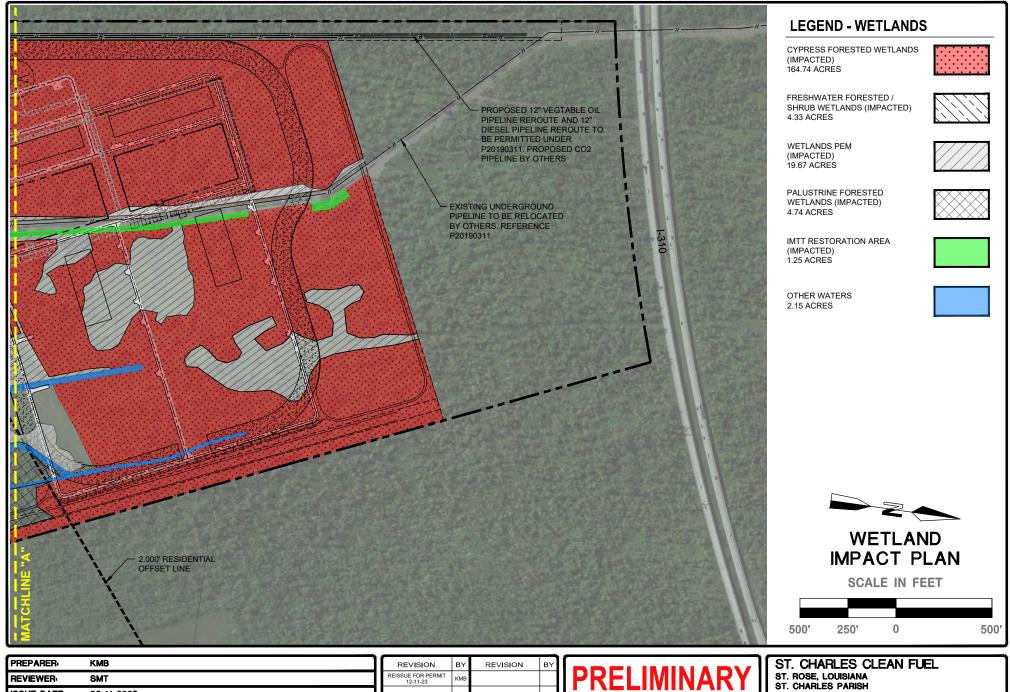
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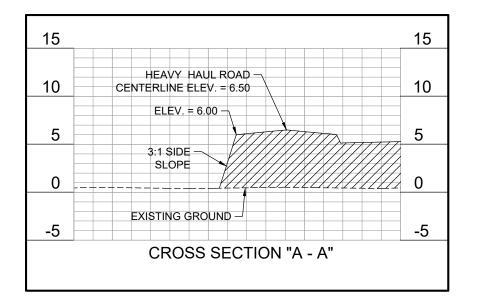
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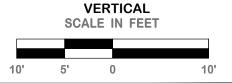


AREA TO BE EXCAVATED AND MATERIAL TO BE HAULED OFF



HEAVY HAUL ROAD CROSS SECTION



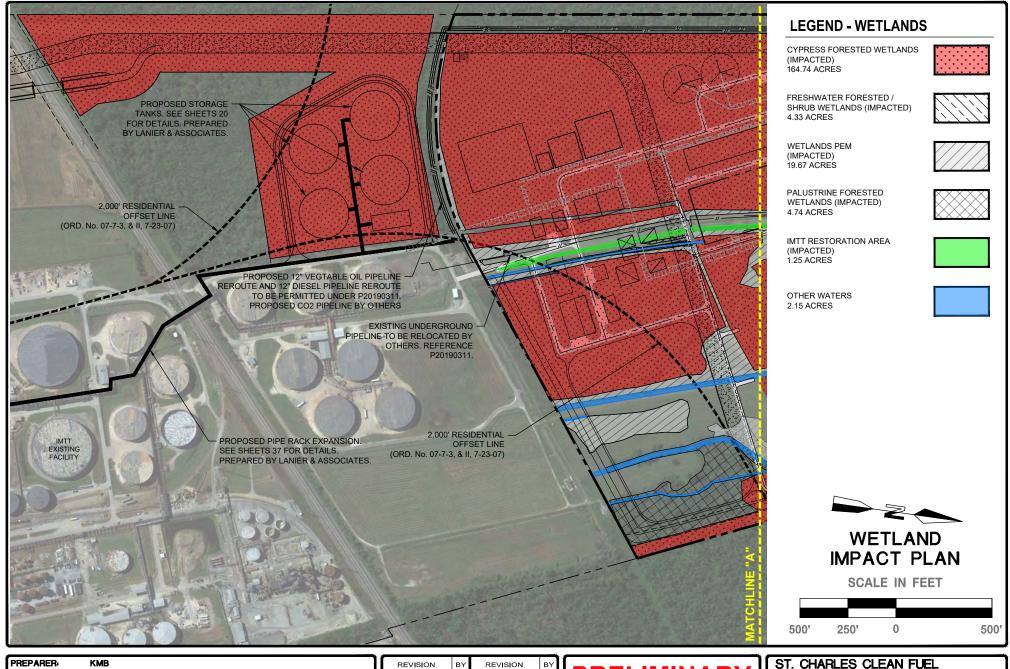

PREPARER:	КМВ	
REVIEWER:	SMT	
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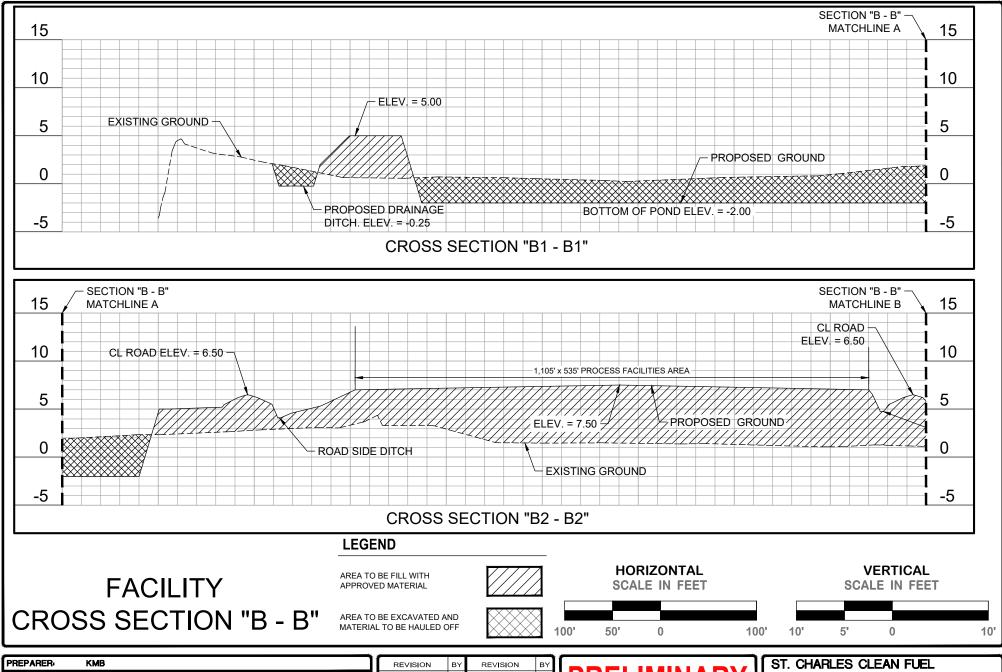
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ST. ROSE, LOUISIANA ST. CHARLES PARISH

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A-9 OF A-42







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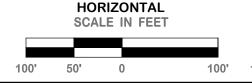



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AREA TO BE EXCAVATED AND MATERIAL TO BE HAULED OFF



FACILITY CROSS SECTION "B - B"

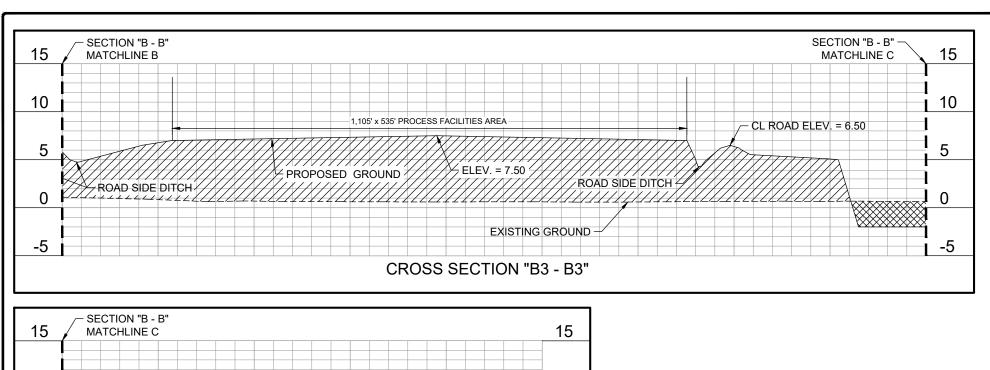

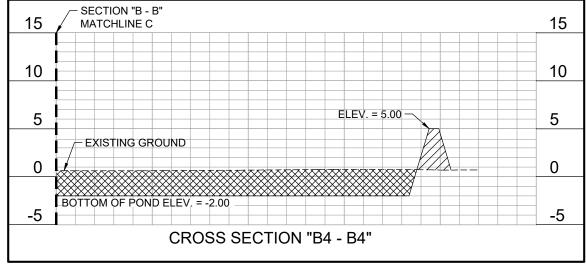
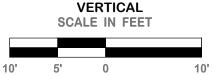
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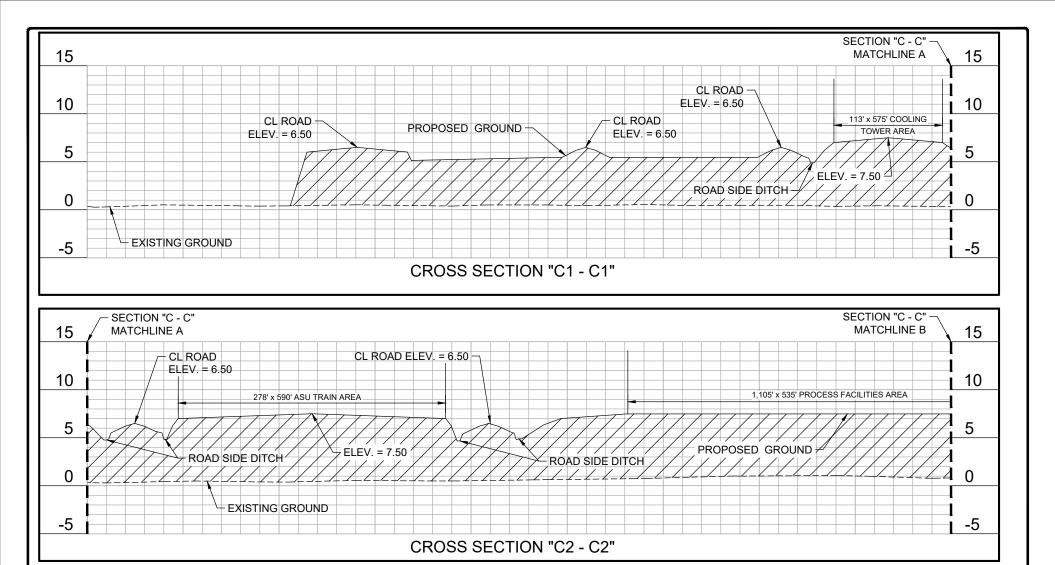
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ST. CHARLES CLEAN FUEL ST. ROSE, LOUISIANA ST. CHARLES PARISH

SHEET NUMBER: A-11 OF A-42



FACILITY
CROSS SECTION "C - C"

AREA TO BE FILL WITH APPROVED MATERIAL

AREA TO BE EXCAVATED AND MATERIAL TO BE HAULED OFF

100'

HORIZONTAL SCALE IN FEET

0

50'

VERTICAL
SCALE IN FEET

10' 5' 0 10'

PREPARER: KMB
REVIEWER: SMT
ISSUE DATE: 08-14-2023

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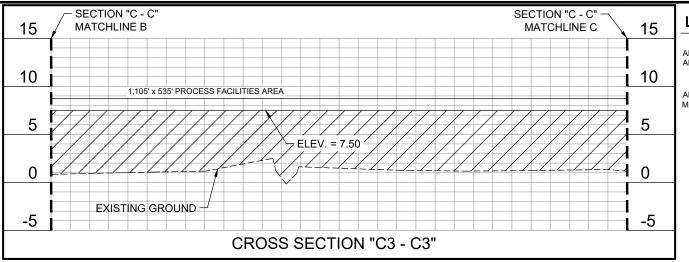
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A-12 OF A-42




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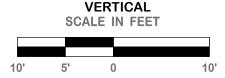
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FACILITY
CROSS SECTION "C - C"





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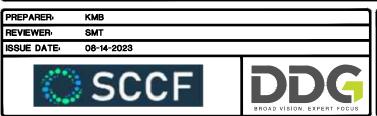
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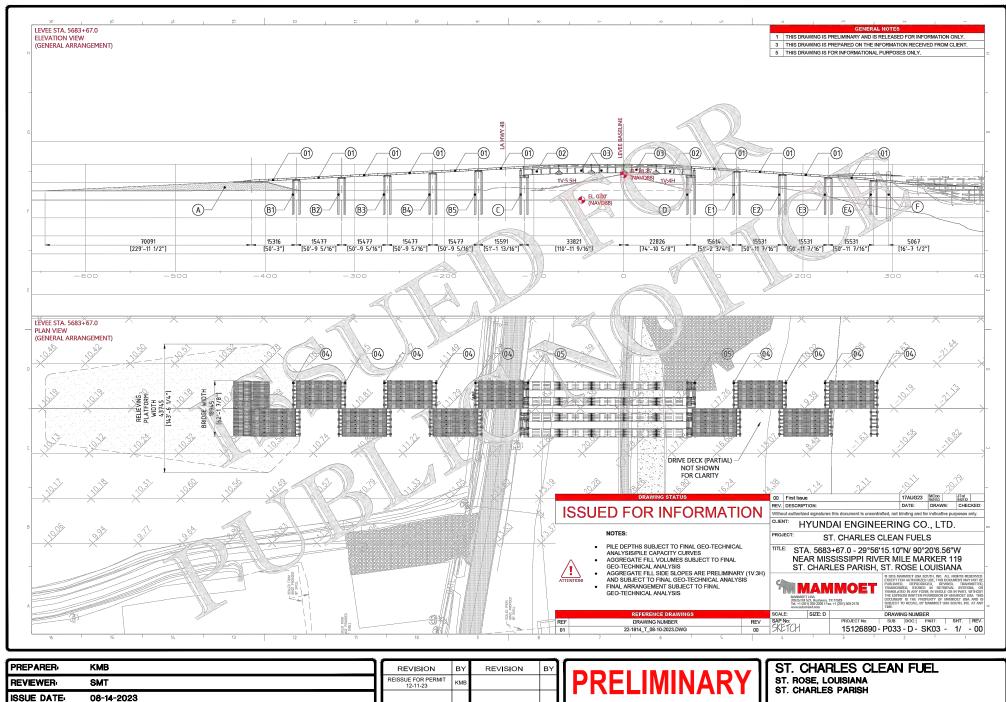
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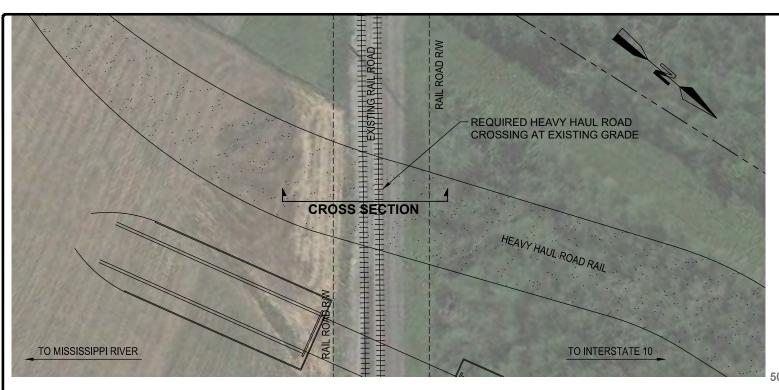

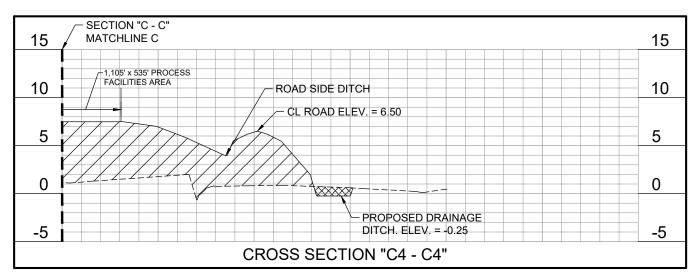
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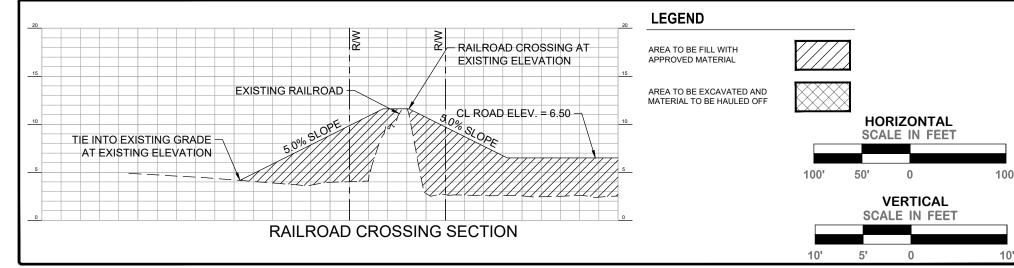
A-15 OF A-42



HEAVY HAUL ROAD RAIL CROSSING

SCALE IN FEET







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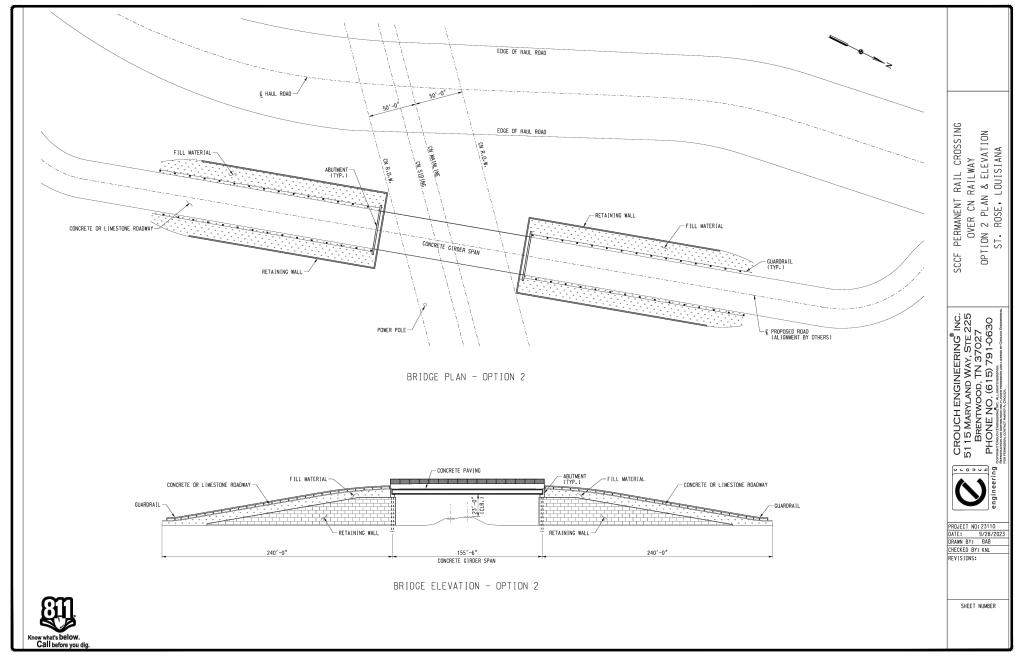
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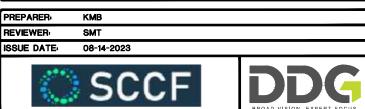
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SHEET NUMBER A-16 OF A-42

> **FACILITY SITE** PERMIT DRAWING

10'





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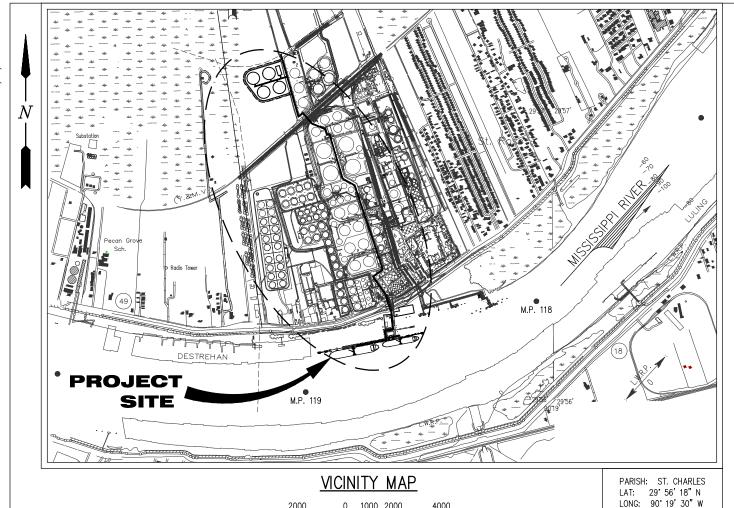
Scott M. Tabary LA PE #40541 Duplantis Design Group, P.C.

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OT DOOR LOUIGIANIA					

ST. ROSE, LOUISIANA ST. CHARLES PARISH

SHEET NUMBER:

A-17 OF A-42



1000 2000

(IN FEET)

NOTES

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AS-BUILT DRAWINGS WILL BE SUBMITTED WITHIN 30 DAYS OF COMPLETION OF THIS PROJECT TO THE LOUISIANA DEPARTMENT OF NATURAL RESOURCES, OFFICE OF CONSERVATION, PIPELINE DIVISION, P. O. BOX 94275 BATON ROUGE, LA 70804, AND TO THE LOUISIANA DEPARTMENT OF NATURAL RESOURCES, COASTAL MANAGEMENT DIVISION, P. O. BOX 44487, BATON ROUGE, LA

4000

- 2. ALL STRUCTURES, FACILITIES, WELL AND PIPELINES/FLOWLINES OCCURRING IN OPEN WATER ARE AS OR IN OILFIELD CANALS OR SLIPS SHALL BE REMOVED WITHIN 120 DAYS OF ABANDONMENT OR THE FACILITIES FOR THE HEREIN PERMITTED USE UNLESS PRIOR WRITTEN APPROVAL TO LEAVE SUCH STRUCTURES IN PLACE IS RECEIVED FROM THE COASTAL MANAGEMENT DIVISION. THIS CONDITION DOES NOT PRECLUDE THE NECESSITY FOR REVISING THE CURRENT PERMIT OR OBTAINING A SEPARATE COASTAL USE PERMIT, SHOULD ONE BE REQUIRED.
- 3. STRUCTURES MUST ALSO BE MARKED/LIGHTED IN ACCORDANCE WITH U. S. COAST GUARD REGULATIONS.
- IN ORDER TO ENSURE THE SAFETY OF ALL PARTIES, THE PERMITTEE SHALL CONTACT THE LOUISIANA ONE CALL SYSTEM (1-800-272-3020) A MINIMUM OF 48 HOURS PRIOR TO THE COMMENCEMENT OF ANY EXCAVATION (DIGGING, DREDGING, JETTING, ETC.) OR DEMOLITION ACTIVITY.
- NO IMPACTS TO RARE, THREATENED OR ENDANGERED SPECIES OR CRITICAL HABITATS ARE ANTICIPATED FROM THE PROPOSED PROJECT. NO STATE OR FEDERAL PARKS, WILDLIFE REFUGES, WILDLIFE MANAGEMENT AREAS OR SCENIC RIVERS ARE KNOWN AT THE SPECIFIED SITE OR WITHIN 1/4 MILE OF THE PROPOSED PROJECT. THE WILDLIFE DIVERSITY PROGRAM (WDP) REPORTS SUMMARIZE THE EXISTING INFORMATION KNOWN AT THE TIME OF THE REQUEST REGARDING THE LOCATION IN QUESTION. WDP REPORTS SHOULD NOT BE CONSIDERED FINAL STATEMENTS ON THE BIOLOGICAL ELEMENTS OR AREAS BEING CONSIDERED, NOR SHOULD THEY BE SUBSTITUTED FOR ON-SITE SURVEYS REQUIRED FOR ENVIRONMENTAL ASSESSMENTS. IF AT ANY TIME WPD TRACKED SPECIES ARE ENCOUNTERED WITHIN THE PROJECT AREA, PLEASE CONTACT OUR BIOLOGIST AT 225-763-3554.
- THE AREA WHERE THE PROJECT IS LOCATED IS ALL PART OF THE ABORIGINAL HOMELANDS OF THE CHITIMACHA TRIBE OF LOUISIANA. AS SUCH, LARGE VILLAGES, BURIAL SITES AND SACRED SITES WERE IN PLACE IN THAT ENTIRE AREA. IF AT ANY TIME DURING THE COURSE OF THE WORK, ANY TRADITIONAL CULTURAL PROPERTIES ARE DISCOVERED, PERMITTEE SHALL IMMEDIATELY CONTACT KIMBERLY S. WALDEN (CULTURAL DIRECTOR) OR MELANIE AYMOND (RESEARCH COORDINATOR) AT 337-923-9923 OR 337-923-4395.

 OFFICE HOURS ARE MONDAY THROUGH THURSDAY FROM 7:30 AM - 5:00 PM AND ON FRIDAY BETWEEN 7:30 AM - 11:30 AM. IF TRADITIONAL CULTURAL PROPERTIES ARE DISCOVERED ON THE WEEKEND OR AFTER BUSINESS HOURS, THE NOTIFICATION SHALL BE MADE THE NEXT BUSINESS MORNING.



JOHN P. LEONARD P.E. LA PE #39467

PRELIMINARY - FOR PERMITTING PURPOSES ONLY, NOT FOR CONSTRUCTION

ST. ROSE

IMTT LOUISIANA

BLUE AMMONIA PROJECT

VICINITY MAP, AREA MAP & NOTES

DATE JULY 2023 DESIGN TPM DRAWN CHECK. JDM 12512 JOB NO. SHEET No. A-18 of A-42


LANIER & ASSOCIATES CONSULTING ENGINEERS

INCORPORATED

LA: EF-1120 TX: F-2981

NEW ORLEANS • BEAUMONT • CORPUS CHRISTI • HOUSTON



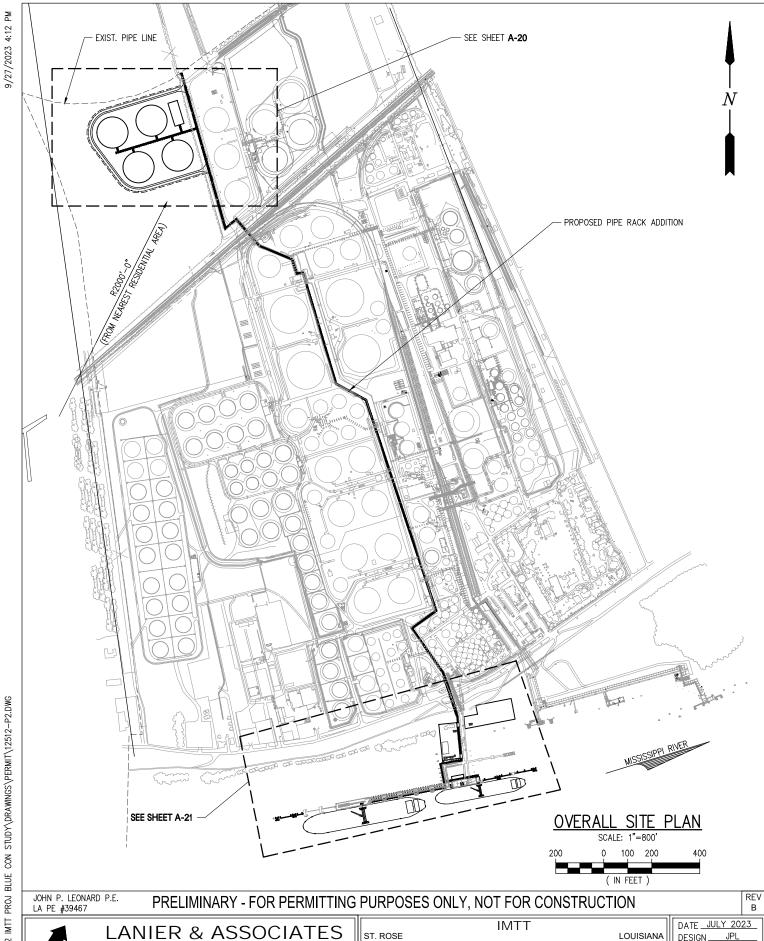

LANIER & ASSOCIATES **CONSULTING ENGINEERS**

INCORPORATED LA: EF-1120


TX: F-2981 NEW ORLEANS • BEAUMONT • CORPUS CHRISTI • HOUSTON **BLUE AMMONIA PROJECT**

OVERALL SITE PLAN

DESIGN TPM DRAWN CHECK _ 12512 JOB NO_ SHEET No.

A-19 of A-42



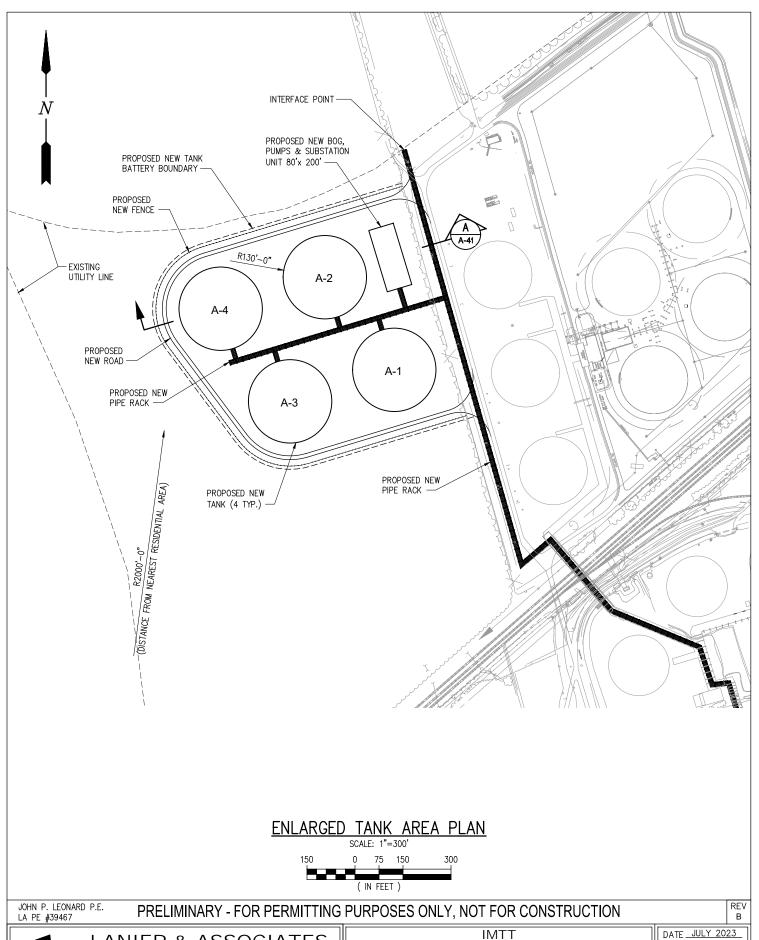

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LA: EF-1120 TX: F-2981 NEW ORLEANS • BEAUMONT • CORPUS CHRISTI • HOUSTON

ST. ROSE

BLUE AMMONIA PROJECT

ENLARGED TANK AREA PLAN


DATE JULY 2023 DESIGN ТРМ DRAWN CHECK. JDM 12512

LOUISIANA

JOB NO_ SHEET No.

A-20 of A-42



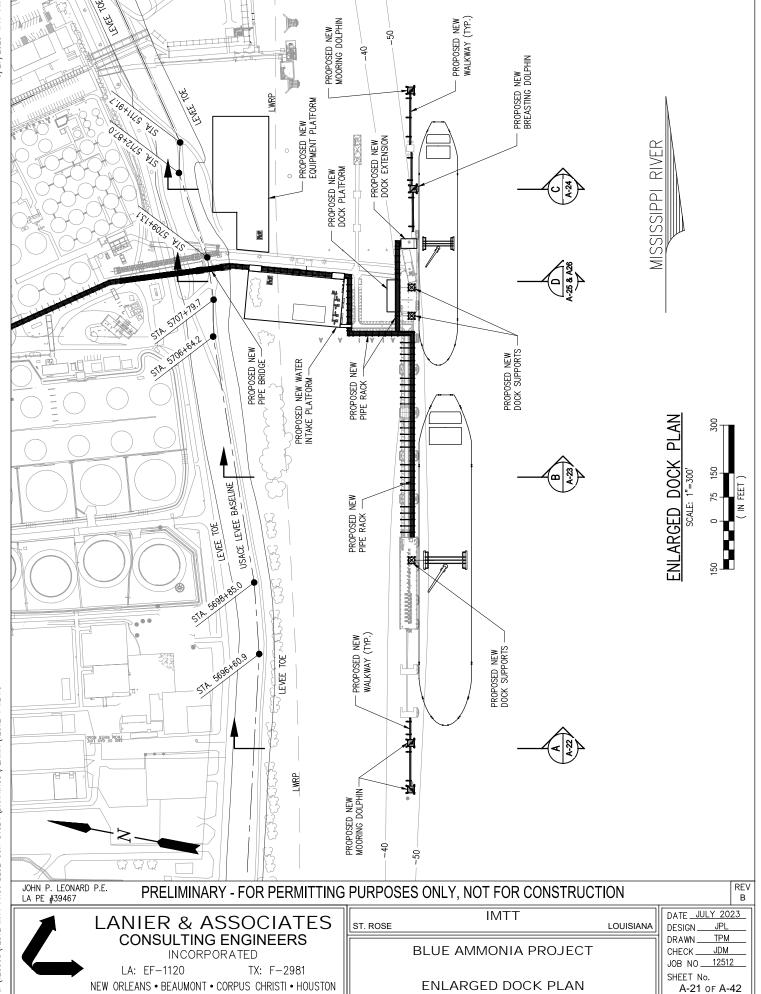




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TX: F-2981

LA: EF-1120



DRAWN

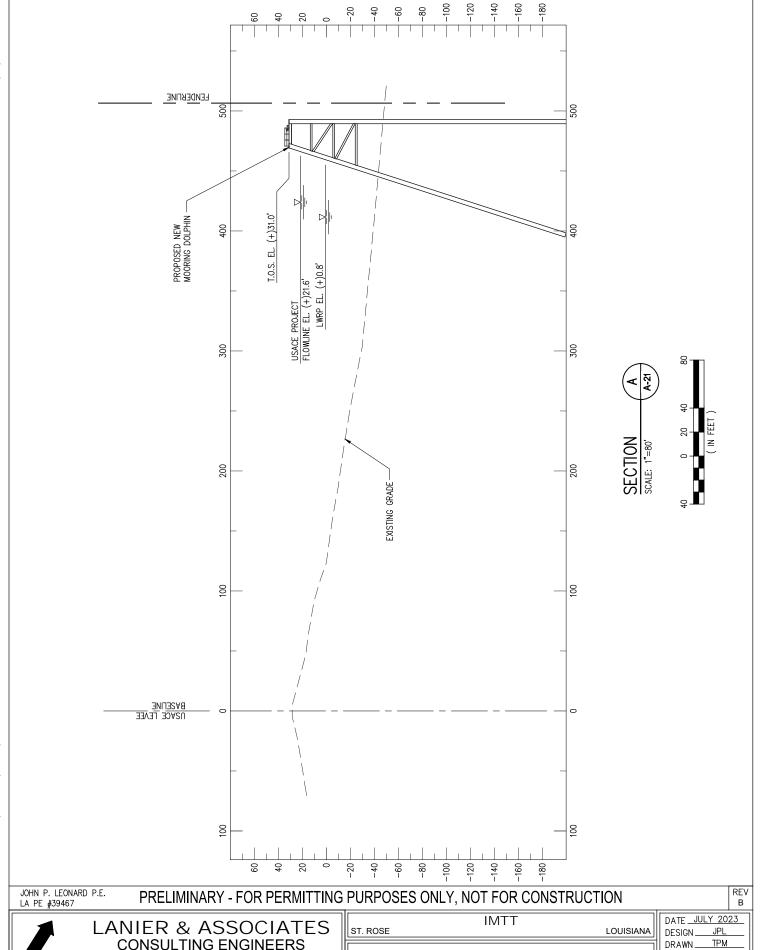CHECK.

JOB NO_

JDM


12512

SHEET No. A-22 OF A-42

BLUE AMMONIA PROJECT

CROSS SECTION

SECTION A

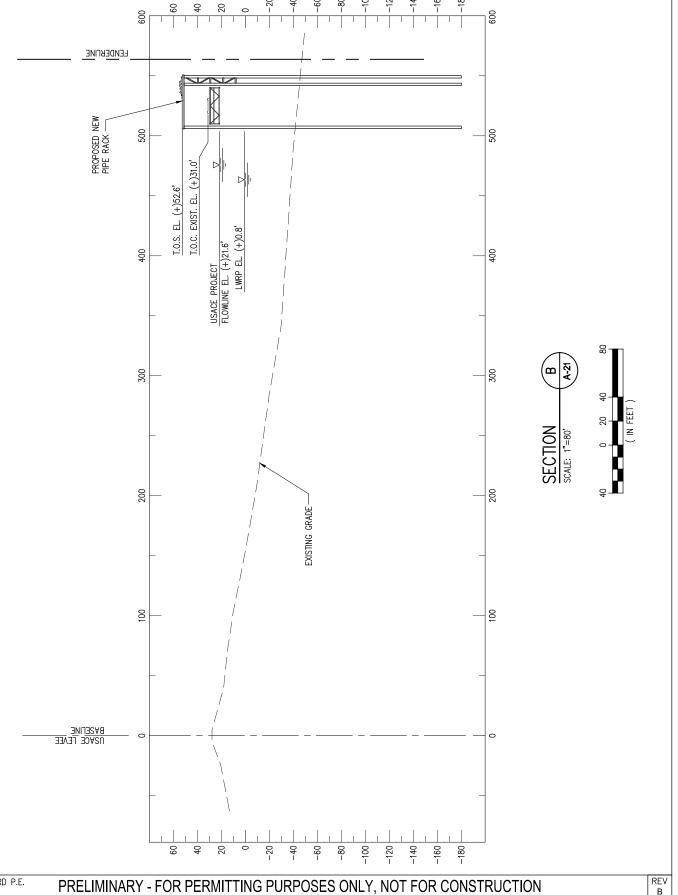

JOHN P. LEONARD P.E. LA PE #39467

ST. ROSE

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INCORPORATED LA: EF-1120

TX: F-2981 NEW ORLEANS • BEAUMONT • CORPUS CHRISTI • HOUSTON **BLUE AMMONIA PROJECT CROSS SECTION SECTION B**

IMTT


DATE JULY 2023 DESIGN JPL TPM DRAWN CHECK. JDM 12512

JOB NO_ SHEET No. A-23 of A-42

LOUISIANA

LENDEBLINE

700

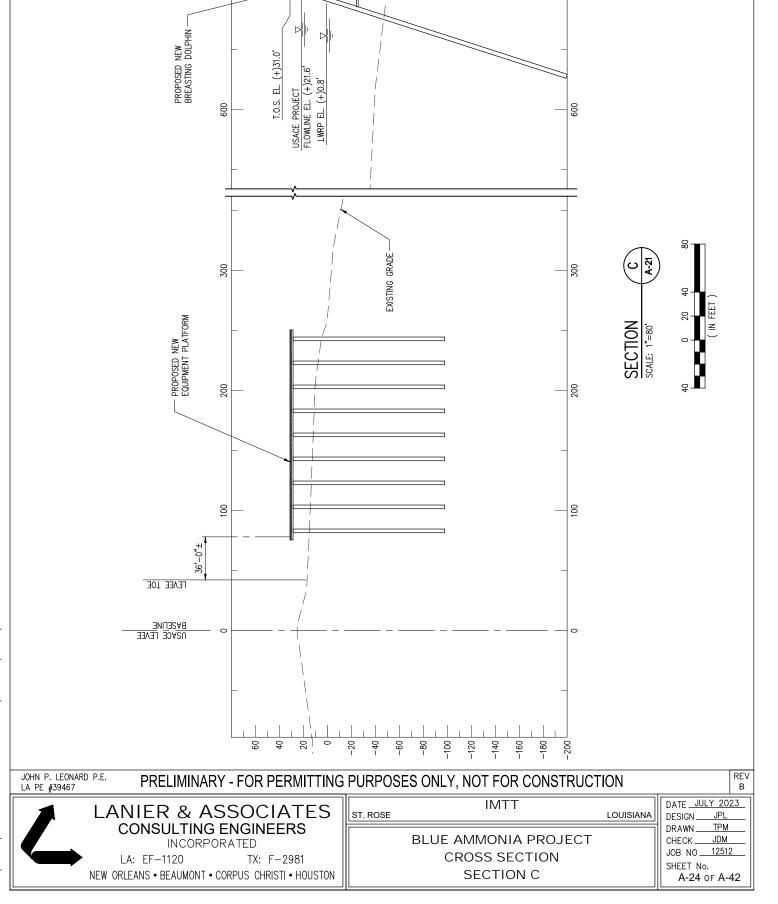

-200

700



LA: EF-1120 TX: F-2981 NEW ORLEANS • BEAUMONT • CORPUS CHRISTI • HOUSTON **CROSS SECTION**

IMTT LOUISIANA

DATE JULY 2023 **DESIGN** TPM DRAWN CHECK. JDM JOB NO_ 12512 SHEET No. A-25 OF A-42

SCALE: 1"=80'

BLUE AMMONIA PROJECT SECTION D (1 OF 2)

EXISTING GRADE J:\12000S\12512 IMTT PROJ BLUE CON STUDY\DRAWINGS\PERMIT\12512-P8.DWG -20 9 20 -40 9 JOHN P. LEONARD P.E. LA PE #39467 PRELIMINARY - FOR PERMITTING PURPOSES ONLY, NOT FOR CONSTRUCTION LANIER & ASSOCIATES ST. ROSE **CONSULTING ENGINEERS** INCORPORATED

PROPOSED NEW LANDSIDE PIPE RACK BENT (TYP.) 1300 1300 1400

200

300

400

09-

4 20

(MIN.)

MATCHLINE - (SHEET A-26)

€ RIVER ROAD

200

300


400

PROPOSED NEW PIPE BRIDGE

1500

-100



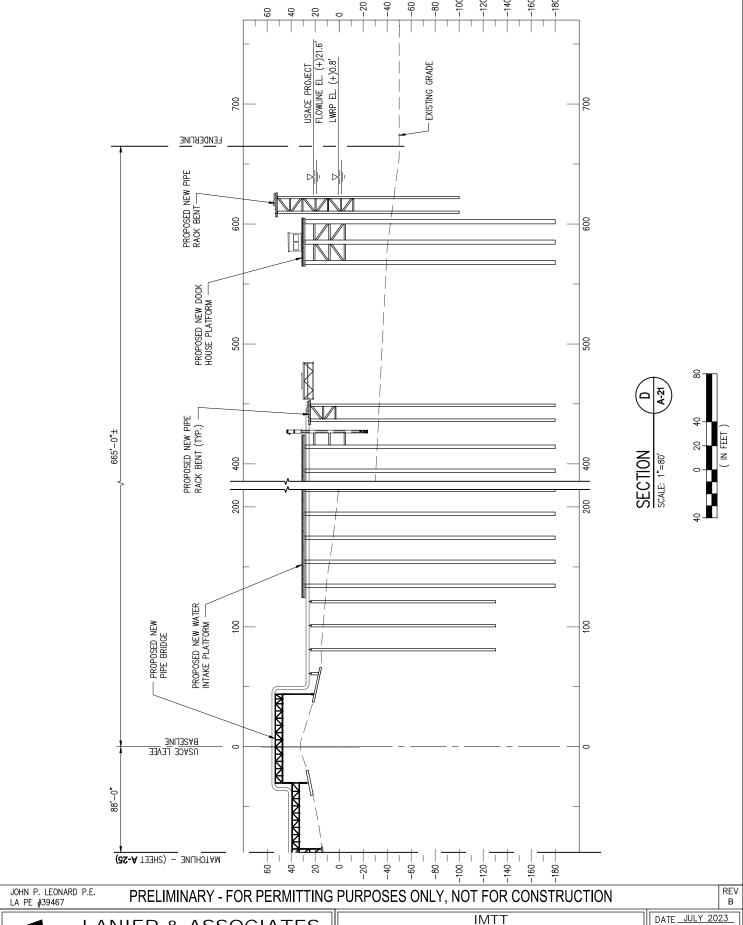

ST. ROSE

LANIER & ASSOCIATES CONSULTING ENGINEERS


NEW ORLEANS • BEAUMONT • CORPUS CHRISTI • HOUSTON

INCORPORATED

LA: EF-1120 TX: F-2981

BLUE AMMONIA PROJECT CROSS SECTION SECTION D (2 OF 2) DATE <u>JULY 2023</u>
DESIGN <u>JPL</u>
DRAWN <u>TPM</u>
CHECK <u>JDM</u>
JOB NO <u>12512</u>
SHEET No.
A-26 OF A-42

LOUISIANA

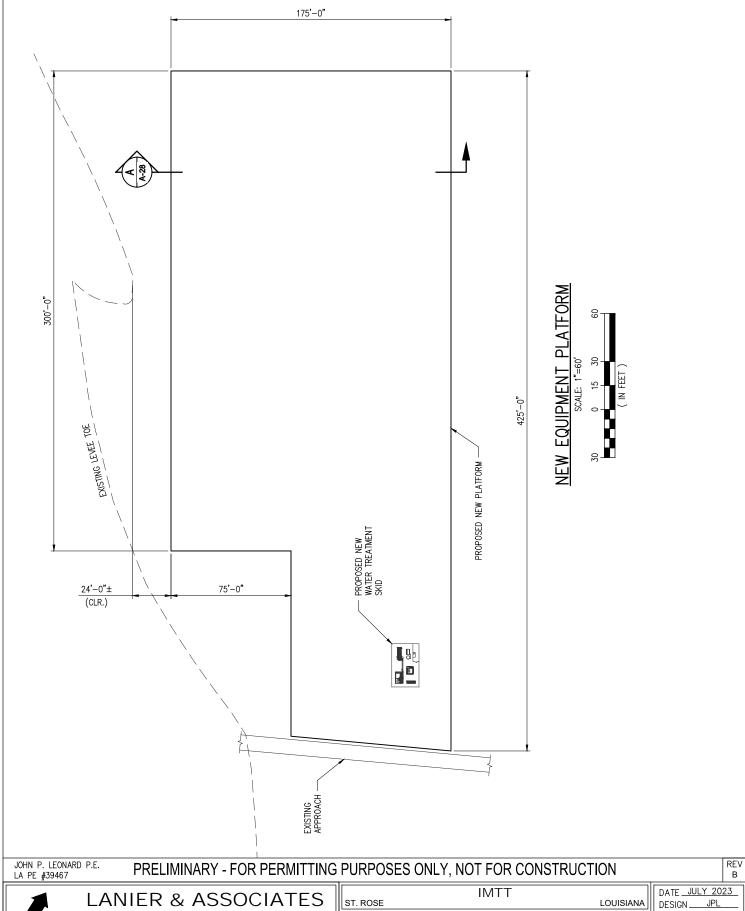

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LA: EF-1120


TX: F-2981 NEW ORLEANS • BEAUMONT • CORPUS CHRISTI • HOUSTON

TPM DRAWN CHECK. JDM JOB NO_ 12512

BLUE AMMONIA PROJECT NEW EQUIPMENT PLATFORM PLAN

SHEET No. A-27 OF A-42



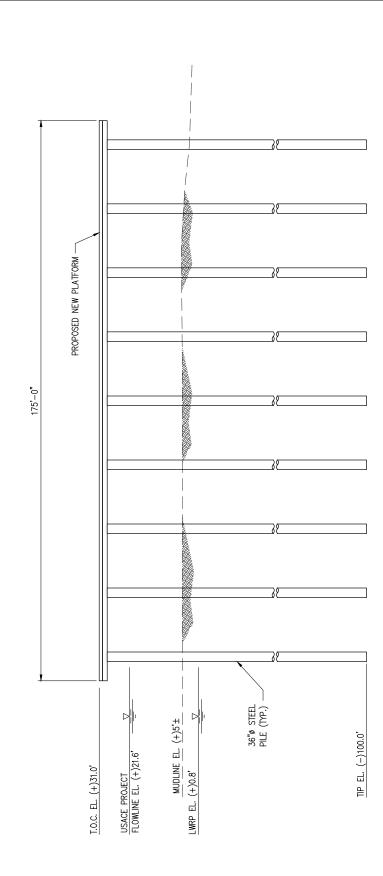



JOHN P. LEONARD P.E. LA PE #39467

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TX: F-2981 LA: EF-1120 NEW ORLEANS • BEAUMONT • CORPUS CHRISTI • HOUSTON

BLUE AMMONIA PROJECT NEW EQUIPMENT PLATFORM SECTION


DATE JULY 2023 **DESIGN** TPM DRAWN CHECK. JDM

LOUISIANA

JOB NO 12512 SHEET No. A-28 OF A-42

IMTT ST. ROSE



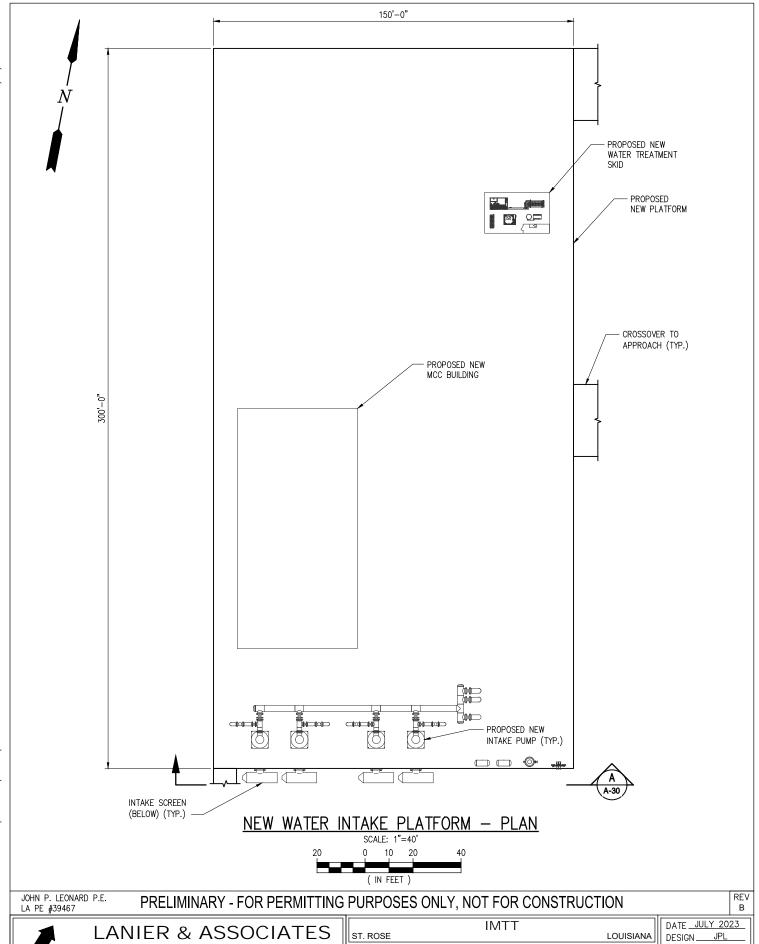

CONSULTING ENGINEERS


INCORPORATED

LA: EF-1120 TX: F-2981 NEW ORLEANS • BEAUMONT • CORPUS CHRISTI • HOUSTON

BLUE AMMONIA PROJECT NEW WATER INTAKE PLATFORM

ТРМ DRAWN CHECK. JDM 12512 JOB NO_ SHEET No. A-29 of A-42

PLAN

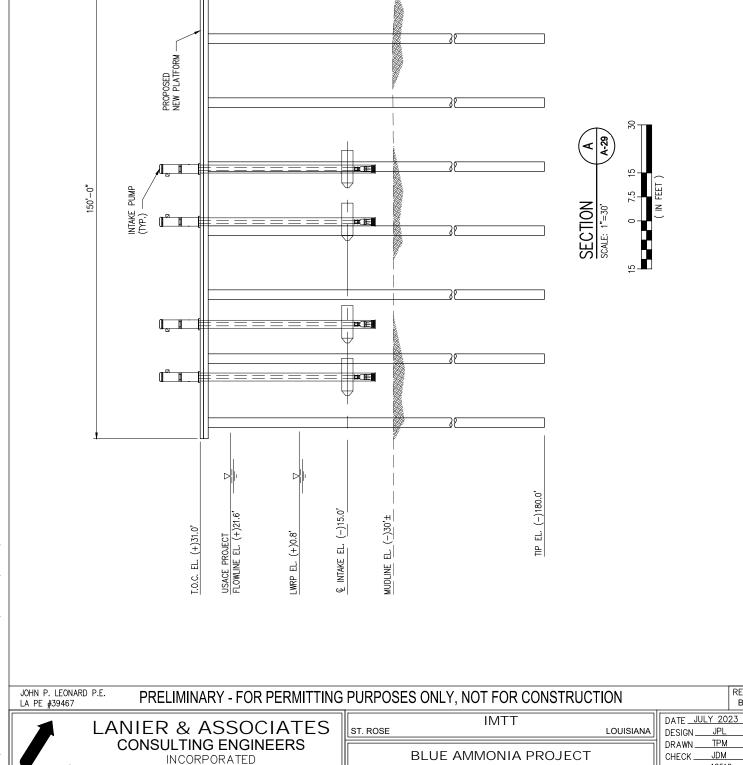

TPM

JDM

12512

JOB NO_

SHEET No. A-30 of A-42

NEW WATER INTAKE PLATFORM

SECTION

PROPOSED NEW 36"ø STEEL PILE (TYP.)


J:\12000S\12512 IMTT PROJ BLUE CON STUDY\DRAWINGS\PERMIT\12512-P13.DWG

LA: EF-1120

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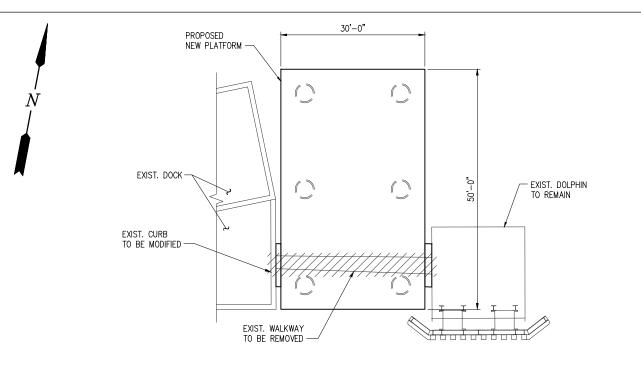
DATE JULY 2023 DESIGN ТРМ DRAWN CHECK. JDM JOB NO_ 12512 SHEET No.

A-31 of A-42

LOUISIANA

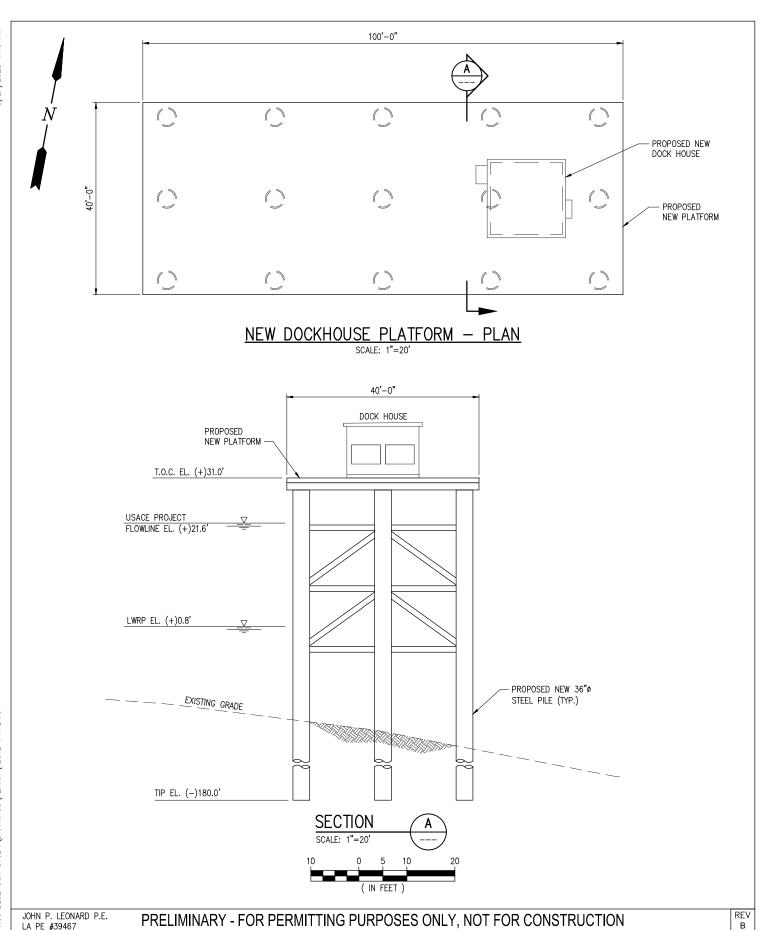
IMTT ST. ROSE

> **BLUE AMMONIA PROJECT NEW DOCKHOUSE PLATFORM PLAN & SECTION**



<u>NEW DOCK EXTENSION PLATFORM - PLAN</u>

SCALE: 1"=20'

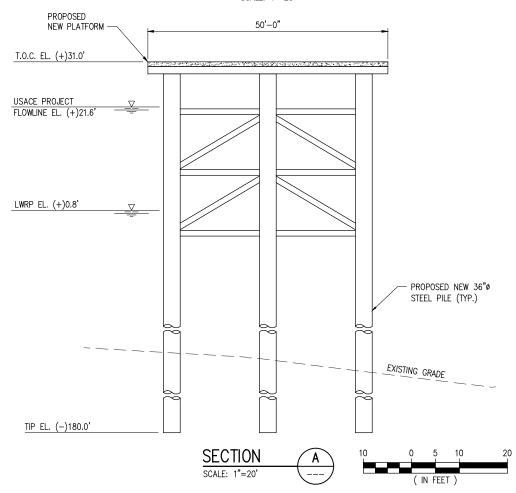

JOHN P. LEONARD P.E. LA PE #39467

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ST. ROSE

DATE JULY 2023 LOUISIANA

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INCORPORATED


LA: EF-1120 NEW ORLEANS • BEAUMONT • CORPUS CHRISTI • HOUSTON

TX: F-2981

BLUE AMMONIA PROJECT NEW DOCK EXTENSION PLATFORM **PLAN & SECTION**

IMTT


DESIGN ТРМ DRAWN CHECK. JDM 12512 JOB NO_ SHEET No. A-32 of A-42

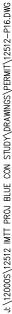

LA: EF-1120

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TX: F-2981

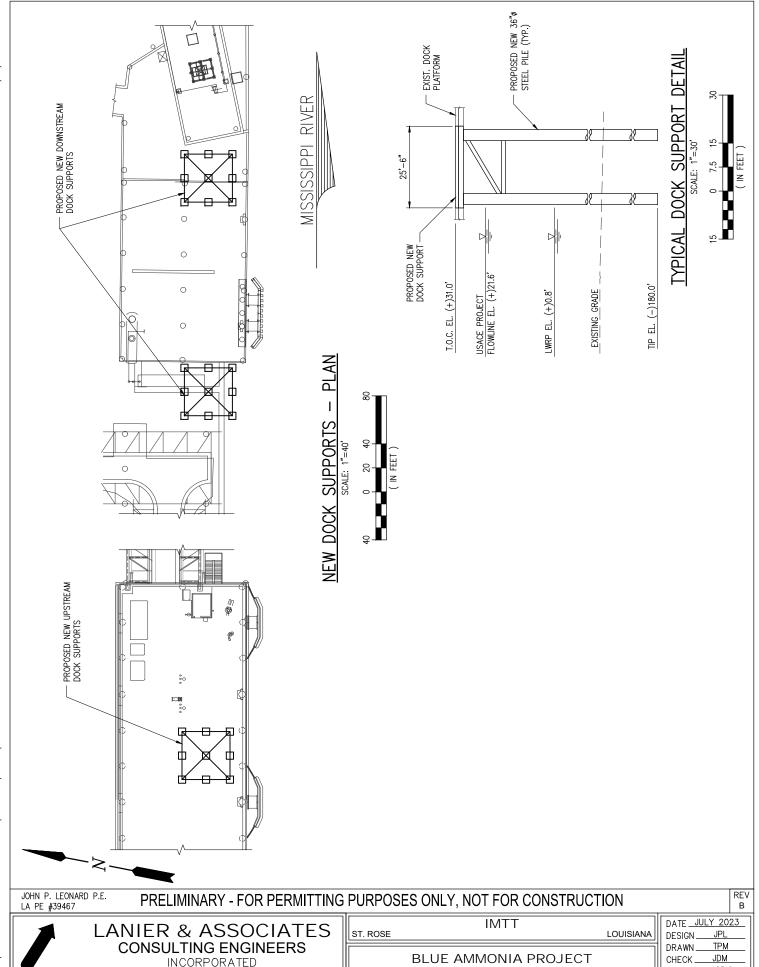

JOB NO.


NEW DOCK SUPPORTS

PLAN & DETAIL

12512

SHEET No. A-33 OF A-42



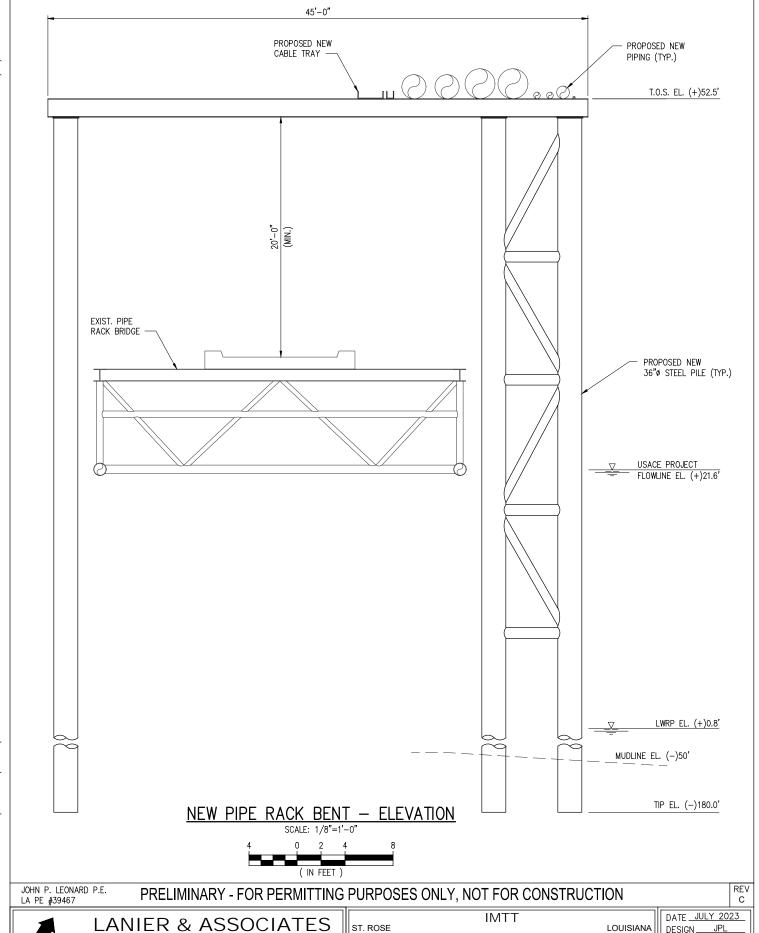

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INCORPORATED LA: EF-1120 TX: F-2981


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BLUE AMMONIA PROJECT TYPICAL PIPE RACK @ EXIST BRIDGES

ELEVATION

DESIGN. ТРМ DRAWN CHECK. JDM 12512

JOB NO_ SHEET No. A-34 of A-42

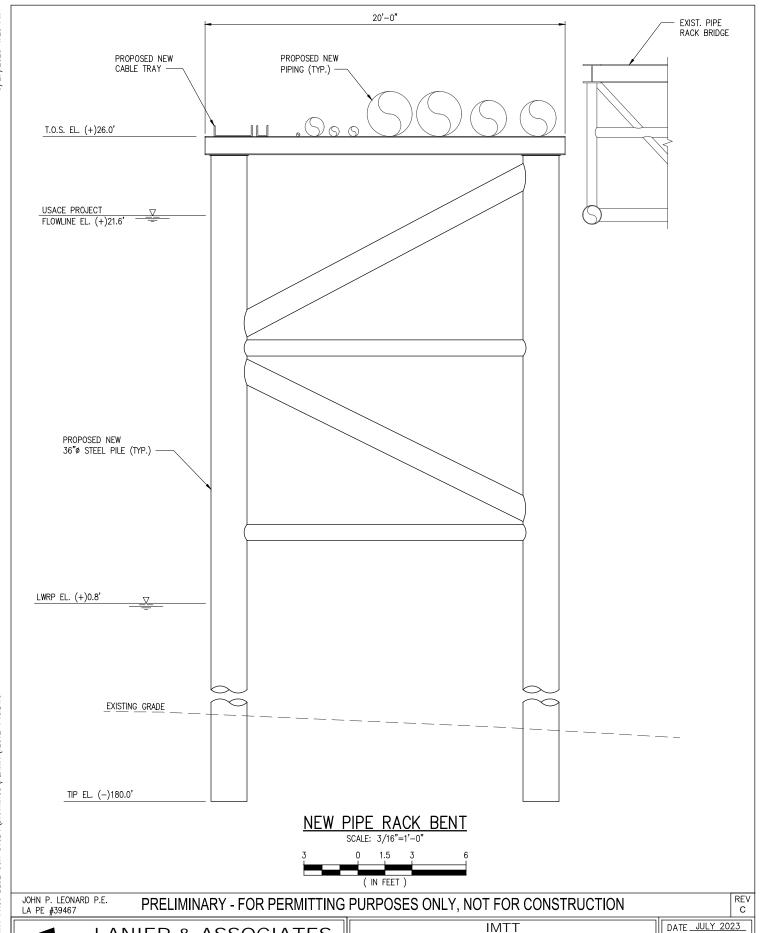

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INCORPORATED

LA: EF-1120


TX: F-2981 NEW ORLEANS • BEAUMONT • CORPUS CHRISTI • HOUSTON ST. ROSE

BLUE AMMONIA PROJECT TYPICAL PIPE RACK BENT **ELEVATION**

DATE JULY 2023 DESIGN ТРМ DRAWN CHECK. JDM

12512 JOB NO_ SHEET No. A-35 of A-42

LOUISIANA

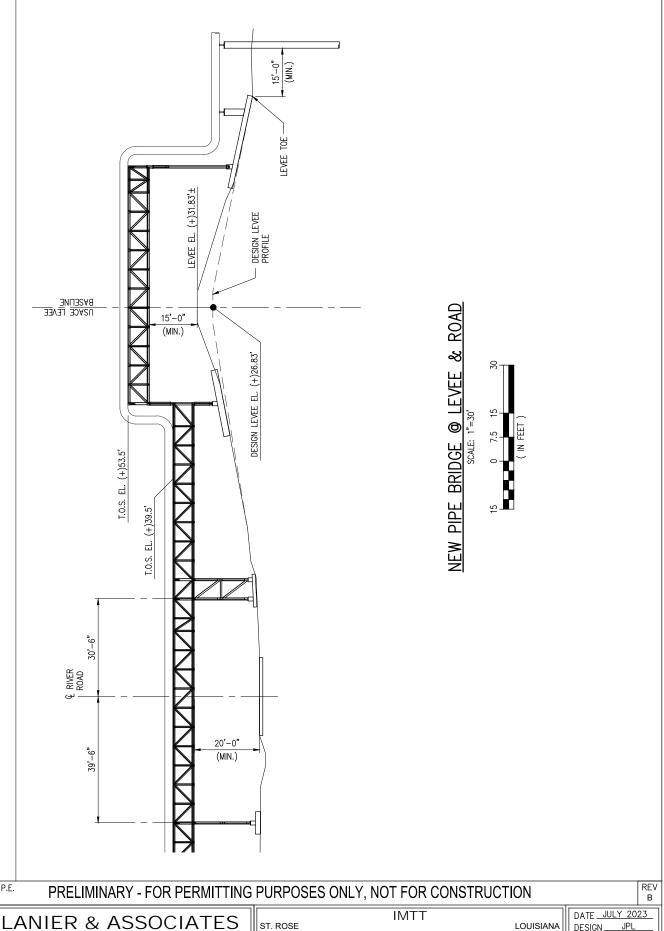

JOHN P. LEONARD P.E. LA PE #39467

LOUISIANA

DESIGN TPM DRAWN CHECK. JDM JOB NO_ 12512


LA: EF-1120 TX: F-2981 NEW ORLEANS • BEAUMONT • CORPUS CHRISTI • HOUSTON

BLUE AMMONIA PROJECT NEW PIPE BRIDGE @ LEVEE & ROAD

SHEET No. A-36 OF A-42

CONSULTING ENGINEERS INCORPORATED



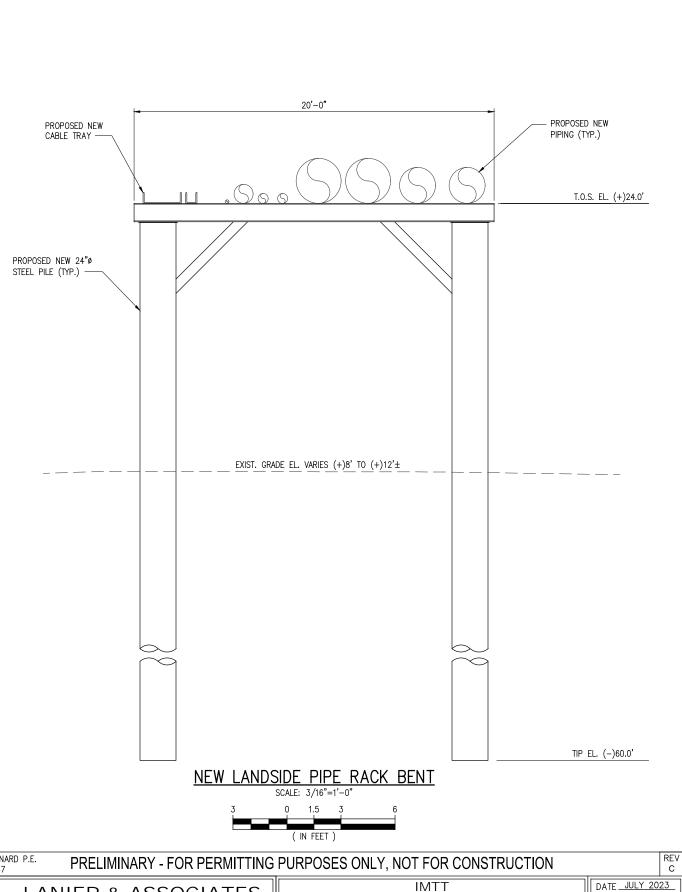

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BLUE AMMONIA PROJECT TYPICAL LANDSIDE PIPE RACK BENT DESIGN. ТРМ DRAWN CHECK _ JDM 12512 JOB NO_ SHEET No. A-37 of A-42


LOUISIANA

DATE JULY 2023

ST. ROSE

ELEVATION



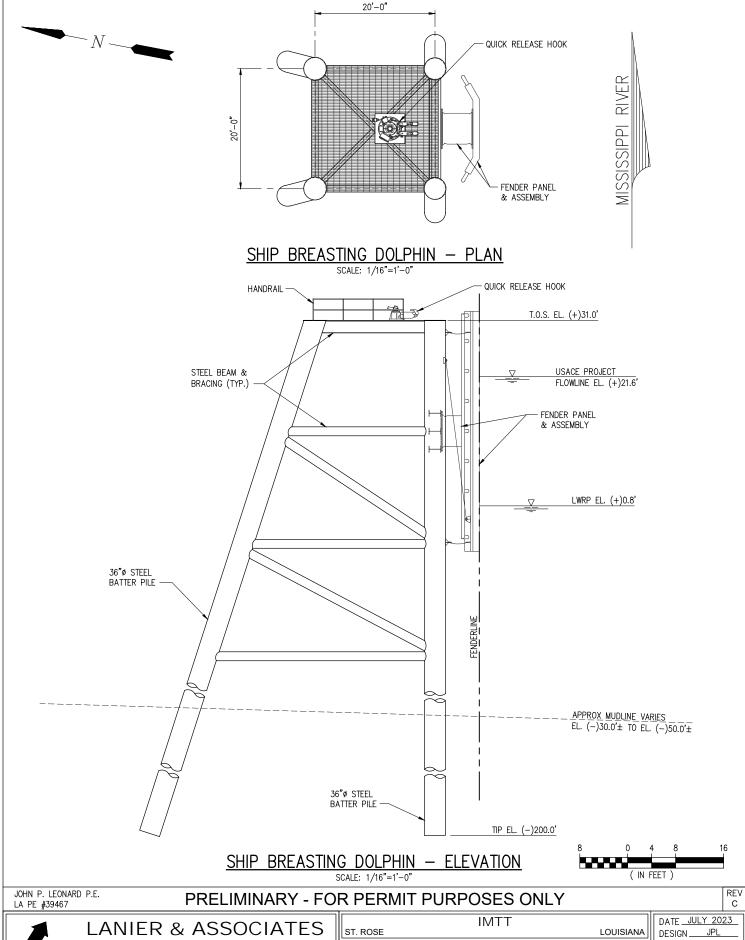

CONSULTING ENGINEERS

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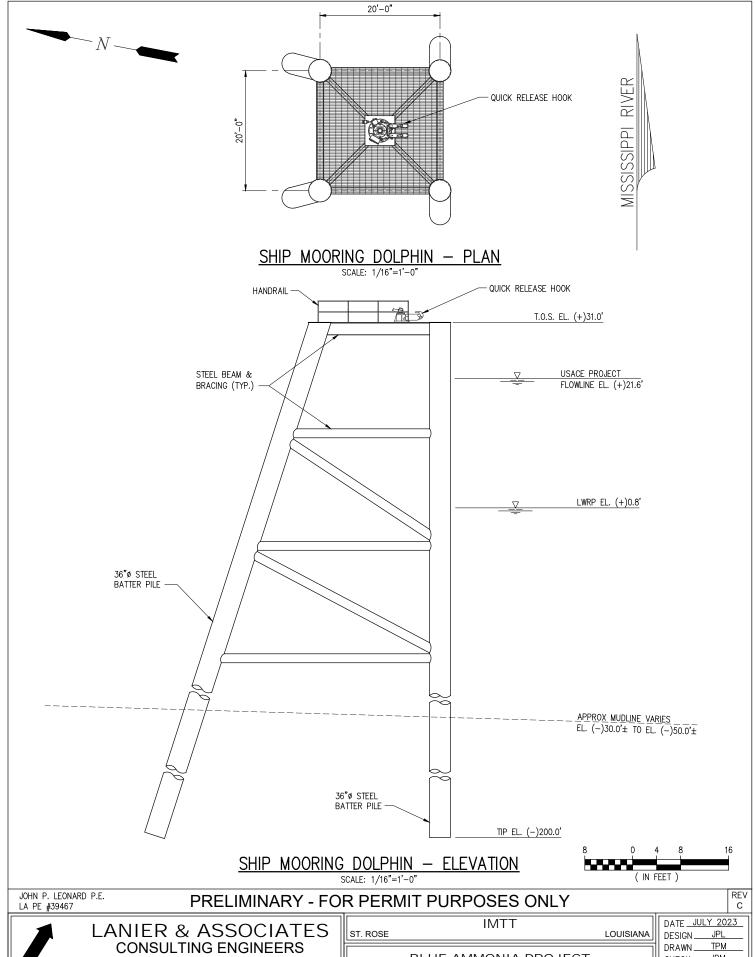
TX: F-2981 LA: EF-1120 NEW ORLEANS • BEAUMONT • CORPUS CHRISTI • HOUSTON

BLUE AMMONIA PROJECT SHIP BREASTING DOLPHIN

PLAN & ELEVATION

ТРМ DRAWN CHECK. JDM 12512 JOB NO_ SHEET No. A-38 of A-42






INCORPORATED

NEW ORLEANS • BEAUMONT • CORPUS CHRISTI • HOUSTON

LA: EF-1120 TX: F-2981 **BLUE AMMONIA PROJECT** SHIP MOORING DOLPHIN PLAN & ELEVATION

CHECK. JDM 12512 JOB NO_ SHEET No. A-39 of A-42

JOHN P. LEONARD P.E.

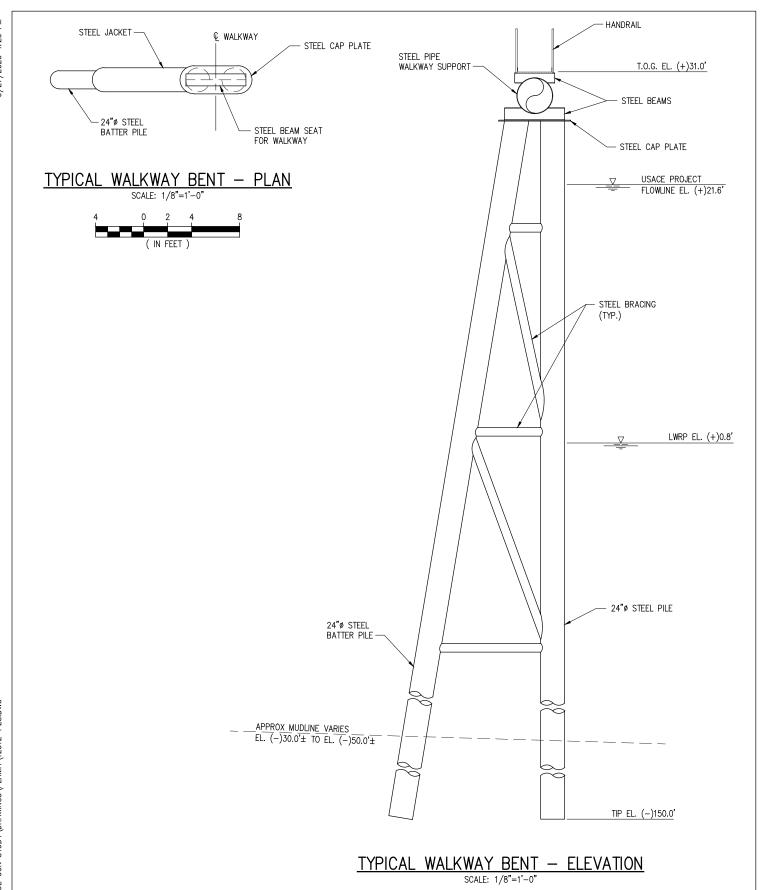

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TX: F-2981


LA: EF-1120 NEW ORLEANS • BEAUMONT • CORPUS CHRISTI • HOUSTON **BLUE AMMONIA PROJECT** TYPICAL WALKWAY BENT

PLAN & ELEVATION

DATE JULY 2023 TPM JDM 12512 SHEET No. A-40 of A-42

IMTT LOUISIANA

DESIGN. DRAWN. CHECK _ JOB NO_

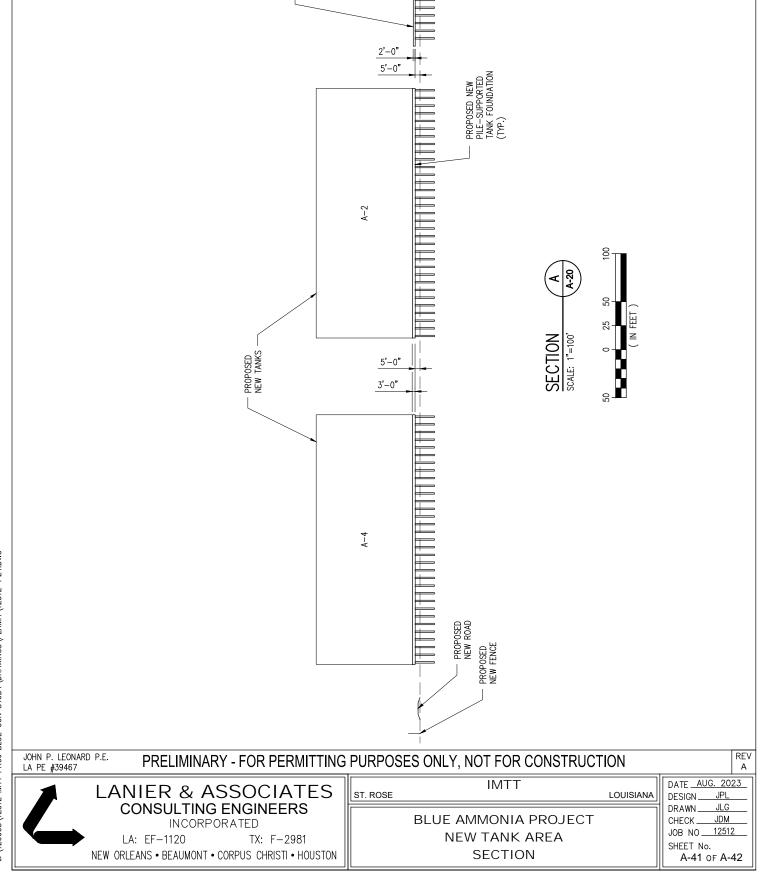


PROPOSED NEW PIPE RACK

PROPOSED NEW BOG, PUMPS & SUBSTATION FOUNDATION

T.O.S. EL. (+)24.0' GRADE EL. (+)10.0'



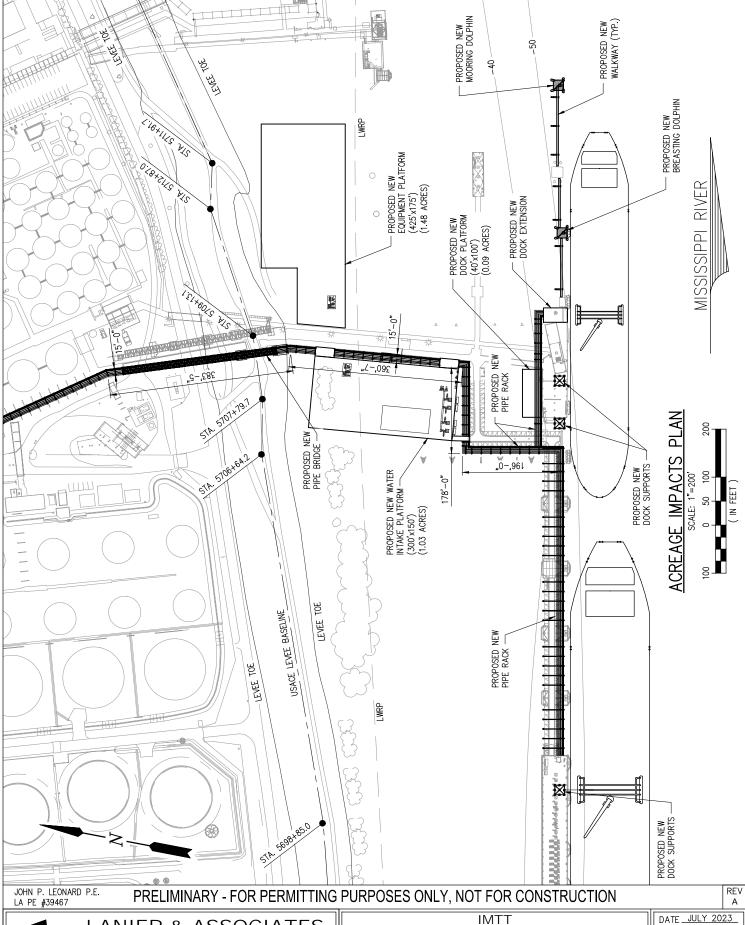

J:\12000S\12512 IMTT PROJ BLUE CON STUDY\DRAWINGS\PERMIT\12512-P25.DWG

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BLUE AMMONIA PROJECT ACREAGE IMPACTS PLAN

DATE JULY 2023
DESIGN JPL
DRAWN TPM
CHECK JDM
JOB NO 12512

LOUISIANA

SHEET No. A-42 OF A-42