

DEPARTMENT OF THE ARMY U.S. ARMY CORPS OF ENGINEERS, NEW ORLEANS DISTRICT 7400 LEAKE AVENUE NEW ORLEANS, LOUISIANA 70118-3651

September 12, 2022

Project Manager:
Stephanie Castaing
(504) 862-1564
Stephanie.L.Castaing@usace.army.mil

Permit Application Number: MVN-2022-00523-EPP

PUBLIC NOTICE

Interested parties are hereby notified that a permit application has been received by the New Orleans District of the U.S. Army Corps of Engineers pursuant to: [X] Section 10 of the Rivers and Harbors Act of March 3, 1899 (30 Stat. 1151; 33 USC 403); and/or [X] Section 404 of the Clean Water Act (86 Stat. 816; 33 USC 1344).

CONTAINER EXPORT TERMINAL WITHIN AND ALONG THE MISSISSIPPI RIVER IN PLAQUEMINES PARISH

NAME OF APPLICANT: Louisiana 23 Asset Management Group, LLC, c/o Cardno, Inc., Attn: Brenton Jenkins, 251 Florida Street, Suite 407, Baton Rouge, Louisiana 70816 or brenton.jenkins@cardno.com

LOCATION OF WORK: At approximately Latitude: 29.5771, Longitude: -89.8139, on the right descending bank of the Mississippi River, at about 50 miles above Head of Passes, off Louisiana Highway 23, in Port Sulphur, Louisiana, in Plaquemines Parish, as shown on the enclosed drawings.

Hydrologic Unit Code: 08090301 (East Central Louisiana Coastal)

CHARACTER OF WORK: Construct a container export terminal (The Louisiana's Gateway Terminal -LGT project), to include a Terminal and Wharf Facility. The basic layout of the Terminal facility shall include a container storage, maintenance and gate building, and industrial facility area. The basic layout of the Wharf facility shall include an approximately 2,750' x 200' wharf, four (4) approachways, dock house, and fire intake system. The project as proposed would directly impact approximately 29.67 acres of wetlands and/or waterbottoms. The applicant proposed to contract with an approved mitigation bank to offset the adverse impact to jurisdictional wetlands.

The comment period for the Department of the Army Permit will close **30 days** from the date of this public notice. Written comments, including suggestions for modifications or objections to the proposed work, stating reasons thereof, are being solicited from anyone having interest in this permit and must be mailed so as to be received before or by the last day of the comment period. Letters and/or comments concerning the subject permit application must reference the Applicant's Name and the Permit Application Number and can be preferably emailed to the Corps of Engineers project manager listed above or forwarded to the Corps of Engineers at the address above, <u>ATTENTION:</u> <u>REGULATORY DIVISION, RGE, Stephanie Castaing.</u> This public notice is also available for review online at https://go.usa.gov/xennJ.

Corps of Engineers Permit Criteria

The decision whether to issue a permit will be based on an evaluation of the probable impacts, including cumulative impacts of the proposed activity on the public interest. That decision will reflect the national concern for both protection and utilization of important resources. The benefit which reasonably may be expected to accrue from the proposal must be balanced against its reasonably foreseeable detriments. All factors which may be relevant to the proposal will be considered including the cumulative effects thereof; among those are conservation, economics, aesthetics, general environmental concerns, wetlands, historic properties, fish and wildlife values, flood hazards, floodplain values, land use, navigation, shoreline erosion and accretion, recreation, water supply and conservation, water quality, energy needs, safety, food and fiber production, mineral needs, considerations of property ownership and, in general, the needs and welfare of the people.

The U.S. Army Corps of Engineers is soliciting comments from the public, federal, state, and local agencies and officials, Indian Tribes, and other interested parties to consider and evaluate the impacts of this proposed activity. Any comments received will be considered by the U.S. Army Corps of Engineers to determine whether to make, modify, condition, or deny a permit for this proposal. To make this decision, comments are used to assess impacts on endangered species, historic properties, water quality, general environmental effects, and other public interest factors listed above. Comments are used in the preparation of an Environmental Assessment and/or an Environmental Impact Statement pursuant to the National Environmental Policy Act. Comments are also used to determine the need for a public hearing and to determine the overall public interest of the proposed activity.

By letter dated April 26, 2022, the State Historic Preservation Office (SHPO) stated, based on the description of the Area of Potential Effect (APE), the proposed ground-disturbing activities, and the identification of historic properties within the APE, our office concurs with the assessment that no historic properties listed in or eligible for listing in the National Register of Historic Places will be affected by this project. We concur that the portions of sites 16PL125, 16PL157, and 16PL266, along with LHRI no. 38-00177 within the APE are not eligible for listing in the National Register. Our office has no further concerns for this project.

The New Orleans District has determined that the activity is not likely to adversely affect the endangered Pallid Sturgeon or the threatened West Indian Manatee with the inclusion of Intake Conditions and the Standard Manatee Conditions, based on the Information & Planning Consultation for Endangered Species in Louisiana (IPaC), dated January 27, 2020, between the U.S. Army Corps of Engineers, New Orleans and U.S. Fish and Wildlife Service, Ecological Services Office.

Our initial finding is that the proposed work is Not Likely to Adversely Affect any species listed as endangered by the U.S. Departments of Commerce, nor affect any habitat designated as critical to the survival and recovery of such species.

This notice initiates the Essential Fish Habitat (EFH) consultation requirements of the Magnuson-Stevens Fishery Conservation and Management Act. The applicant's proposal would result in the destruction or alteration of 29.67 acres of EFH utilized by various life stages of red drum and penaeid shrimp. Our initial determination is that the proposed action would have no adverse impact on EFH or federally managed fisheries in the Gulf of Mexico. Our final determination relative to project impacts and the need for mitigation measures is subject to review by and coordination with the National Marine Fisheries Service.


If the proposed work involves deposits of dredged or fill material into navigable waters, the evaluation of the probable impacts will include the application of guidelines established by the Administrator of the Environmental Protection Agency. Also, a certification that the proposed activity will not violate applicable water quality standards will be required from the Department of Environmental Quality, Water Quality Certifications, before a permit is issued.


Any person may request, in writing, within the comment period specified in this notice, that a public hearing be held to consider this application. Requests for public hearings shall state, with particularity, the reasons for holding a public hearing.

The applicant has certified that the proposed activity described in the application complies with and will be conducted in a manner that is consistent with the Louisiana Coastal Resources Program. The Department of the Army permit will not be issued unless the applicant received approval or a waiver of the Coastal Use Permit by the Department of Natural Resources.

You are requested to communicate the information contained in this notice to any other parties whom you deem likely to have interest in the matter.

Brad P. LaBorde Chief, Eastern Evaluation Branch

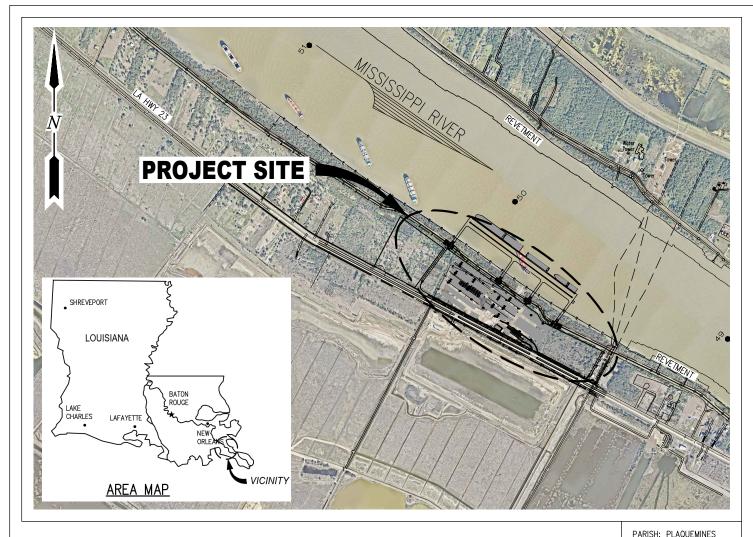

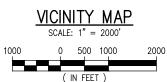

LATITUDE: 29° 34′ 43″ N LONGITUDE: 89° 48' 42" W

- AS-BUILT DRAWINGS WILL BE SUBMITTED WITHIN 30 DAYS OF COMPLETION OF THIS PROJECT TO THE LOUISIANA DEPARTMENT OF NATURAL RESOURCES, OFFICE OF CONSERVATION, PIPELINE DIVISION, P. O. BOX 94275 BATON ROUGE, LA 70804, AND TO THE LOUISIANA DEPARTMENT OF NATURAL RESOURCES, COASTAL MANAGEMENT DIVISION, P. O. BOX 44487, BATON ROUGE, LA 70804-4487.
- ALL STRUCTURES, FACILITIES, WELL AND PIPELINES/FLOWLINES OCCURRING IN OPEN WATER AREAS OR IN OILFIELD CANALS OR SLIPS SHALL BE REMOVED WITHIN 120 DAYS OF ABANDONMENT OF THE FACILITIES FOR THE HEREIN PERMITTED USE UNLESS PRIOR WRITTEN APPROVAL TO LEAVE SUCH STRUCTURES IN PLACE IS RECEIVED FROM THE COASTAL MANAGEMENT DIVISION. THIS CONDITION DOES NOT PRECLUDE THE NECESSITY FOR REVISING THE CURRENT PERMIT OR OBTAINING A SEPARATE COASTAL USE PERMIT, SHOULD ONE BE REQUIRED.
- 3. STRUCTURES MUST BE MARKED / LIGHTED IN ACCORDANCE WITH U.S. COAST GUARD REGULATIONS.
- IN ORDER TO ENSURE THE SAFETY OF ALL PARTIES, THE PERMITTEE SHALL CONTACT THE LOUISIANA ONE CALL SYSTEM (1-800-272-3020) A MINIMUM OF 48 HOURS PRIOR TO THE COMMENCEMENT OF ANY EXCAVATION (DIGGING, DREDGING, JETTING, ETC.) OR DEMOLITION ACTIVITY.
- 5. APPLICANT SHALL COORDINATE WITH CPRA TO ENSURE THAT THIS PROJECT DOES NOT IMPEDE CONSTRUCTION OF THE BA-0240 PROJECT, ALSO, CPRA HAS \$100s OF MILLIONS IN OTHER PROJECTS PLANNED UTILIZING THIS BORROW AREA. APPLICANT SHALL COORDINATE WITH CPRA DURING DESIGN AND CONSTRUCTION TO ENSURE CPRA WILL BE ABLE TO CONSTRUCT THOSE PROJECTS AND UTILIZE AS MUCH OF THIS BORROW AREA AS POSSIBLE.
- THE APPLICANT MUST SUBMIT FOR AND RECEIVE A LEVEE PERMIT/LETTER OF NO OBJECTION FROM THE CPRA, THE UNITED STATES ARMY CORPS OF ENGINEERS AND THE PLAQUEMINES PARISH GOVERNMENT PRIOR TO
- THE APPLICANT SHALL ADHERE TO ALL STATE STATUTES (R.S. 56:2011 ET SEQ.) AND DEPARTMENT REGULATIONS (LAC 76:XIII.101 et seq.) concerning dredging of FILL SAND AND FILL MATERIAL FROM WATER BOTTOMS OF THE STATE OF LOUISIANA AND SEVERANCE ROYALTIES.

BRAD FRISCHHERTZ LA PE #32628

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LANIER & ASSOCIATES CONSULTING ENGINEERS

INCORPORATED

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LA 23 DEVELOPMENT COMPANY MINES PARISH

LOUISIANA'S GATEWAY TERMINAL VICINITY MAP, **AREA MAP, AND NOTES**

DATE MAR. 2022 DESIGN DRAWN SJA CHECK 11641 JOB NO. SHEET No.

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DRAWING INDEX

VICINITY MAP, AREA MAP, AND NOTES

TITLE

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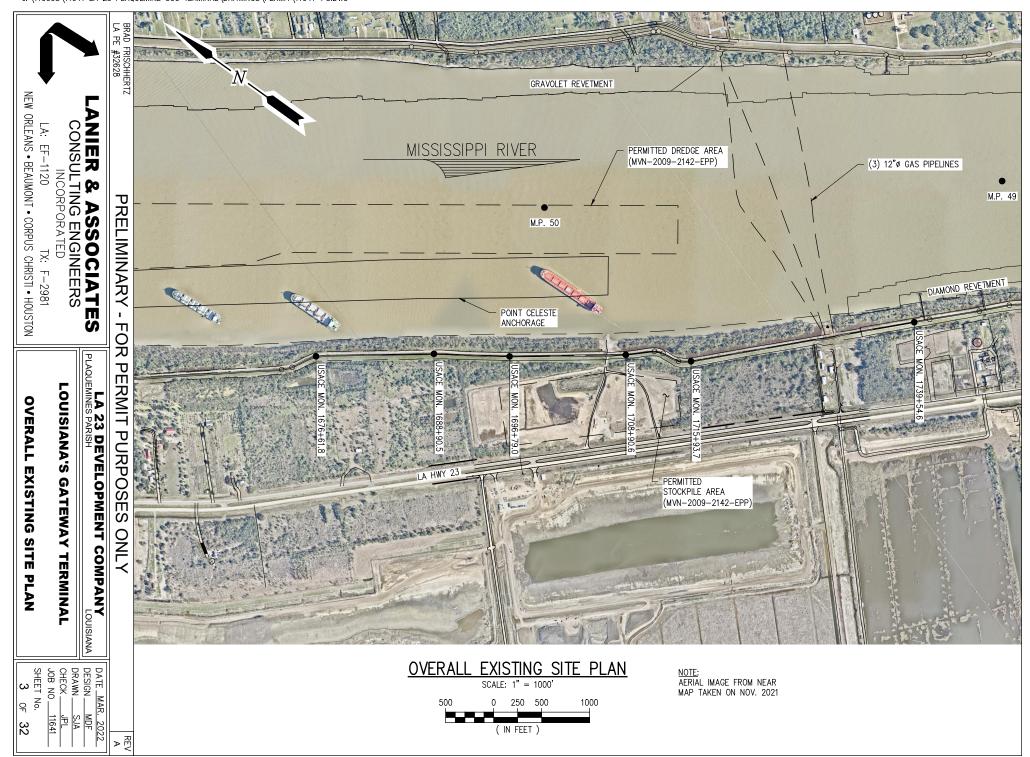
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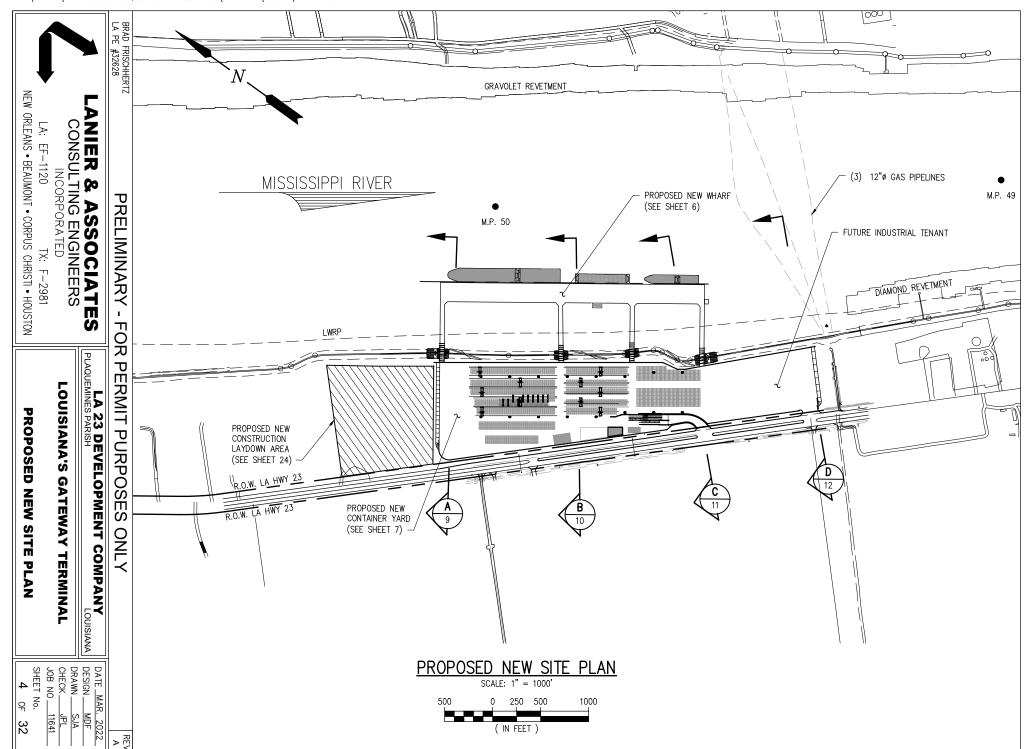
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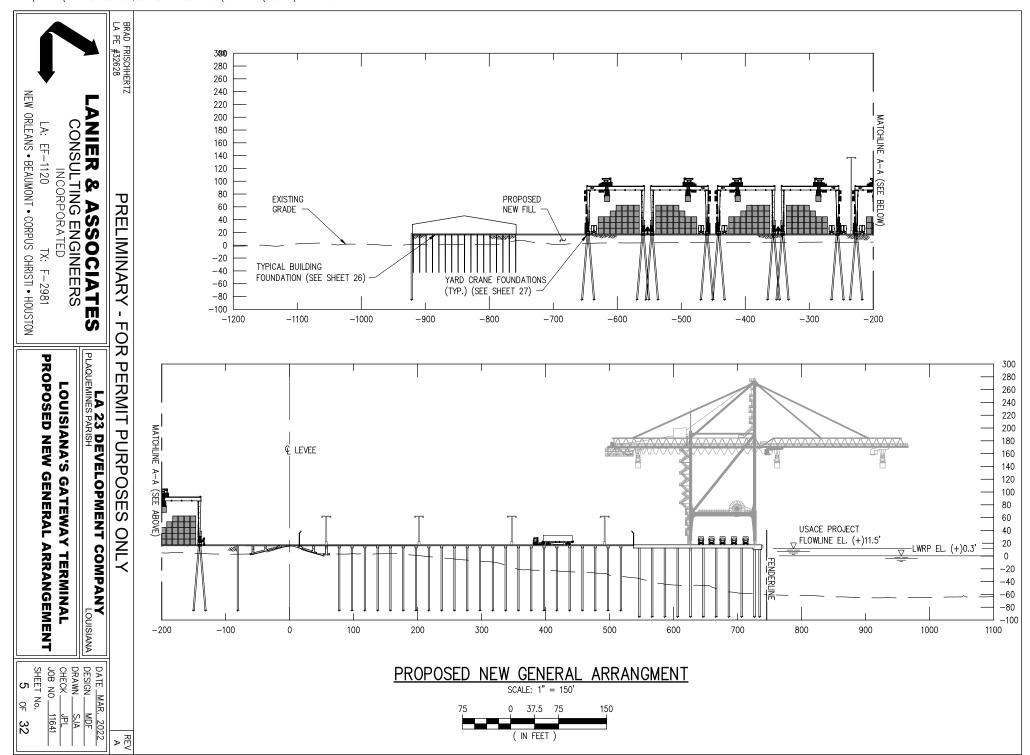
LOUISIANA'S GATEWAY TERMINAL DRAWING INDEX


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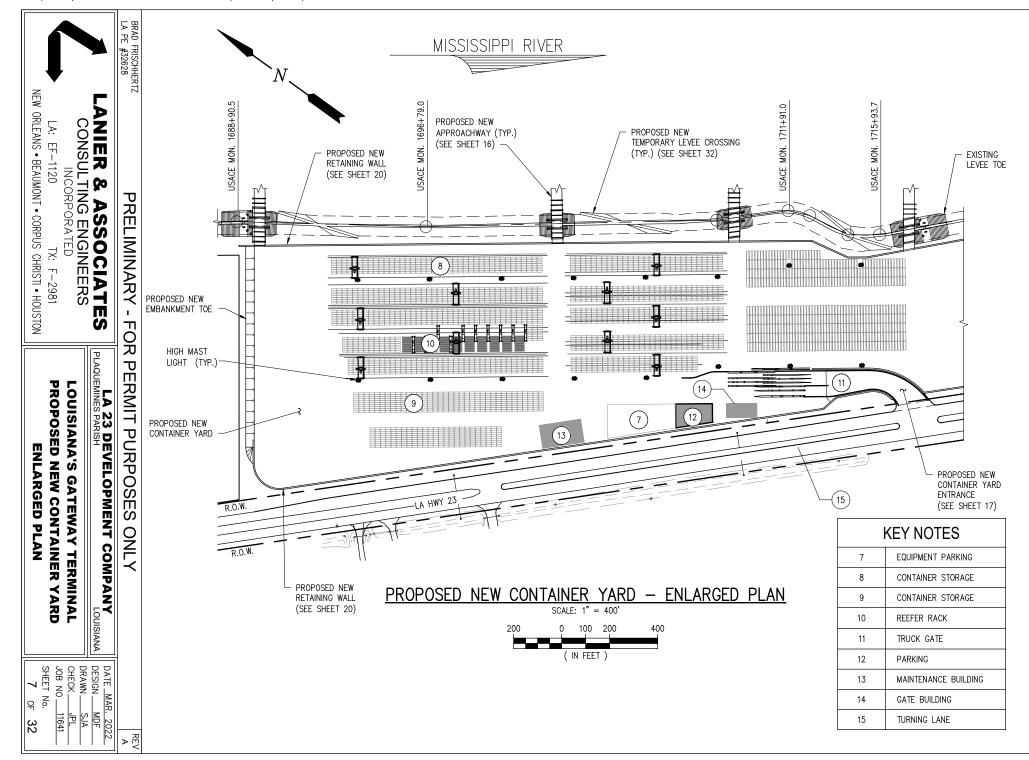
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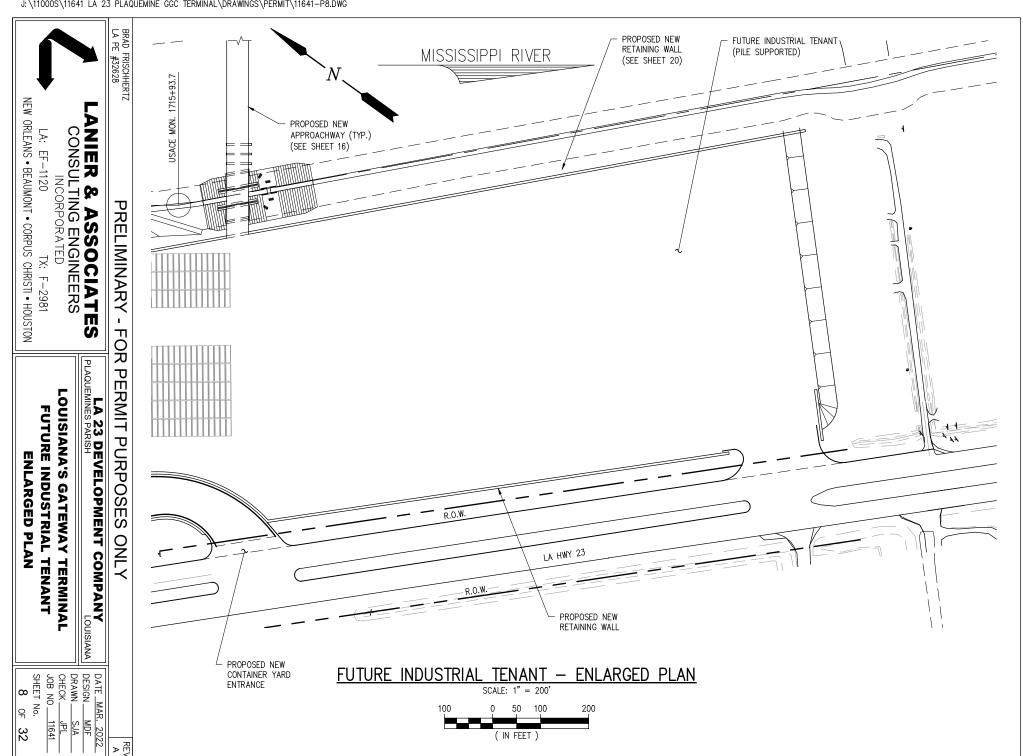










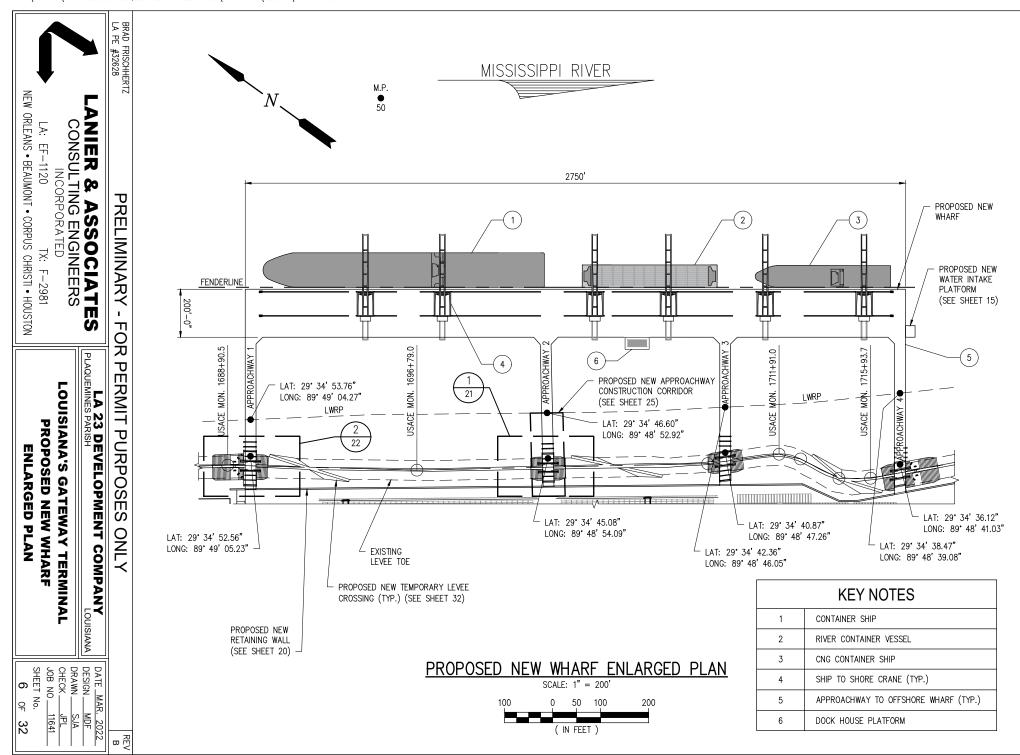

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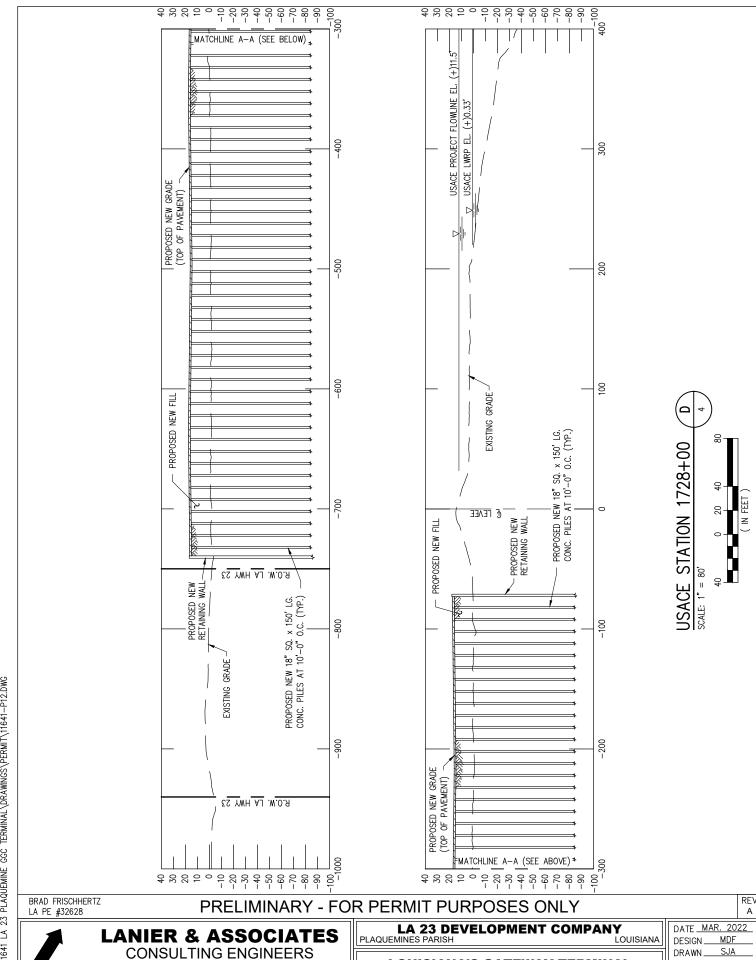
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LOUISIANA'S GATEWAY TERMINAL

SECTION AT USACE STA. 1728+00

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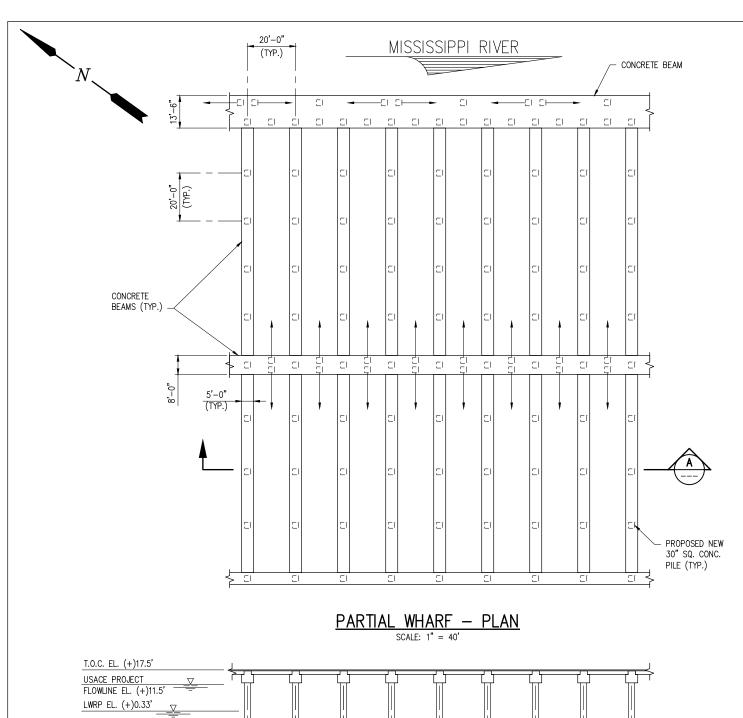
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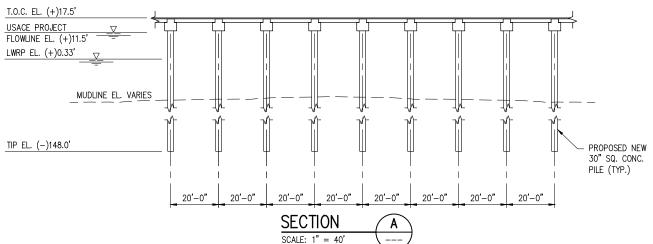
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LA 23 DEVELOPMENT COMPANY PLAQUEMINES PARISH DESIGN_

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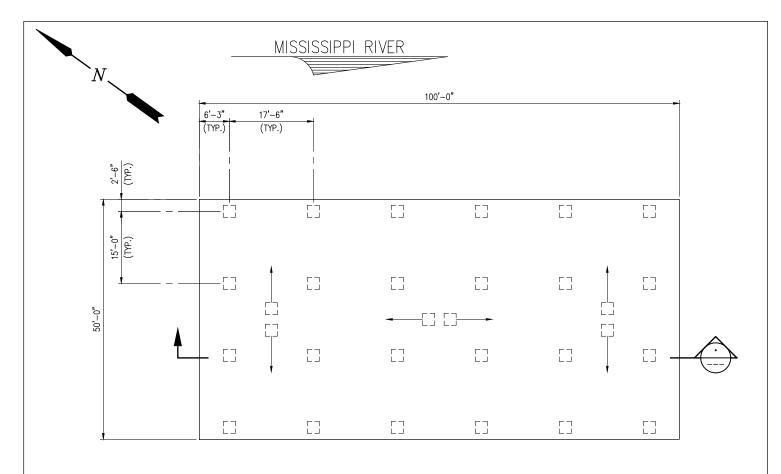
LOUISIANA'S GATEWAY TERMINAL PARTIAL PLAN AND SECTION

LANIER & ASSOCIATES CONSULTING ENGINEERS


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DOCK HOUSE PLATFORM - PLAN



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LA 23 DEVELOPMENT COMPANY PLAQUEMINES PARISH DATE MAR. 2022

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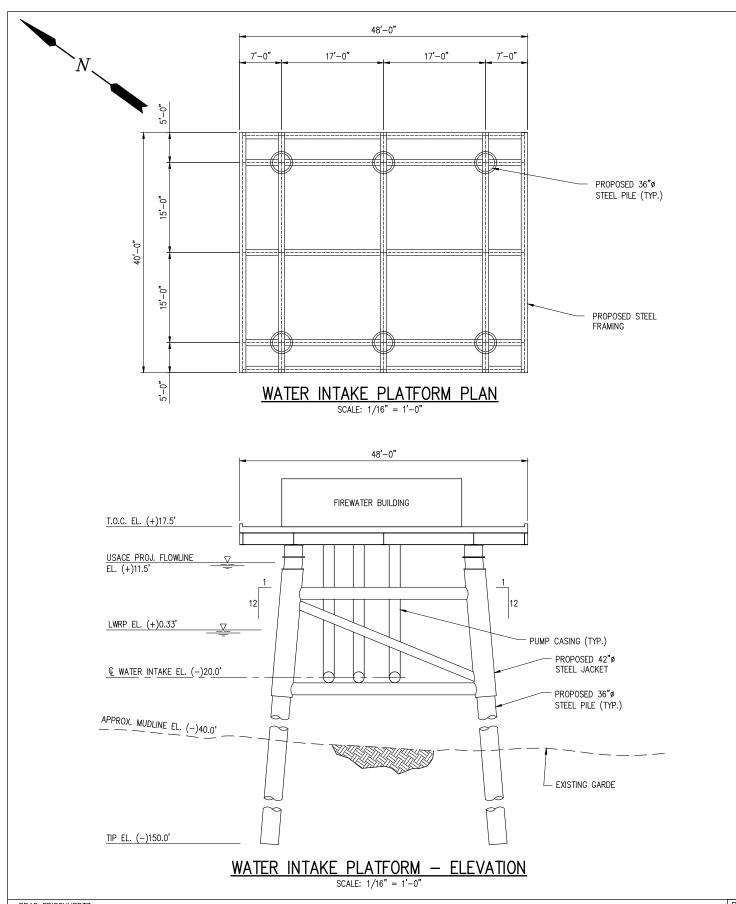
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LOUISIANA'S GATEWAY TERMINAL PROPOSED NEW DOCK HOUSE PLATFORM **PLAN AND SECTION**

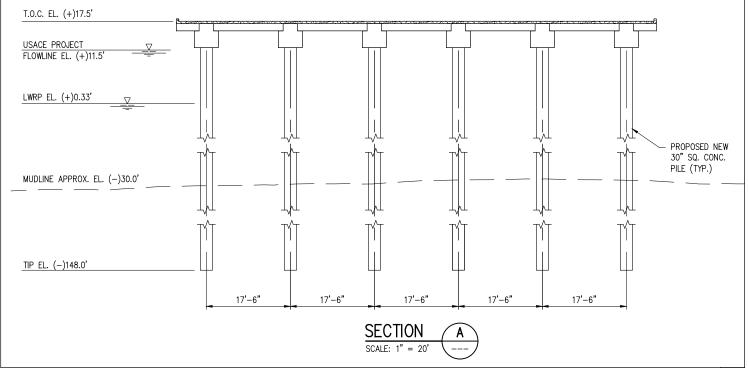

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PLAQUEMINES PARISH
LOUISIANA

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DATE <u>MAR. 2022</u>

PROPOSED NEW WATER INTAKE PLATFORM
PLAN & ELEVATION


LOUISIANA'S GATEWAY TERMINAL

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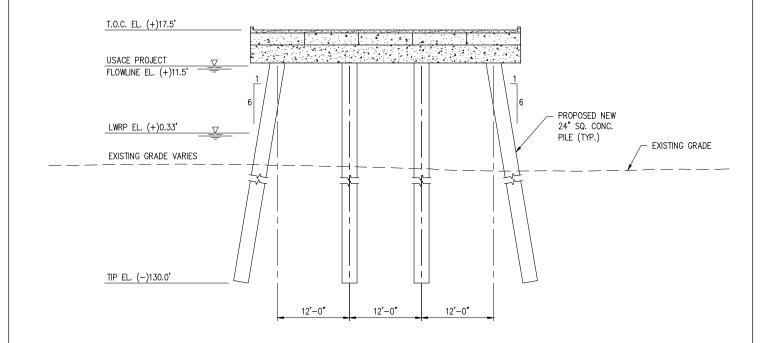
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<u>PARTIAL APPROACHWAY - PLAN</u> SCALE: 1/16" = 1'-0"



TYPICAL APPROACHWAY SECTION

SCALE: 1/16" = 1'-0'
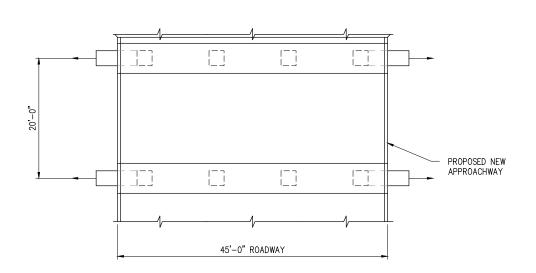
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LA 23 DEVELOPMENT COMPANY
PLAQUEMINES PARISH
LOUISIANA DESIGN.

Α DATE <u>MAR. 2022</u> MDF

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LA: EF-1120 TX: F-2981 NEW ORLEANS • BEAUMONT • CORPUS CHRISTI • HOUSTON **LOUISIANA'S GATEWAY TERMINAL**

PROPOSED NEW PARTIAL APPROACHWAY **PLAN AND SECTION**

ENTRANCE PLAN

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LOUISIANA'S GATEWAY TERMINAL

FUTURE INDUSTRIAL TENANT

ENTRANCE PLAN

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JPL

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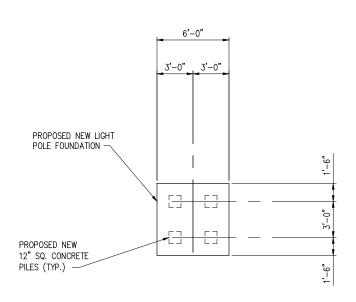
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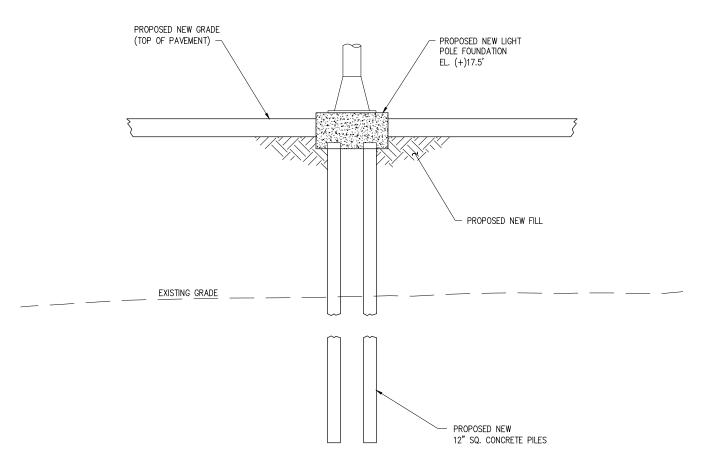
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TX: F-2981

LA: EF-1120



LIGHT POLE FOUNDATION PLAN SCALE: 1/8" = 1'-0"



LIGHT POLE FOUNDATION ELEVATION SCALE: 1/8" = 1'-0"

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PLAQUEMINES PARISH
LOUISIANA


PLAN AND ELEVATION

LOUISIANA'S GATEWAY TERMINAL PROPOSED NEW LIGHT POLE FOUNDATION DATE <u>MAR. 2022</u> DESIGN MDF DRAWN_ SJA CHECK JPL 11641 JOB NO_


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RETAINING WALL PARTIAL PLAN



SECTION AT RETAINING WALL

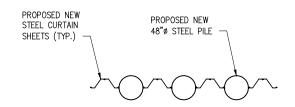SCALE: 1/16" = 1'-0"

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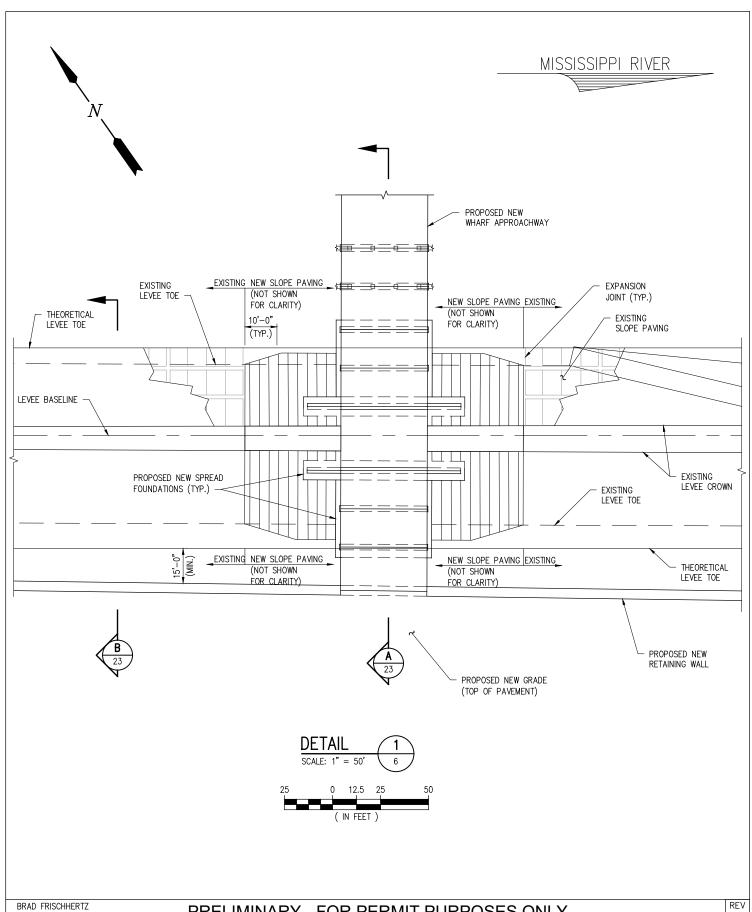
LA 23 DEVELOPMENT COMPANY
PLAQUEMINES PARISH

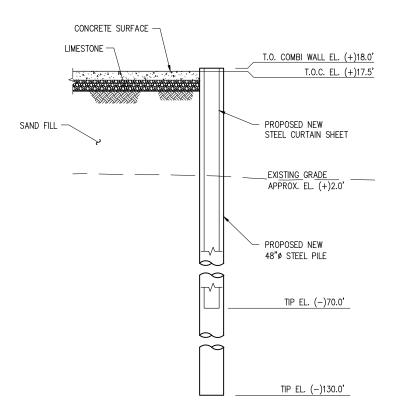DATE MAR. 2022
LOUISIANA DESIGN MDF

DESIGN MDF
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LOUISIANA'S GATEWAY TERMINAL PROPOSED NEW RETAINING WALL PLAN AND SECTION





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PLAQUEMINES PARISH
LOUISIANA

DATE <u>MAR. 2022</u> MDF DESIGN. DRAWN. SJA CHECK. JPL 11641 JOB NO_


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LA: EF-1120 TX: F-2981 **LOUISIANA'S GATEWAY TERMINAL** PROPOSED NEW ACCESS RAMP **PLAN (1 OF 2)**

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SHEET No. 21 of 32



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SHEET No. **22** OF **32**

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LA 23 DEVELOPMENT COMPANY PLAQUEMINES PARISH

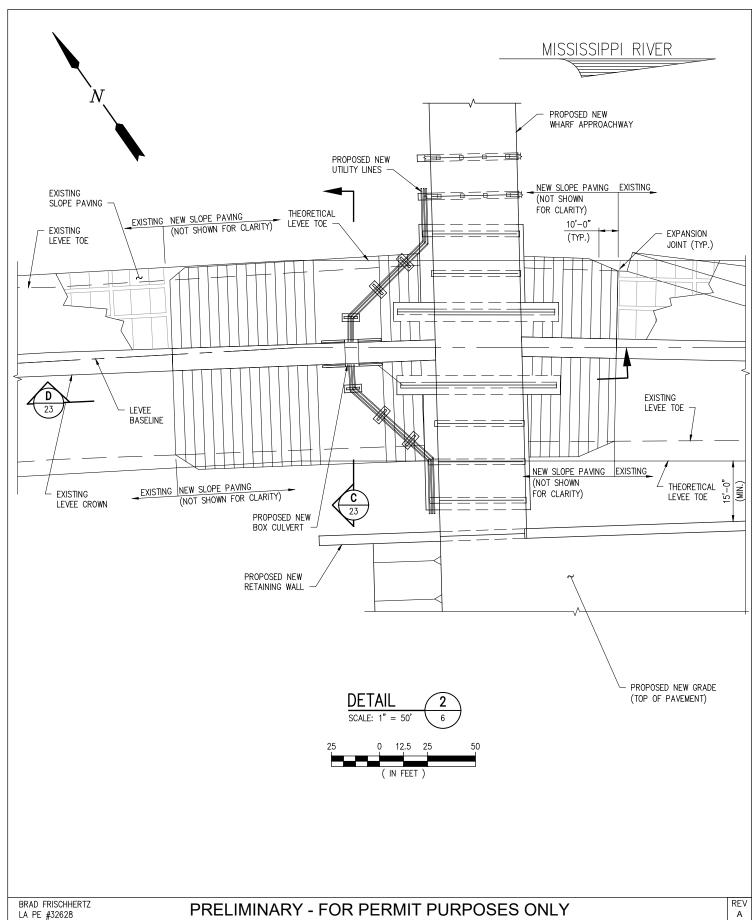
LOUISIANA'S GATEWAY TERMINAL PROPOSED NEW ACCESS RAMP PLAN (2 OF 2)

PROPOSED NEW WHARF APPROACHWAY

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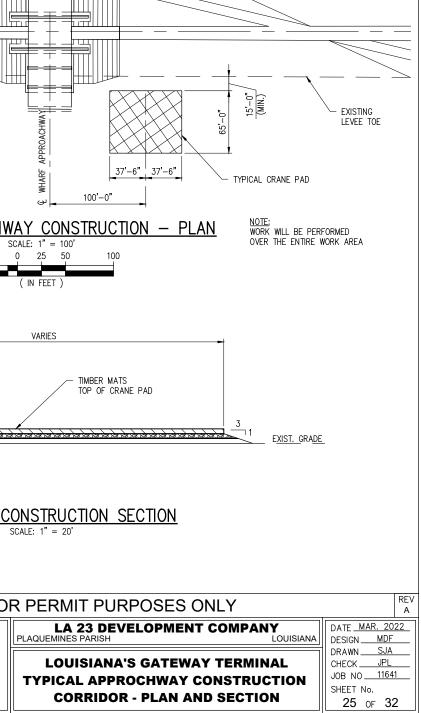
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LOUISIANA'S GATEWAY TERMINAL PROPOSED CONSTRUCTION LAYDOWN AREA **PLAN AND DETAIL**

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MISSISSIPPI RIVER

EXISTING LEVEE TOE

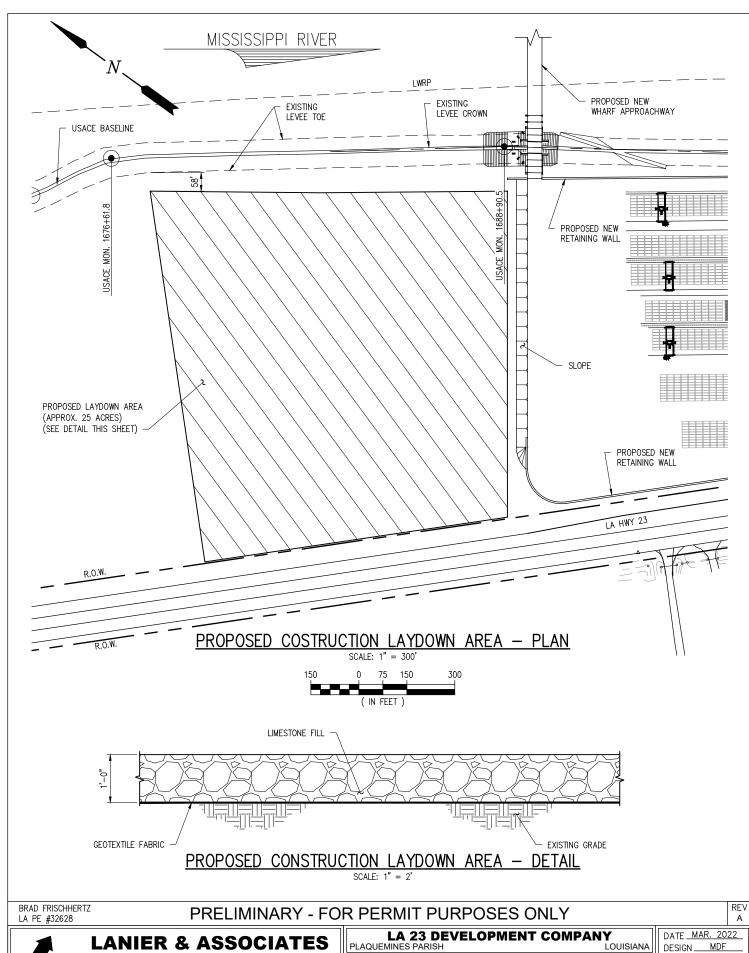
PROPOSED NEW WHARF APPROACHWAY

LWRP

TEMPORARY


CONSTRUCTION CORRIDOR

LEVEE BASELINE

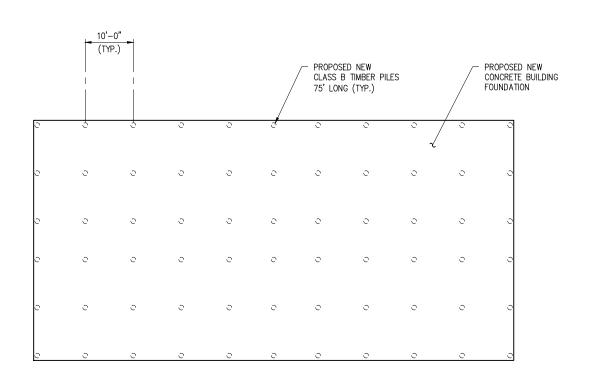

TYPICAL BUILDING FOUNDATION - PLAN

SCALE: 1" = 20'

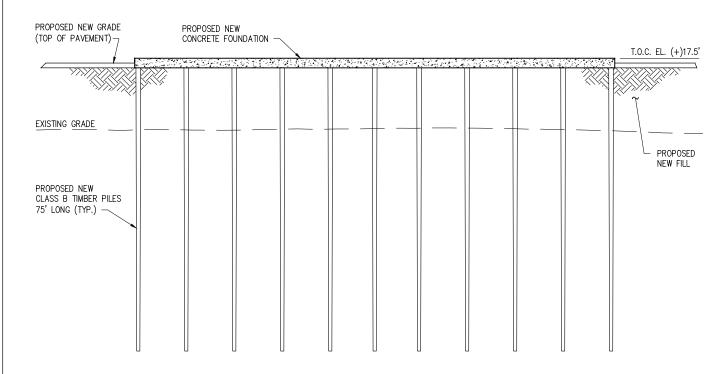

BUILDING FOUNDATION — ELEVATION SCALE: 1" = 20'

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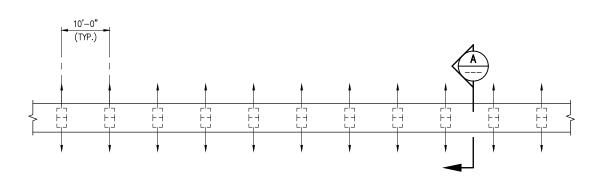
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LA 23 DEVELOPMENT COMPANY PLAQUEMINES PARISH

LOUISIANA'S GATEWAY TERMINAL TYPICAL BUILDING FOUNDATION PLAN AND ELEVATION


DATE <u>MAR. 2022</u> MDF DESIGN. DRAWN. SJA JPL CHECK 11641 JOB NO.


SHEET No. **26** OF 32



TYPICAL YARD CRANE FOUNDATION - PLAN

SCALE: 1" = 20'

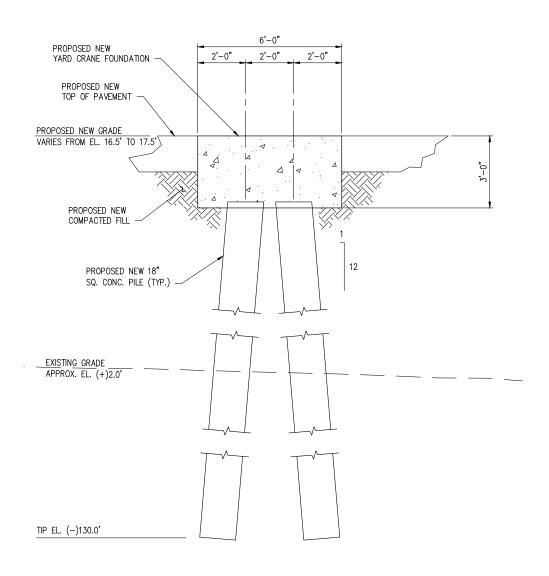

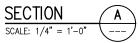

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LA 23 DEVELOPMENT COMPANY PLAQUEMINES PARISH DATE <u>MAR. 2022</u>

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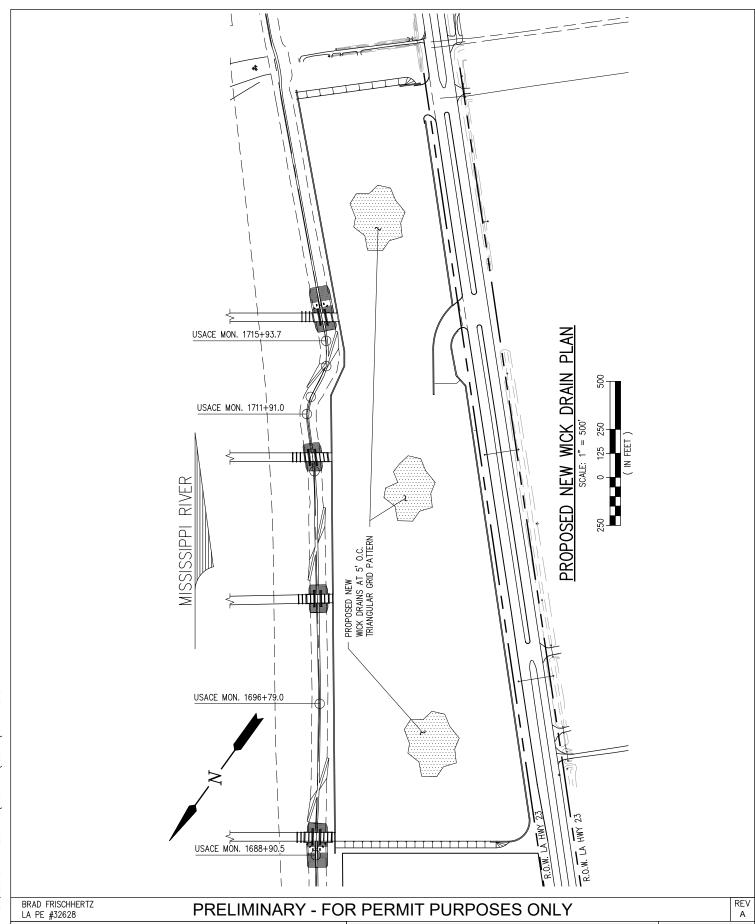
SHEET No. 27 OF 32

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LOUISIANA'S GATEWAY TERMINAL TYPICAL YARD CRANE FOUNDATION **PLAN AND SECTION**



LA 23 DEVELOPMENT COMPANY
PLAQUEMINES PARISH
LOUISIANA

DATE MAR. 2022
LOUISIANA DESIGN MDF

DESIGN MDF
DRAWN SJA
CHECK JPL
JOB NO 11641

LOUISIANA'S GATEWAY TERMINAL PROPOSED NEW WICK DRAIN PLAN AND SECTION


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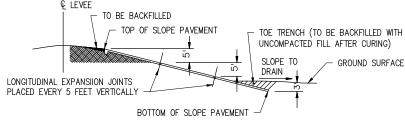
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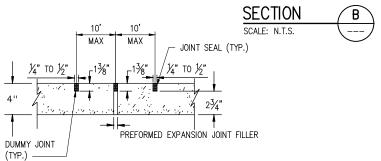
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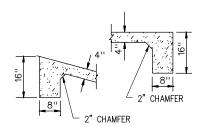




HORIZONTAL EXPANSION JOINT



EXPANSION AND DUMMY JOINTS SCALE: N.T.S.

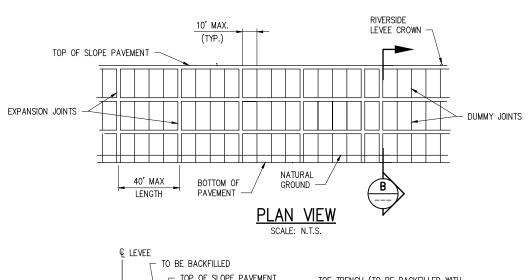

 $8\hbox{''}$ CUT-OFF WALL TO BE CONSTRUCTED ALONG THE TOP AND AT EACH END OF THE PAVEMENT FROM TOP TO BOTTOM.

DETAILS OF CUTOFF WALL SCALE: N.T.S.

SLOPE PAVING DETAILS

NOTES:

- 1. CONCRETE SLOPE PAVEMENT IS REQUIRED WHEN FOOTINGS RESTS ON LEVEE SLOPE. PAVEMENT MUST EXTEND 5' EACH SIDE OF FOOTINGS.
- 2. IN THE ABSENCE OF FOOTING ON LEVEE, LANDSIDE SLOPE PAVING WILL NOT BE REQUIRED. RIVERSIDE SLOPE PAVING WILL BE REQUIRED WHEN NECESSARY FOR EROSION CONTROL.
- S. SMOOTH TRANSITIONS SHALL BE CONSTRUCTED BETWEEN THE LEVEE ENLARGEMENT AND EXISTING LEVEE.
- 4. ALL FRESH FILL SHALL BE SODDED OR FERTILIZED AND SEEDED AND SHALL BE MAINTAINED UNTIL A HEALTHY GROWTH IS OBTAINED.
- 5. THE CROWN OF THE ENLARGED LEVEE SHALL BE SURFACED WITH ROADWAY WASHED GRAVEL SIX INCHES IN THICKNESS OR NINE INCHES IN THICKNESS FOR FULL WIDTH (10' MIN.) AND LENGTH OF RAMP.
- 6. FILL MATERIAL USED IN CONSTRUCTION OF THE LEVEE ENLARGEMENT, RAMPS, PIPE COVER, AND BACKFILL OF EXCAVATION SHALL BE IMPERVIOUS EARTH FILL.
- PIPELINE MARKERS SHALL BE PLACED AND MAINTAINED AT EACH TOE OF LEVEE IN LINE WITH PIPE CROSSING AND INDICATING OWNER, SIZE AND NUMBER OF LINES, PRODUCT AND ADDRESS FOR CONTACTING OWNER.

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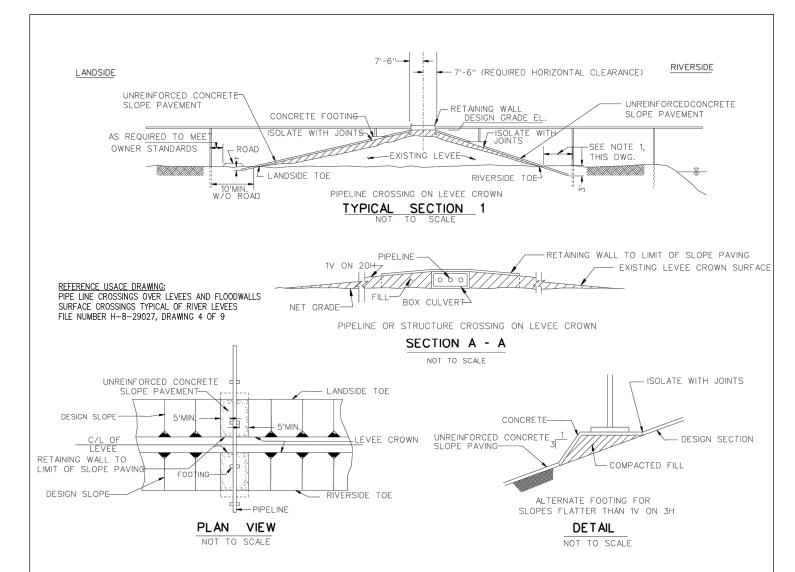
LOUISIANA'S GATEWAY TERMINAL USACE SLOPE PAVING DETAILS

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FMBANKMENT REQUIREMENTS

COMPACTED FILL: (LEVEE ACCESS ROADS AND FOOTINGS)THE MATERIAL FOR COMPACTED FILL SHALL BE PLÀCED IN LAYERS. THE FIRST LAYER NOT MORE THAN 4 INCHES IN THICKNESS AND THE SUCCEEDING LAYERS NOT MORE THAN 8 INCHES IN THICKNESS PRIOR TO COMPACTION. EACH LAYER SHALL BE COMPACTED BY 10 COMPLETE PASSES OF A CRAWLER— TYPE TRACTOR WEIGHING NOT LESS THAN 20.000 POUNDS AND EXERTING A UNIT TREAD PRESSURE OF NOT LESS THAN 6 POUNDS PER SQUARE INCH. THE TRACTOR SHALL BE OPERATED AT SPEEDS NOT TO EXCEED 3.5 MILES PER HOUR. IF AN ALTERNATE TYPE COMPACTING MACHINE IS USED, TYPE SHOULD BE STATED ON APPLICANT'S DRAWING FOR REVIEW AND APPROVAL.

SEMICOMPACTED FILL: (LEVEE)

THE MATERIAL FOR SEMICOMPACTED FILL SHALL BE PLACED OR SPREAD IN LAYERS. THE FIRST LAYER NOT MORE THAN 6 INCHES IN THICKNESS AND THE SUCCEEDING LAYERS NOT MORE THAN 12 INCHES IN THICKNESS PRIOR TO COMPACTION. EACH LAYER SHALL BE COMPACTED BY THREE COMPLETE PASSES OF A CRAWLER-TYPE TRACTOR WEIGHING NOT LESS THAN 20,000 POUNDS AND EXERTING A UNIT TREAD PRESSURE OF NOT LESS THAN 6 POUNDS PER SQUARE INCH. THE TRACTOR SHALL BE OPERATED AT SPEEDS NOT TO EXCEED 3.5 MILES PER HOUR. IF AN ALTERNATE TYPE COMPACTING MACHINE IS USED, TYPE SHOULD BE STATED ON APPLICANT'S DRAWING FOR REVIEW AND APPROVAL

UNCOMPACTED FILL: (BERMS AND BACKFILL) THE MATERIAL FOR UNCOMPACTED FILL SHALL BE PLACED IN APPROXIMATELY HORIZONTAL LAYERS NOT EXCEEDING 3 FEET IN THICKNESS THE LAYERS SHALL BEUNIFORMLY SPREAD, DISTRIBUTED, AND OTHERWISE MANIPULATED DURING PLACEMENT TO SUCH AN EXTENT THAT INDIVIDUAL LOADS OF MATERIAL DEPOSITED ON THE FILL WILL NOT REMAIN INTACT, AND LARGE, OPEN VOIDS IN THE FILL WILL BE ELIMINATED.

SLOPE PAVEMENT DETAILS

NOTES:

- 10' MIN. OR AS REQUIRED TO AVOID PENETRATION OF CONCRETE SLOPE PAVEMENT.
- CONCRETE SLOPE PAVEMENT IS REQUIRED WHEN FOOTINGS RESTS ON LEVEE SLOPE, PAVEMENT MUST EXTEND 5' EACH SIDE OF FOOTINGS.
- IN THE ABSENCE OF FOOTING ON LEVEE, LANDSIDE SLOPE PAVING WILL NOT BE REQUIRED. RIVERSIDE SLOPE PAVING WILL BE REQUIRED WHEN NECESSARY FOR
- SMOOTH TRANSITIONS SHALL BE CONSTRUCTED BETWEEN THE LEVEE ENLARGEMENT AND EXISTING LEVEE.
- ALL FRESH FILL SHALL BE SODDED OR FERTILIZED AND SEEDED AND SHALL BE MAINTAINED UNTIL A HEALTHY GROWTH IS OBTAINED.
- THE CROWN OF THE ENLARGED LEVEE SHALL BE SURFACED WITH ROADWAY WASHED GRAVEL SIX INCHES IN THICKNESS OR NINE INCHES IN THICKNESS FOR FULL WIDTH (10' MIN.) AND LENGTH OF RAMP.
- FILL MATERIAL USED IN CONSTRUCTION OF THE LEVEE ENLARGEMENT, RAMPS, PIPE COVER, AND BACKFILL OF EXCAVATION SHALL BE IMPERVIOUS EARTH FILL.
- PIPELINE MARKERS SHALL BE PLACED AND MAINTAINED AT EACH TOE OF LEVEE IN LINE WITH PIPE CROSSING AND INDICATING OWNER, SIZE AND NUMBER OF LINES, PRODUCT AND ADDRESS FOR CONTACTING OWNER

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DATE MAR. 2022

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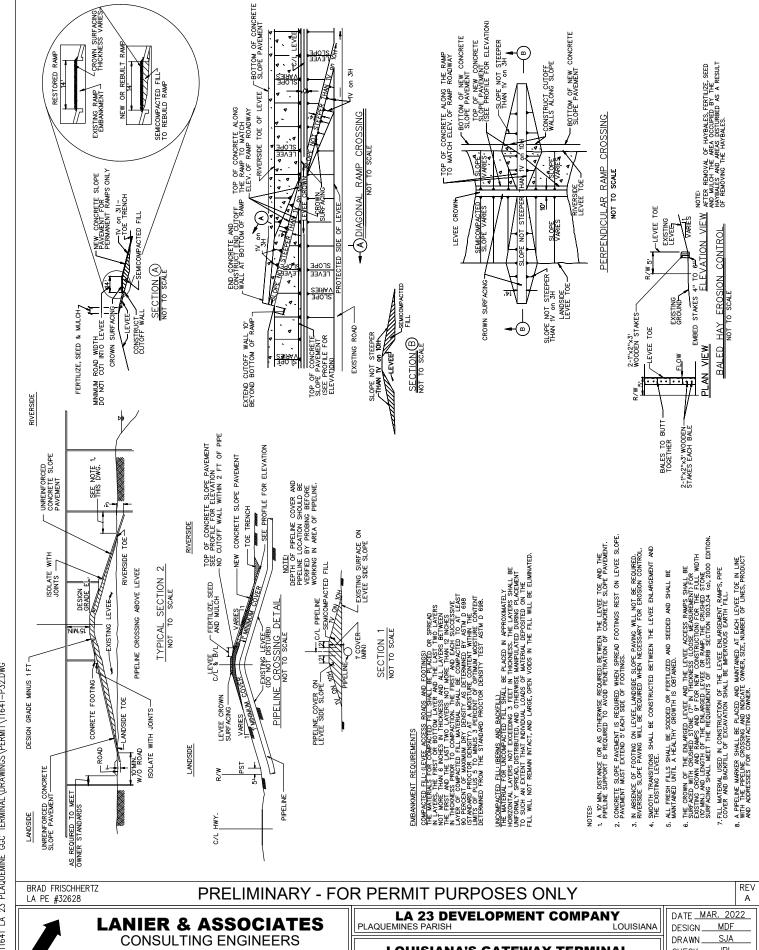
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LOUISIANA'S GATEWAY TERMINAL **USACE LEVEE PIPE CROSSING DETAILS**



LOUISIANA'S GATEWAY TERMINAL

FOR RIVER LEVEES

USACE SURFACE CROSSINGS

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