

PUBLIC NOTICE

April 11, 2022

United States Army
Corps of Engineers
New Orleans District
Attn: Regulatory Division, RGW
7400 Leake Ave.
New Orleans, Louisiana 70118-3651

Project Manager:
Sara Fortuna
(504) 862-2284
sara.b.fortuna@usace.army.mil
Application #: MVN-2022-00296 WKK

Interested parties are hereby notified that a permit application has been received by the New Orleans District of the U.S. Army Corps of Engineers pursuant to: [X] Section 10 of the Rivers and Harbors Act of March 3, 1899 (30 Stat. 1151; 33 USC 403); and/or [X] Section 404 of the Clean Water Act (86 Stat. 816; 33 USC 1344).

BOATHOUSE, DOCK, BULKHEAD, AND FILL IN JEFFERSON DAVIS PARISH

NAME OF APPLICANT: Terrell Investments, L.L.C., c/o: Cypress Environment and Infrastructure, 906 DeSoto Street, Ocean Springs, Mississippi 39564.

LOCATION OF WORK: Located in Jefferson Davis Parish, Lake Arthur, off Pom Roy Road, in the community of Lake Arthur, Louisiana, Latitude North: 30.045121°N, Longitude West: -92.736989°W, as shown within the attached drawings. (Hydrologic Unit Code 08080202, Mermentau Basin).

CHARACTER OF WORK: Construct an approximately 51-foot wide by 67-foot long boathouse and a 9.5-foot wide by 100-foot long dock, remove and replace existing bulkhead to install 612 feet of new bulkhead, place approximately 1,770 cubic yards of hauled-in fill material behind the bulkhead along Lake Arthur. Approximately 0.192 of an acre of waterbottoms would be permanently impacted via project implementation. It is anticipated that no wetlands would be impacted at the project site. The purpose of the project is to promote bankline erosion protection and recreational activities along Lake Arthur.

The comment period on the requested Department of the Army Permit will close **20 days** from the date of this public notice. Written comments, including suggestions for modifications or objections to the proposed work, stating reasons thereof, are being solicited from anyone having

interest in this permit request, and must be submitted so as to be received before or by the last day of the comment period. Letters and/or comments concerning the subject permit application must reference the Applicant's Name and the Permit Application Number, and can be emailed to the Corps of Engineers project manager listed above, or forwarded to the Corps of Engineers at the address above, **ATTENTION: REGULATORY DIVISION, RGW, "Sara Fortuna"**.

Individuals or parties may also request an extension of time in which to comment on the proposed work by mail or by emailing the specified project manager listed above. Any request for an extension of time to comment must be specific and substantively supportive of the requested extension and received by this office prior to the end of the initial comment period. The Section Chief will review the request and the requestor will be promptly notified of the decision to grant or deny the request. If granted, the time extension will be continuous and inclusive of the initial comment period and will not exceed a total of 30 calendar days.

Corps of Engineers Permit Criteria

The decision whether to issue a permit will be based on an evaluation of the probable impacts, including cumulative impacts of the proposed activity on the public interest. That decision will reflect the national concern for both protection and utilization of important resources. The benefit which reasonably may be expected to accrue from the proposal must be balanced against its reasonably foreseeable detriments. All factors which may be relevant to the proposal will be considered including the cumulative effects thereof; among those are conservation, economics, aesthetics, general environmental concerns, wetlands, historic properties, fish and wildlife values, flood hazards, floodplain values, land use, navigation, shoreline erosion and accretion, recreation, water supply and conservation, water quality, energy needs, safety, food and fiber production, mineral needs, considerations of property ownership and, in general, the needs and welfare of the people.

The U.S. Army Corps of Engineers is soliciting comments from the public, federal, state, and local agencies and officials, Indian Tribes, and other interested parties in order to consider and evaluate the impacts of this proposed activity. Any comments received will be considered by the U.S. Army Corps of Engineers to determine whether to make, modify, condition, or deny a permit for this proposal. To make this decision, comments are used to assess impacts on endangered species, historic properties, water quality, general environmental effects, and other public interest factors listed above. Comments are used in the preparation of an Environmental Assessment and/or an Environmental Impact Statement pursuant to the National Environmental Policy Act. Comments are also used to determine the need for a public hearing and to determine the overall public interest of the proposed activity.

The New Orleans District is unaware of properties listed on the National Register of Historic Places near the proposed work. The New Orleans District is unaware of properties listed on the National Register of Historic Places near the proposed work. The possibility exists that the proposed work may damage or destroy presently unknown archeological, scientific, prehistorical, historical sites, or data. As necessary, copies of this public notice will be sent to the State Archeologist, State Historic Preservation Officer and federally listed tribes regarding potential impacts to cultural resources.

Our initial finding is that the proposed work would neither affect any species listed as endangered by the U.S. Departments of Interior or Commerce, nor affect any habitat designated as critical to the survival and recovery of any endangered species. Based on the Information Planning and Consultation (IPaC) tool for Endangered Species in Louisiana, as signed on January 27, 2020, between the U.S. Army Corps of Engineers, New Orleans and the U.S. Fish and Wildlife Service, it has been determined that the project would have no effect to any listed species.

This notice initiates the Essential Fish Habitat (EFH) consultation requirements of the Magnuson-Stevens Fishery Conservation and Management Act. The applicant's proposal may result in the destruction, alteration, and/or disturbance of **0.192 of an acre** of EFH utilized by various life stages of red drum and penaeid shrimp. Our initial determination is that the proposed action would not have a substantial adverse impact on EFH or federally managed fisheries in the Gulf of Mexico. Our final determination relative to project impacts and the need for mitigation measures is subject to review by and coordination with the National Marine Fisheries Service.


If the proposed work involves deposits of dredged or fill material into navigable waters, the evaluation of the probable impacts will include the application of guidelines established by the Administrator of the Environmental Protection Agency. Also, a certification that the proposed activity will not violate applicable water quality standards will be required from the LA Department of Environmental Quality before a Department of the Army permit is issued.

Any person may request, in writing, within the comment period specified in this notice, that a public hearing be held to consider this application. Requests for public hearings shall state, with particularity, the reasons for holding a public hearing.


You are invited to communicate the information contained in this notice to any other parties whom you deem likely to have interest in the matter.

Darrell S. Barbara
Chief, Western Evaluation Branch
Regulatory Division

Enclosures

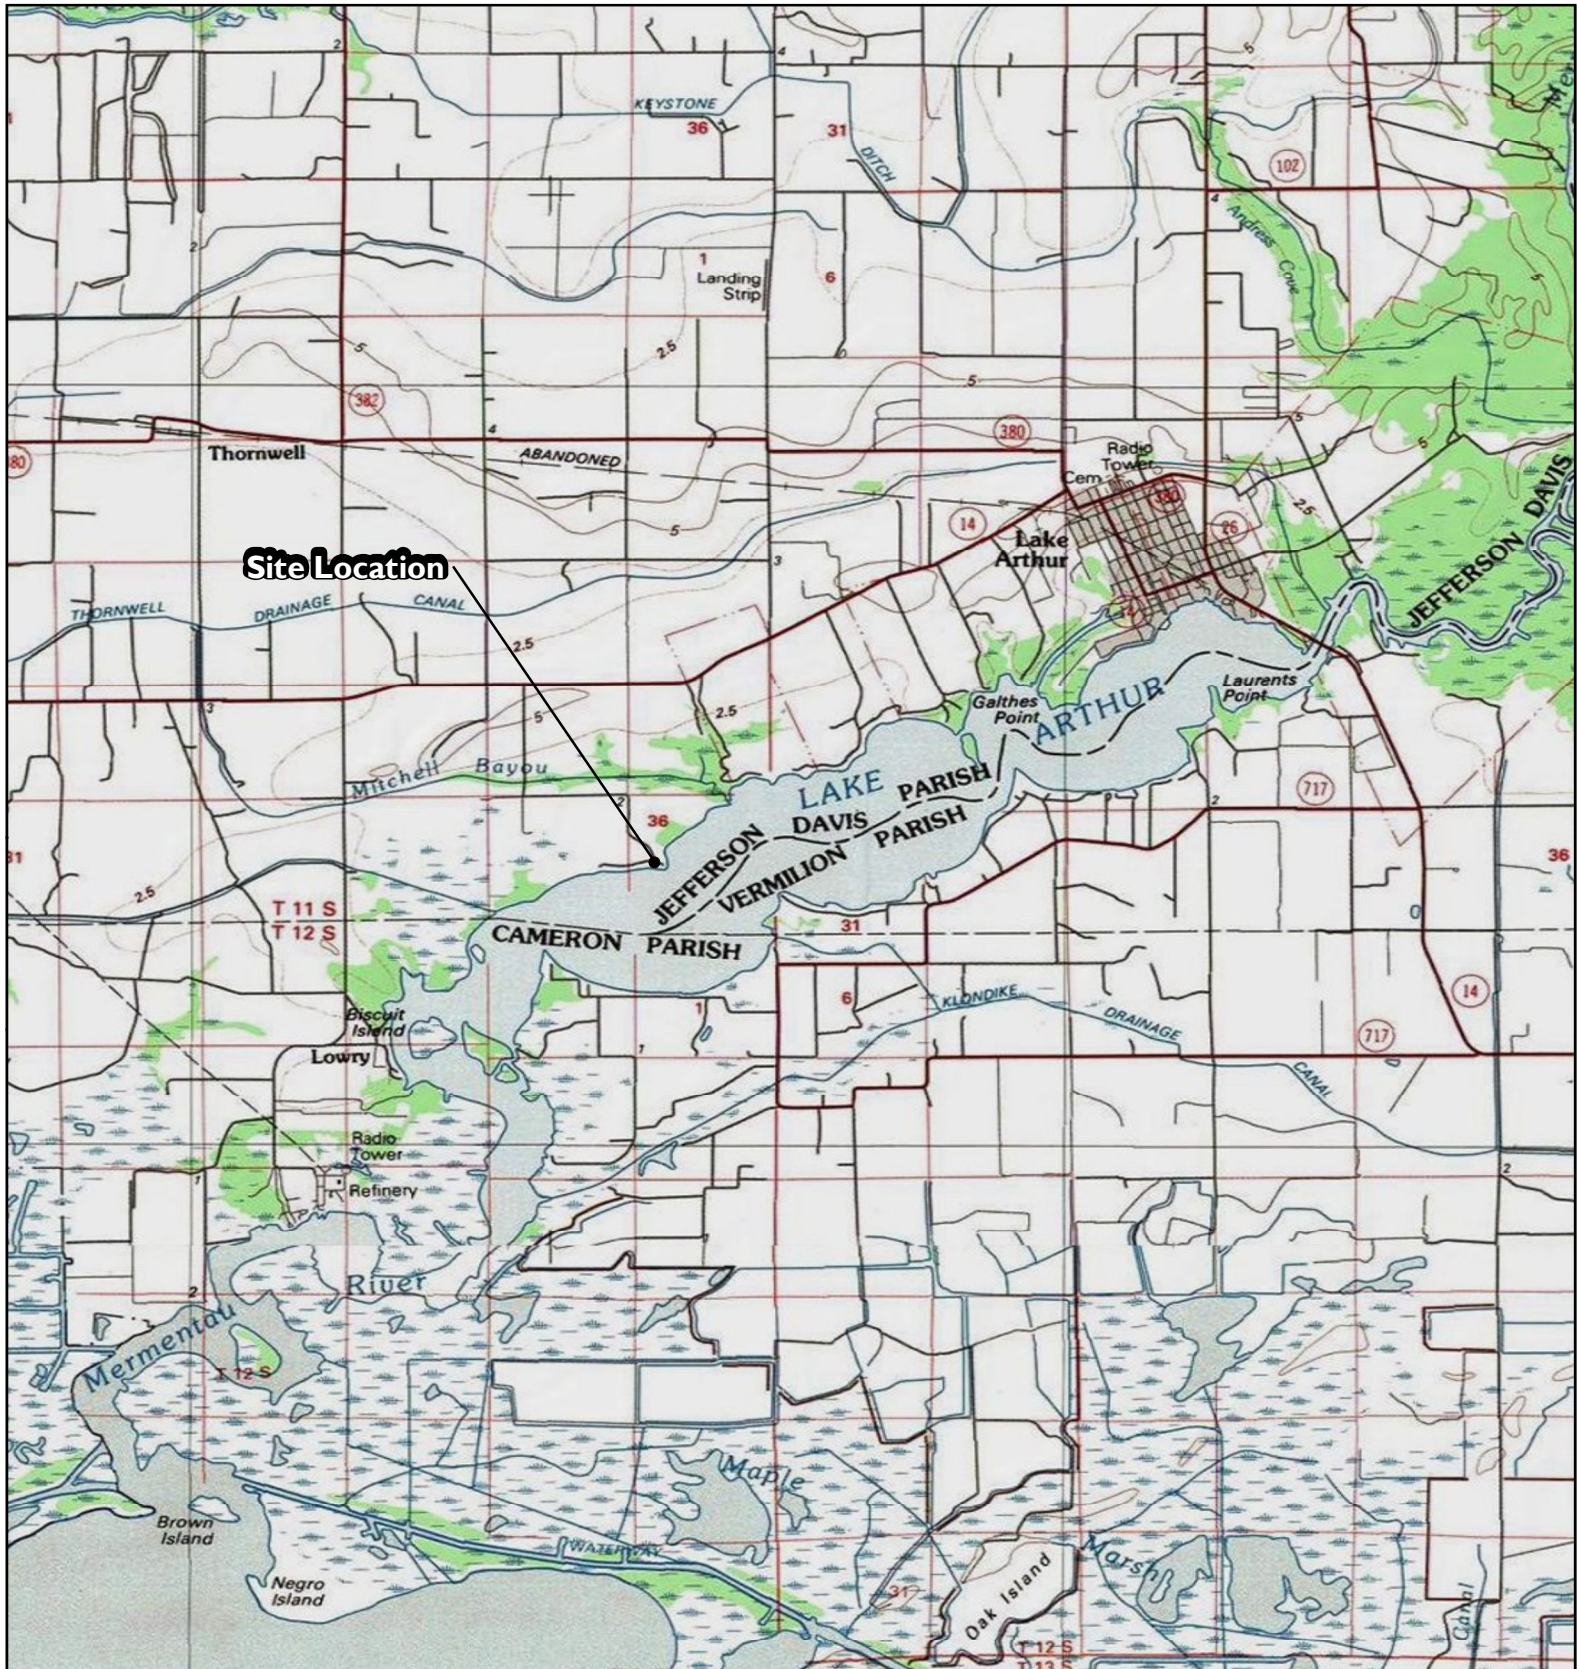

Source: National Geographic USA Topo Maps

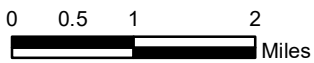

Coordinate System:
NAD 1983 UTM Zone 15N

Residential Boathouse & Bulkhead
1002 Pom Roy Road
Jefferson Davis Parish, Louisiana

VICINITY MAP






FIGURE I




Proposed Boathouse & Lift
167 Feet (waterward length) x 51.5 Feet (width)

Legend

-  Project Workspace
-  Proposed Bulkhead: 612 Linear Feet
-  Proposed Fill within Waters of the US: 0.28 Acres (1,770 cu yds)

Source: National Geographic USA Topo Maps

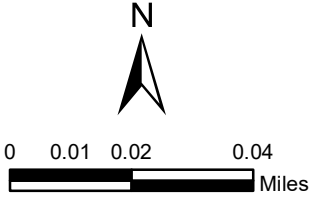

Coordinate System:
 NAD 1983 UTM Zone 15N

Residential Boathouse & Bulkhead
 1002 Pom Roy Road
 Jefferson Davis Parish, Louisiana

PROJECT OVERVIEW



FIGURE 2




Architecture Interiors Graphics Urban Design
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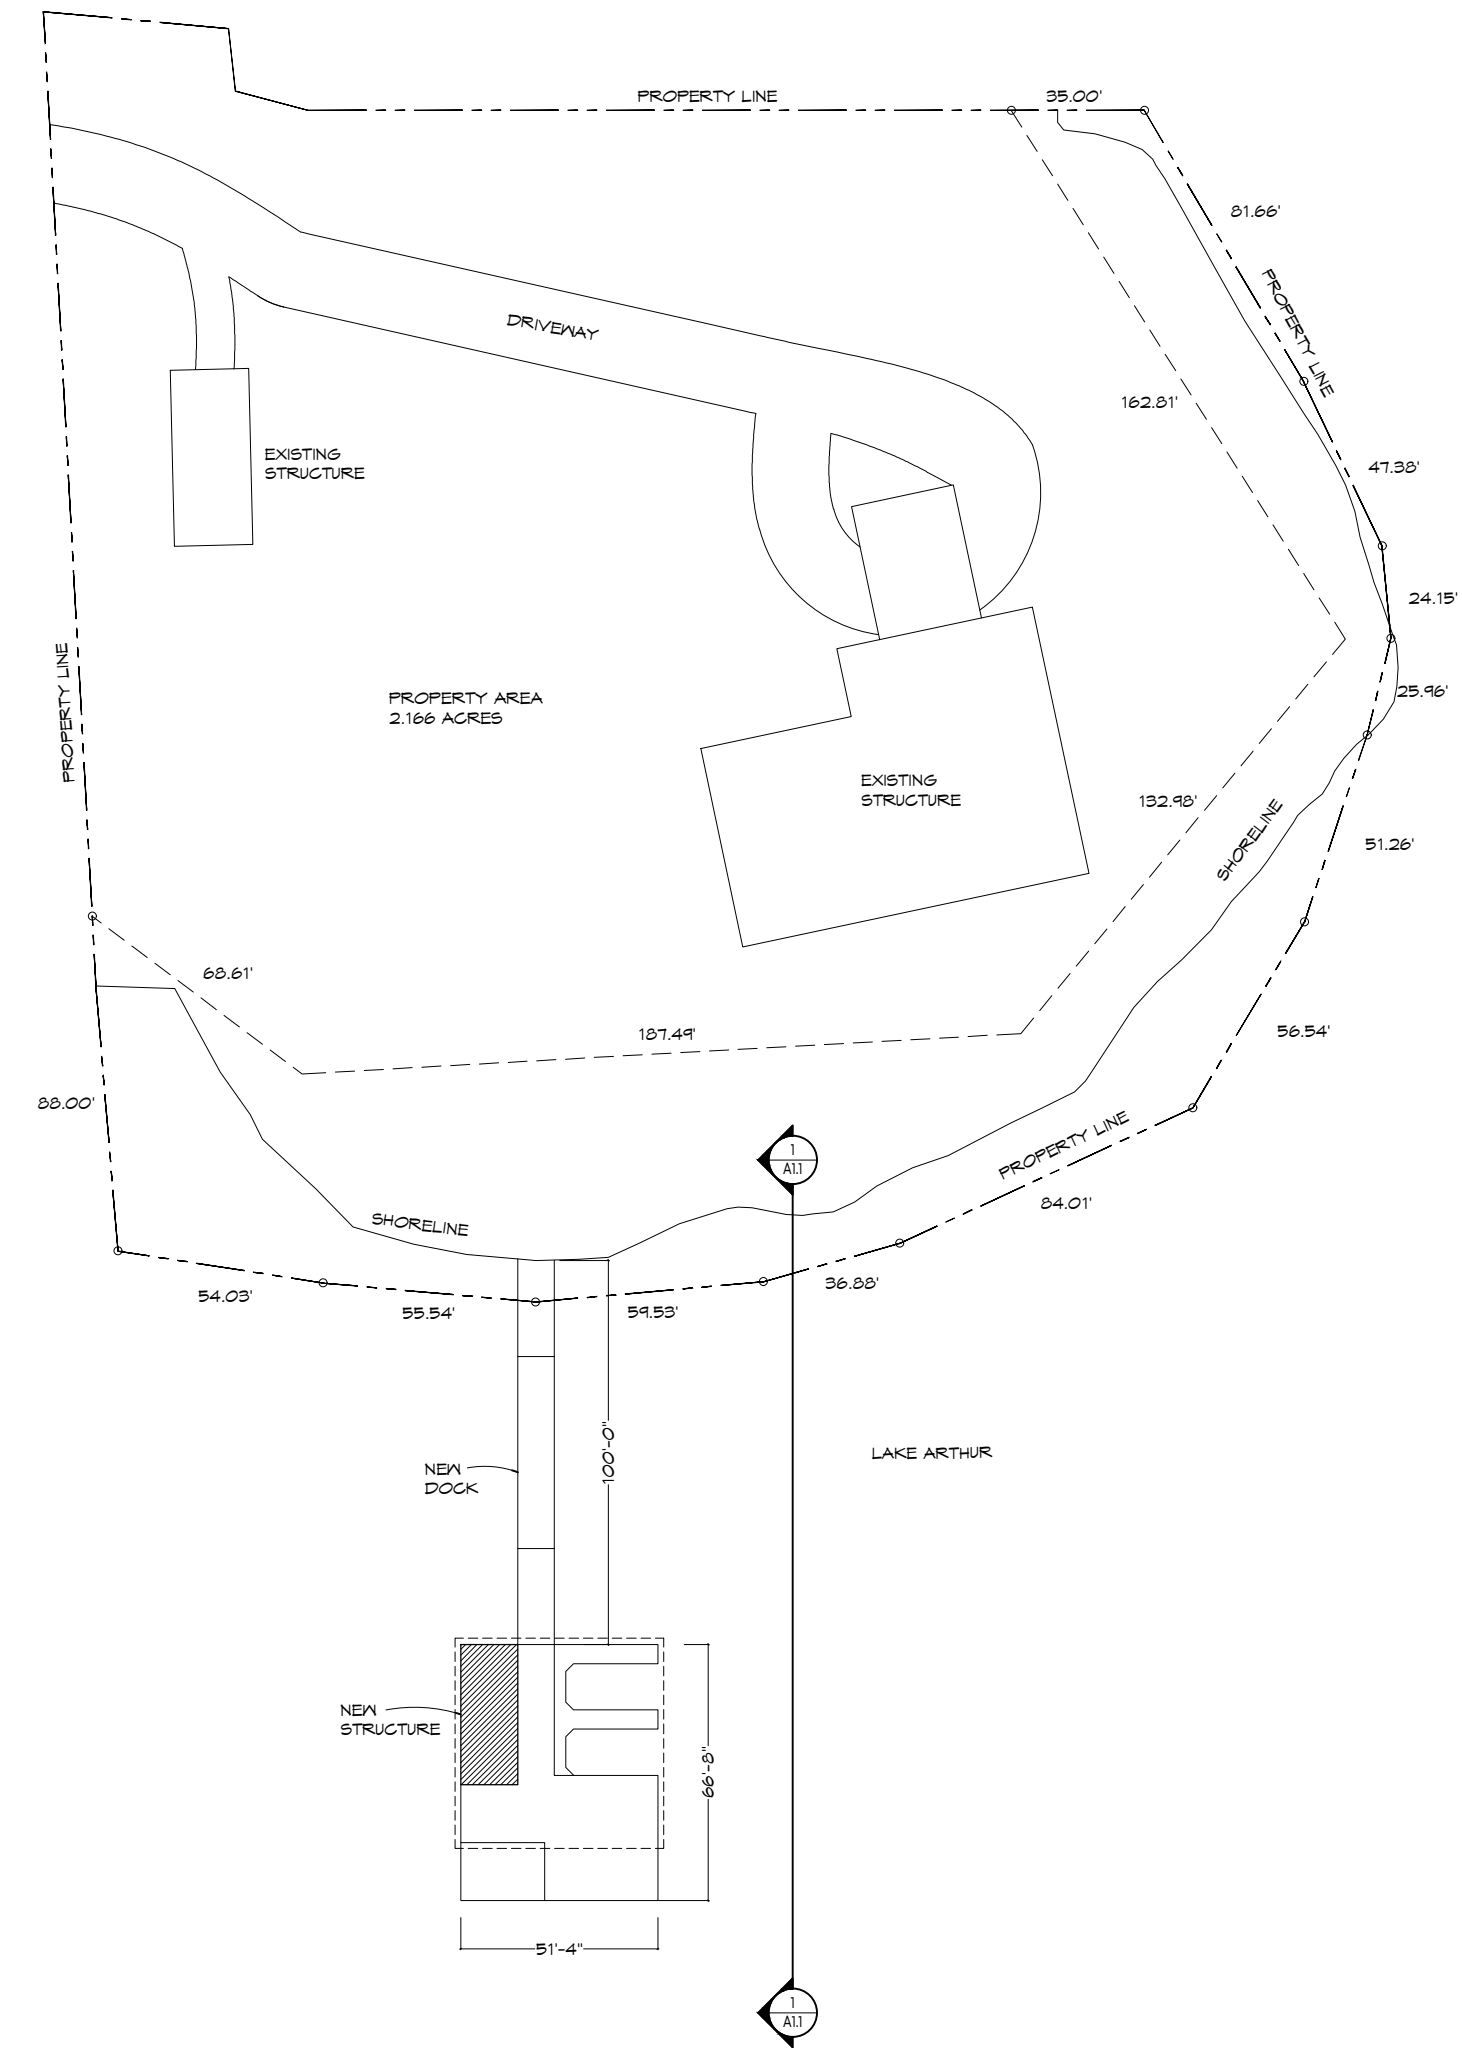
TERRELL
 BOATHOUSE
 LAKE ARTHUR, LOUISIANA

Issues and Revisions


No.	Date	Issues
01	21.12.17	

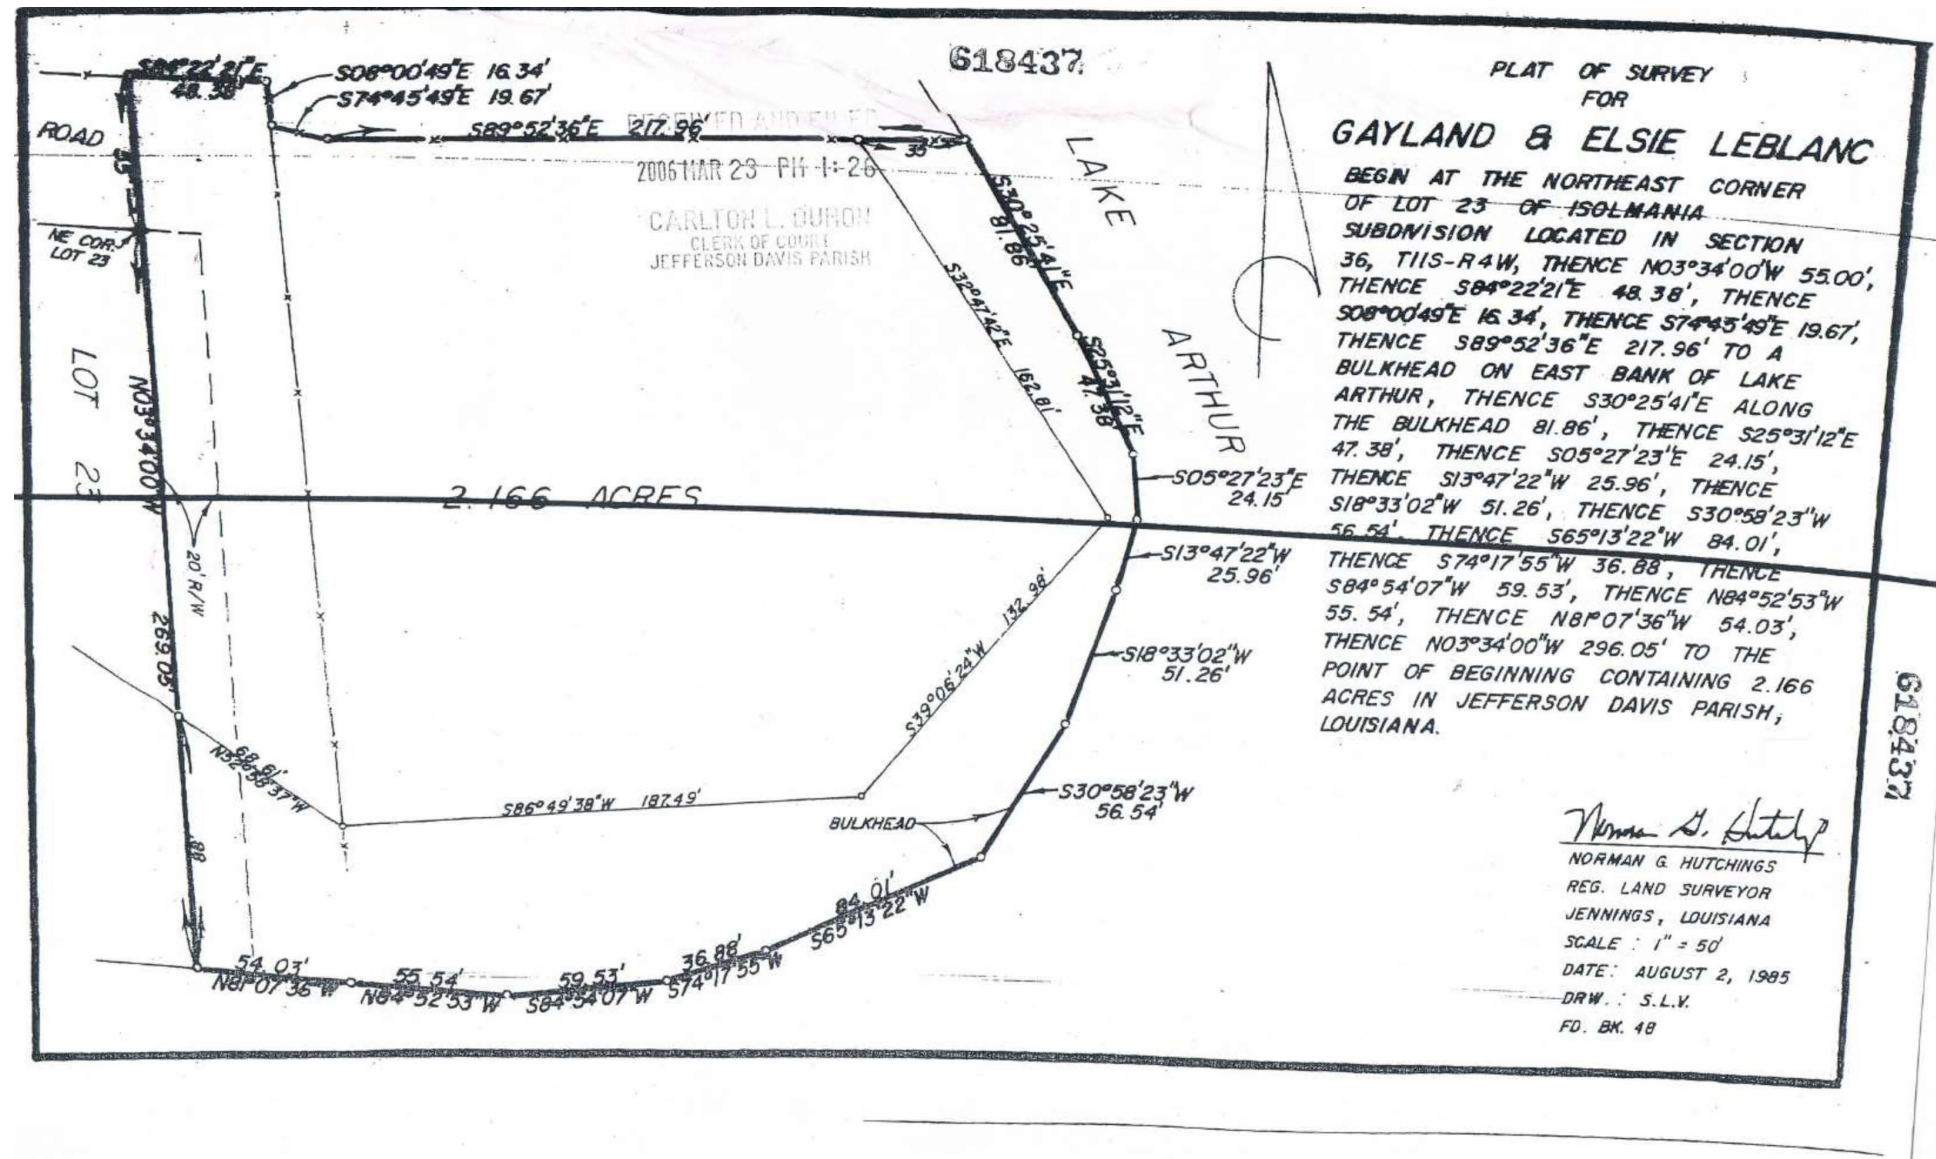

3 SURVEY
 SCALE: N/A



2 SITE PLAN
 SCALE: 1" = 50'-0"

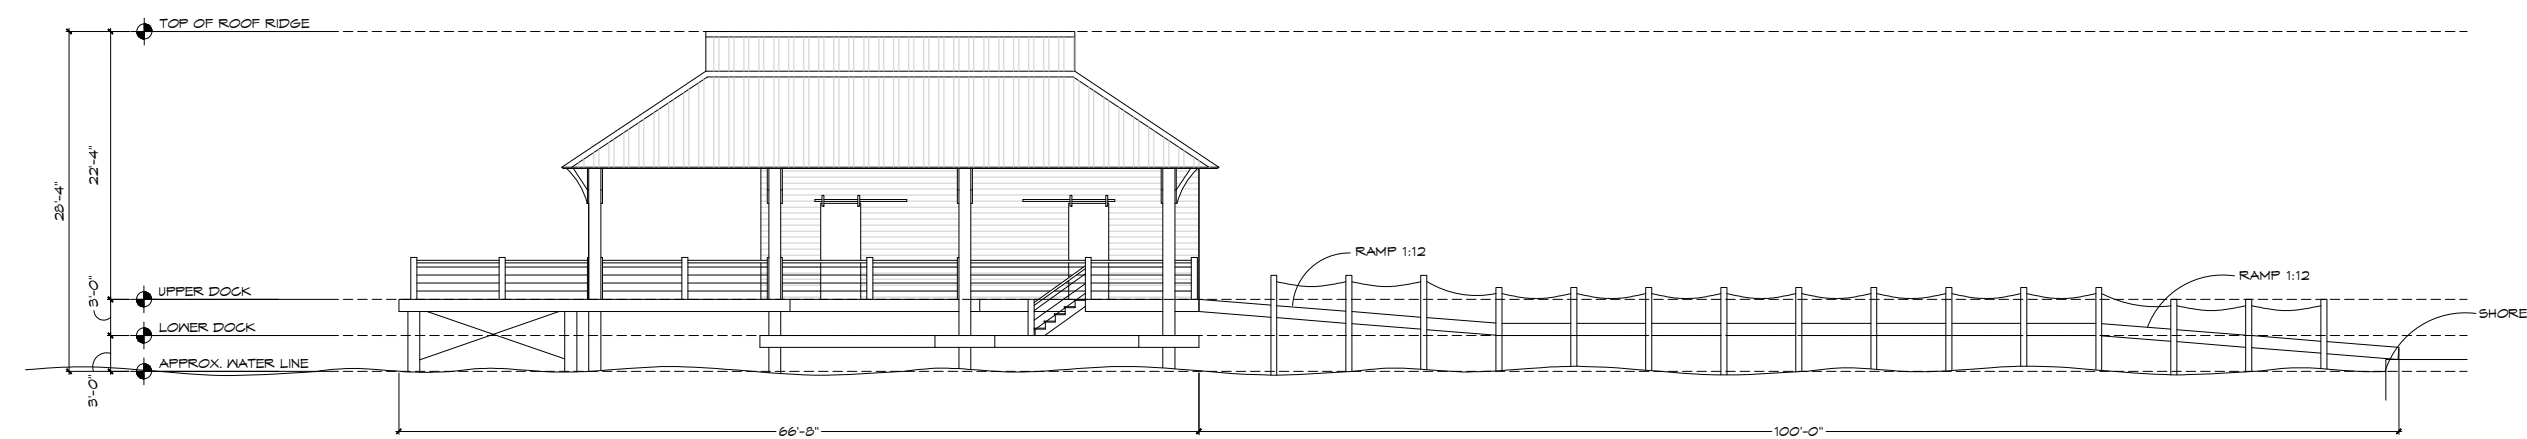

1 SITE CROSS SECTION
 SCALE: 1/16" = 1'-0"

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Seal

Name: Michael T. Sullivan, AIA

Project Number: 00.00000.00

Builder:

Phone:

Fax:

Drawing Name:

SITE

Drawn By:


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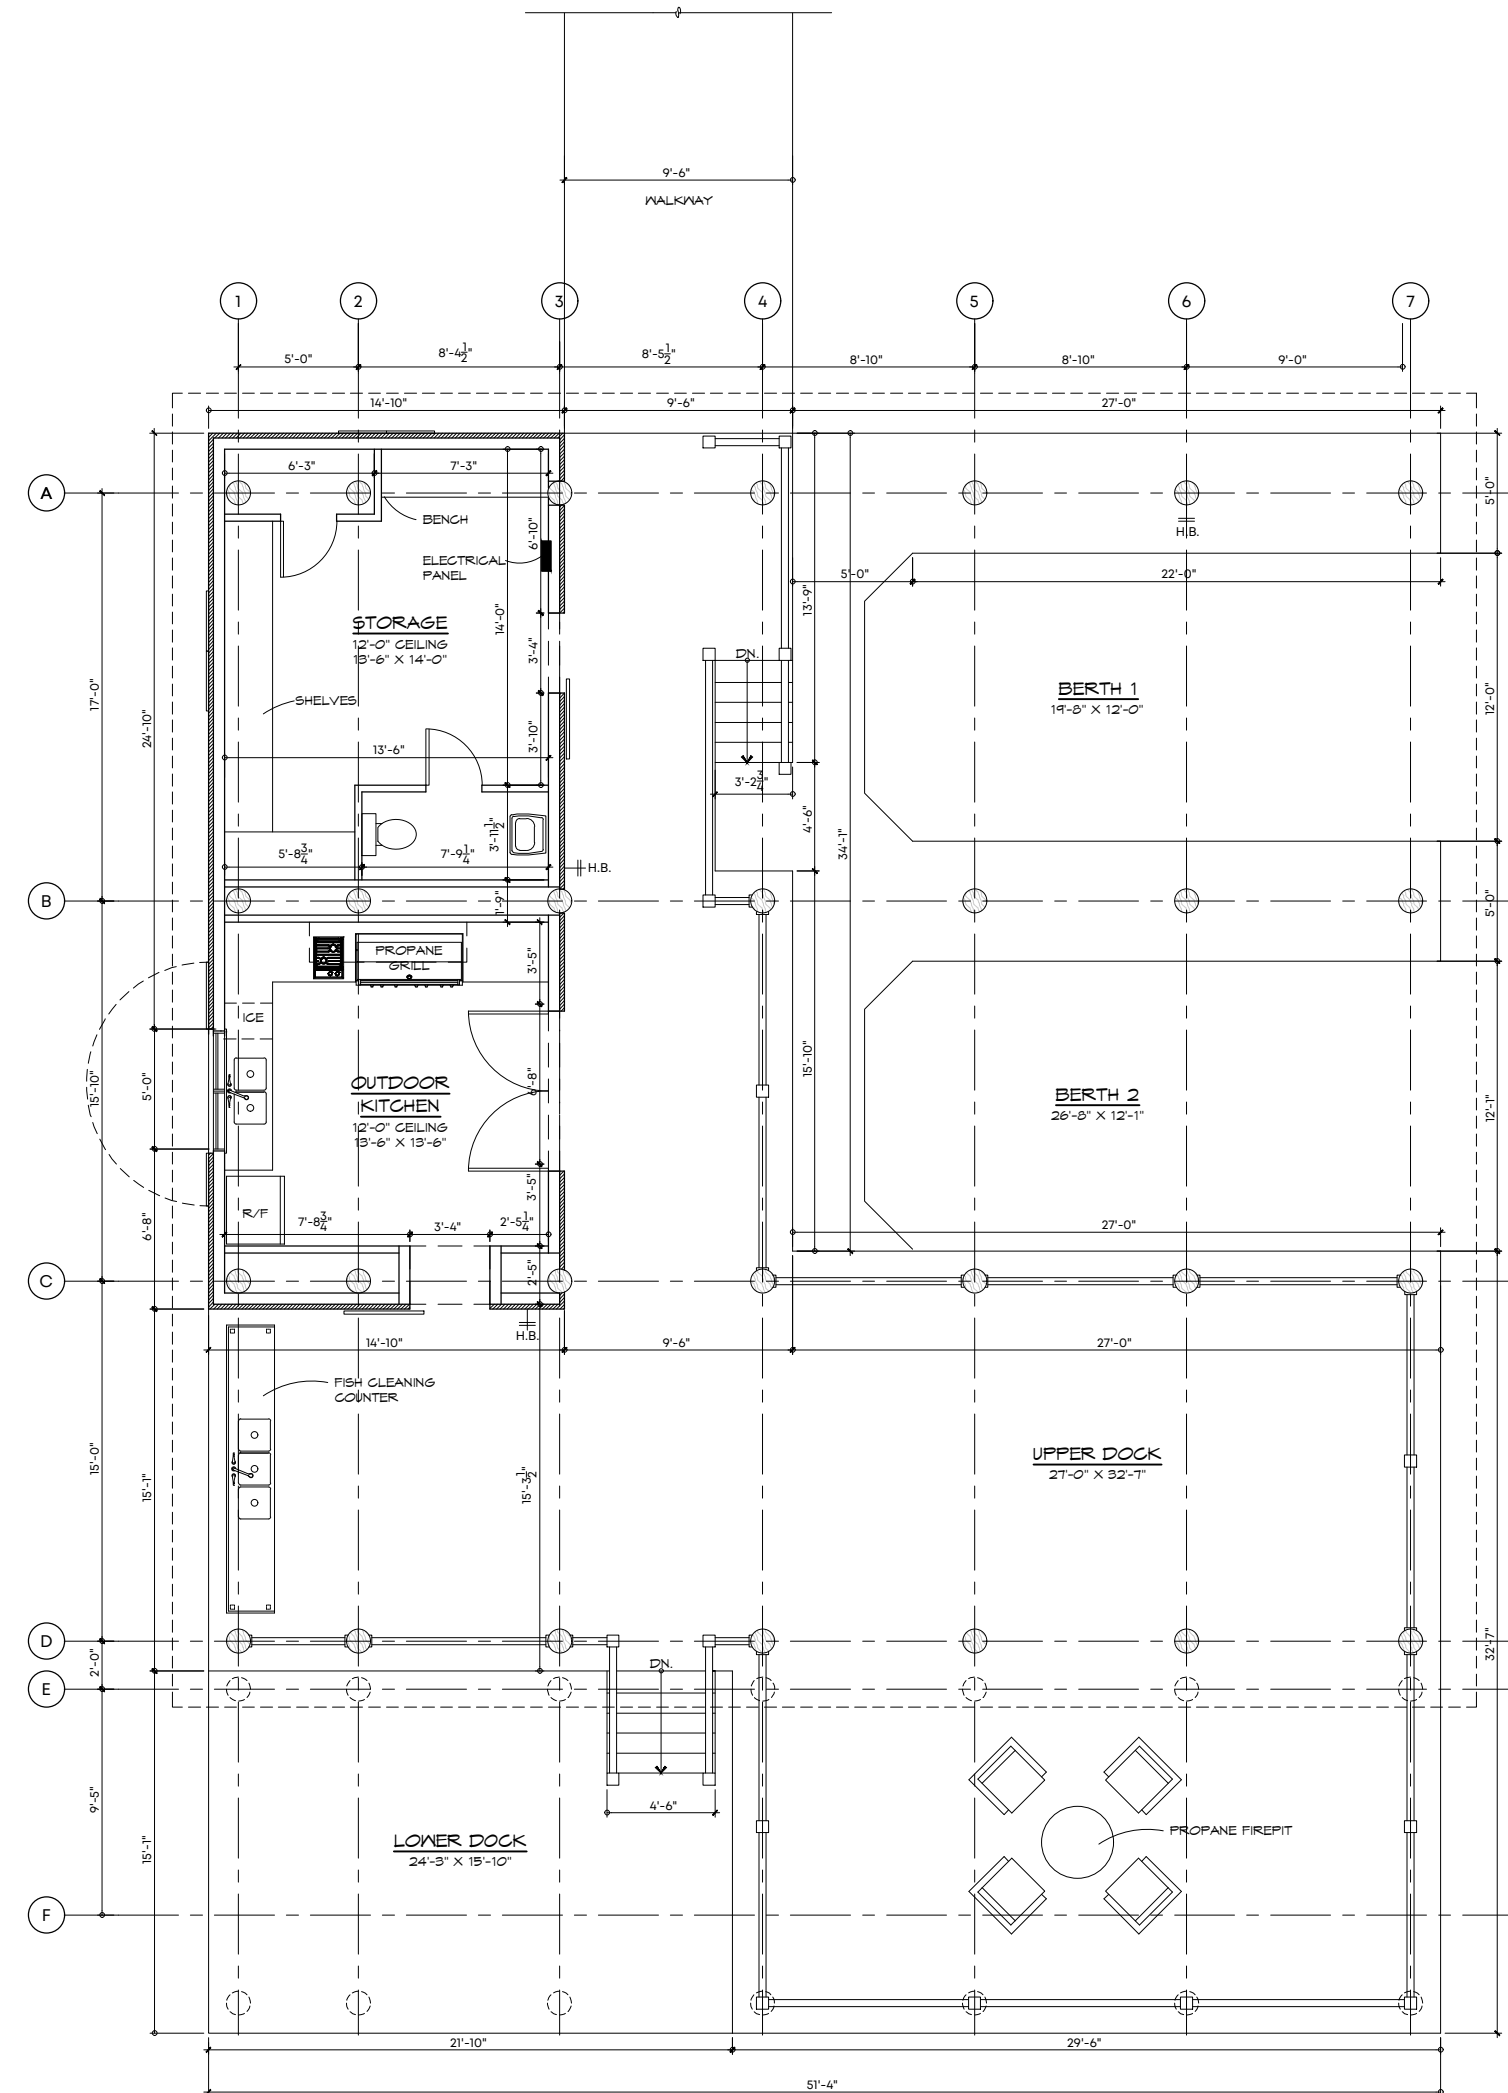


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TERRELL
 BOATHOUSE
 LAKE ARTHUR, LOUISIANA



2 ROOF PLAN
 SCALE: 1/8" = 1'-0"

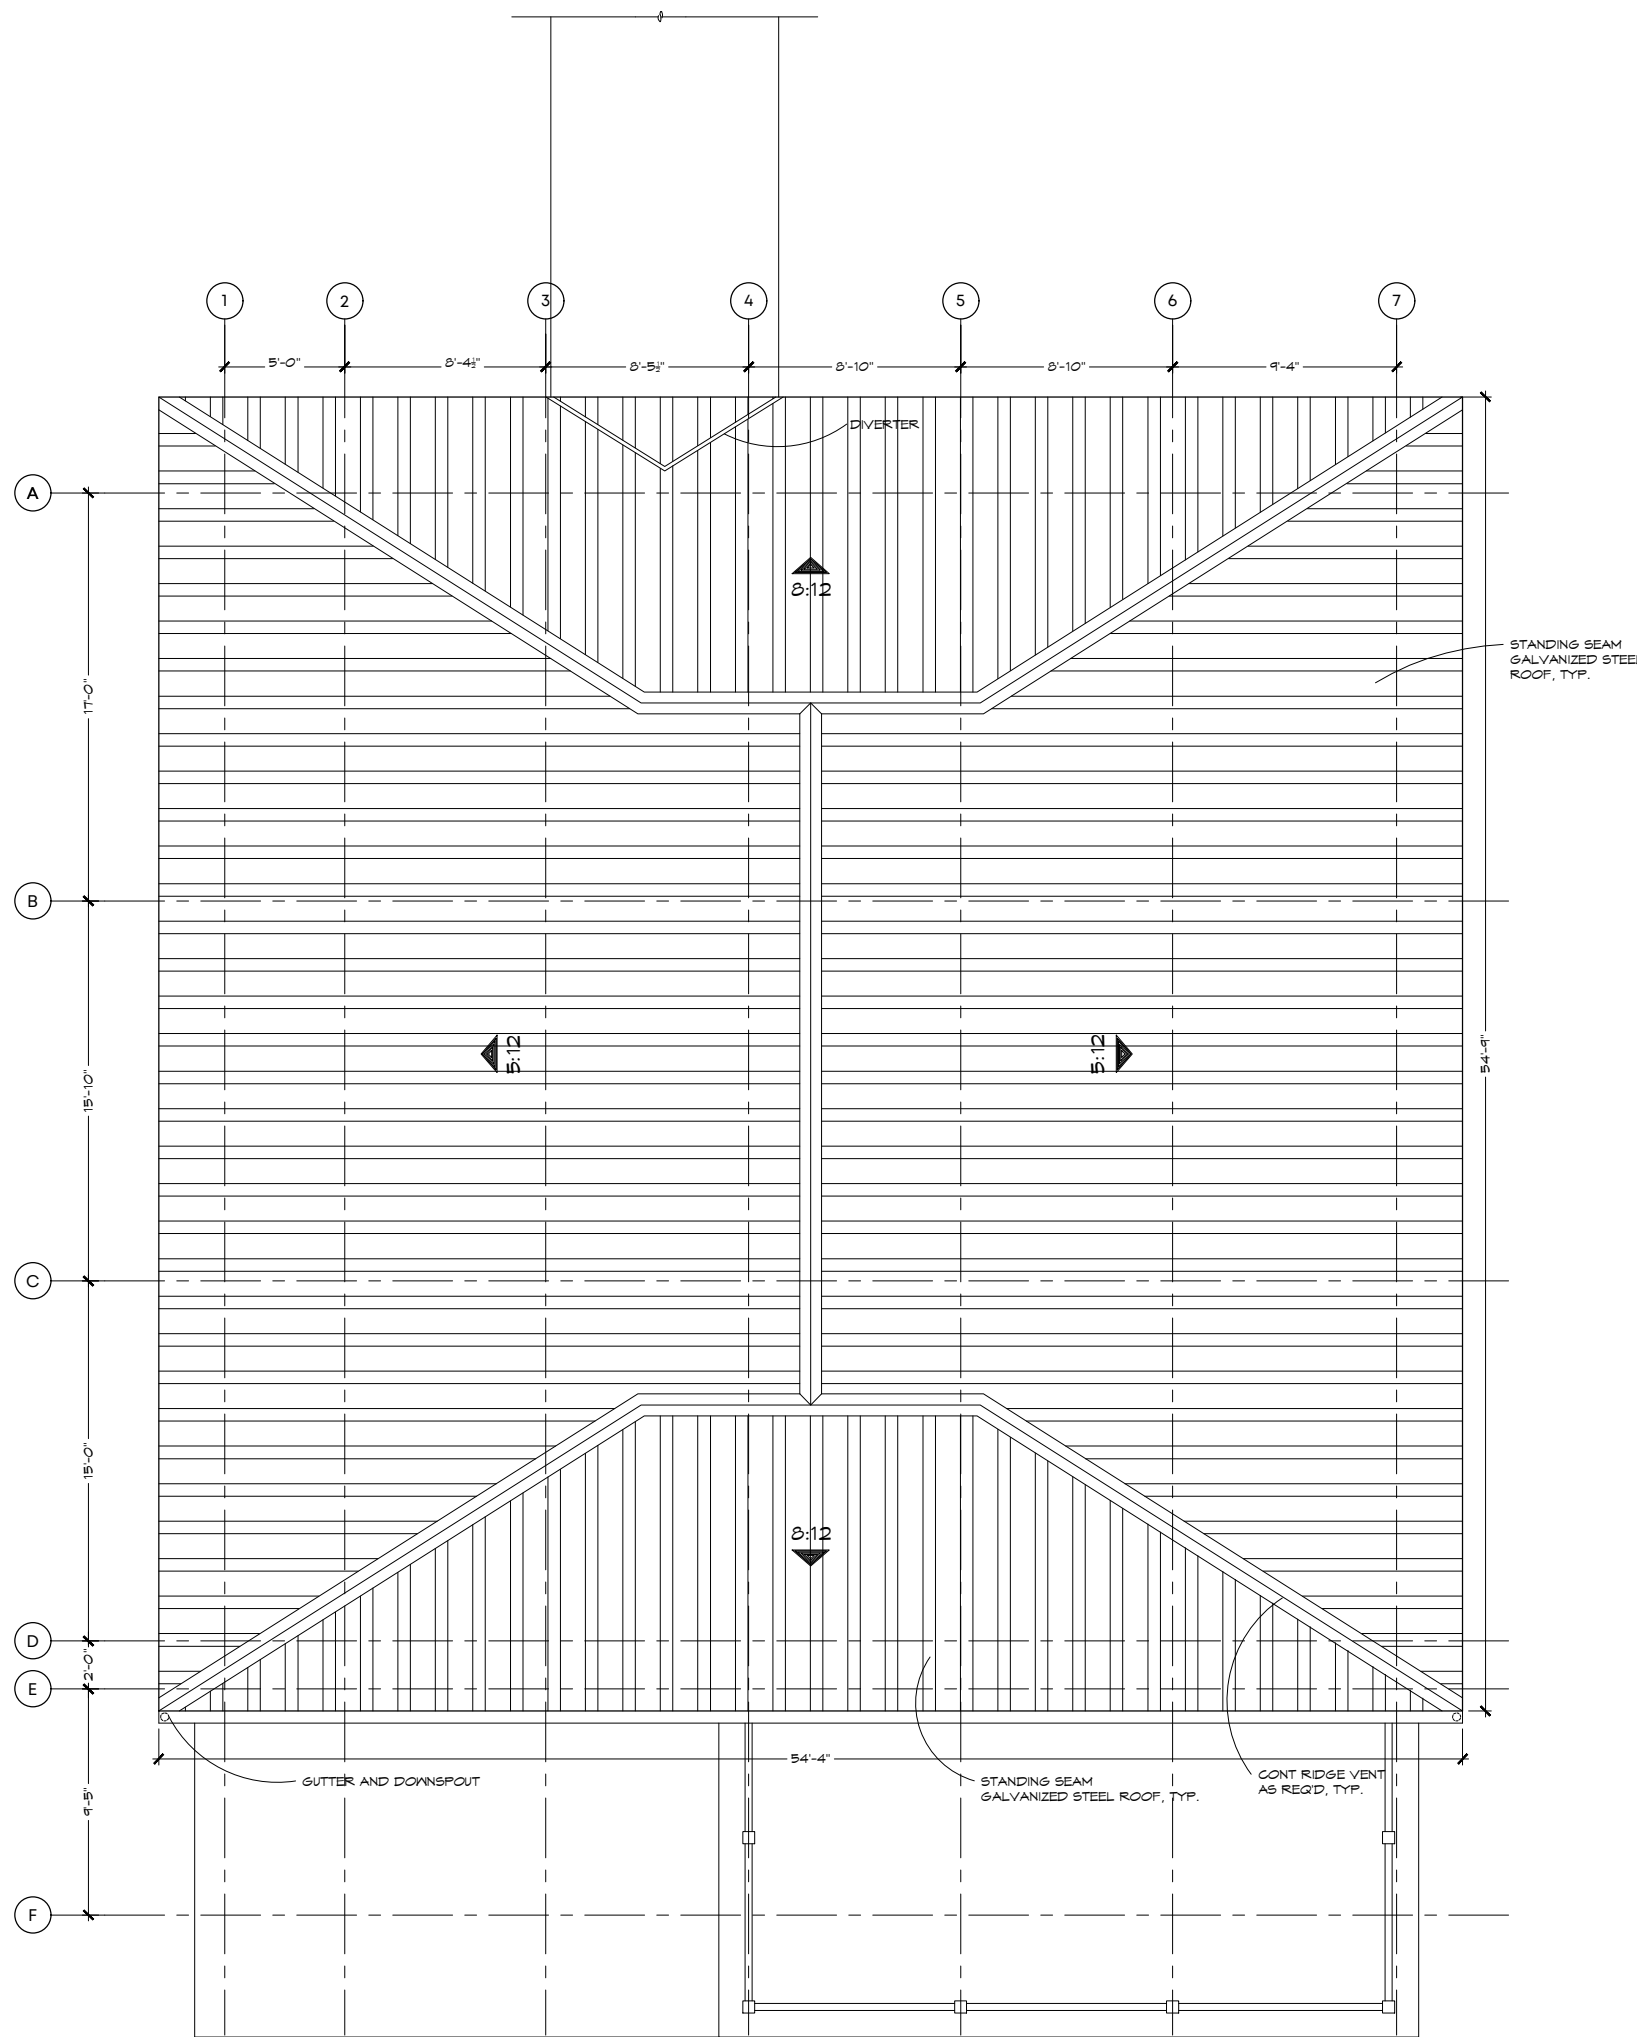

1 FIRST FLOOR PLAN
 SCALE: 1/8" = 1'-0"

Issues and Revisions

No.	Date	Issues
01	21.12.17	

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Project Number: 00.00000.00

Builder:

Phone:

Fax:

Drawing Name:

PLANS

Drawn By:


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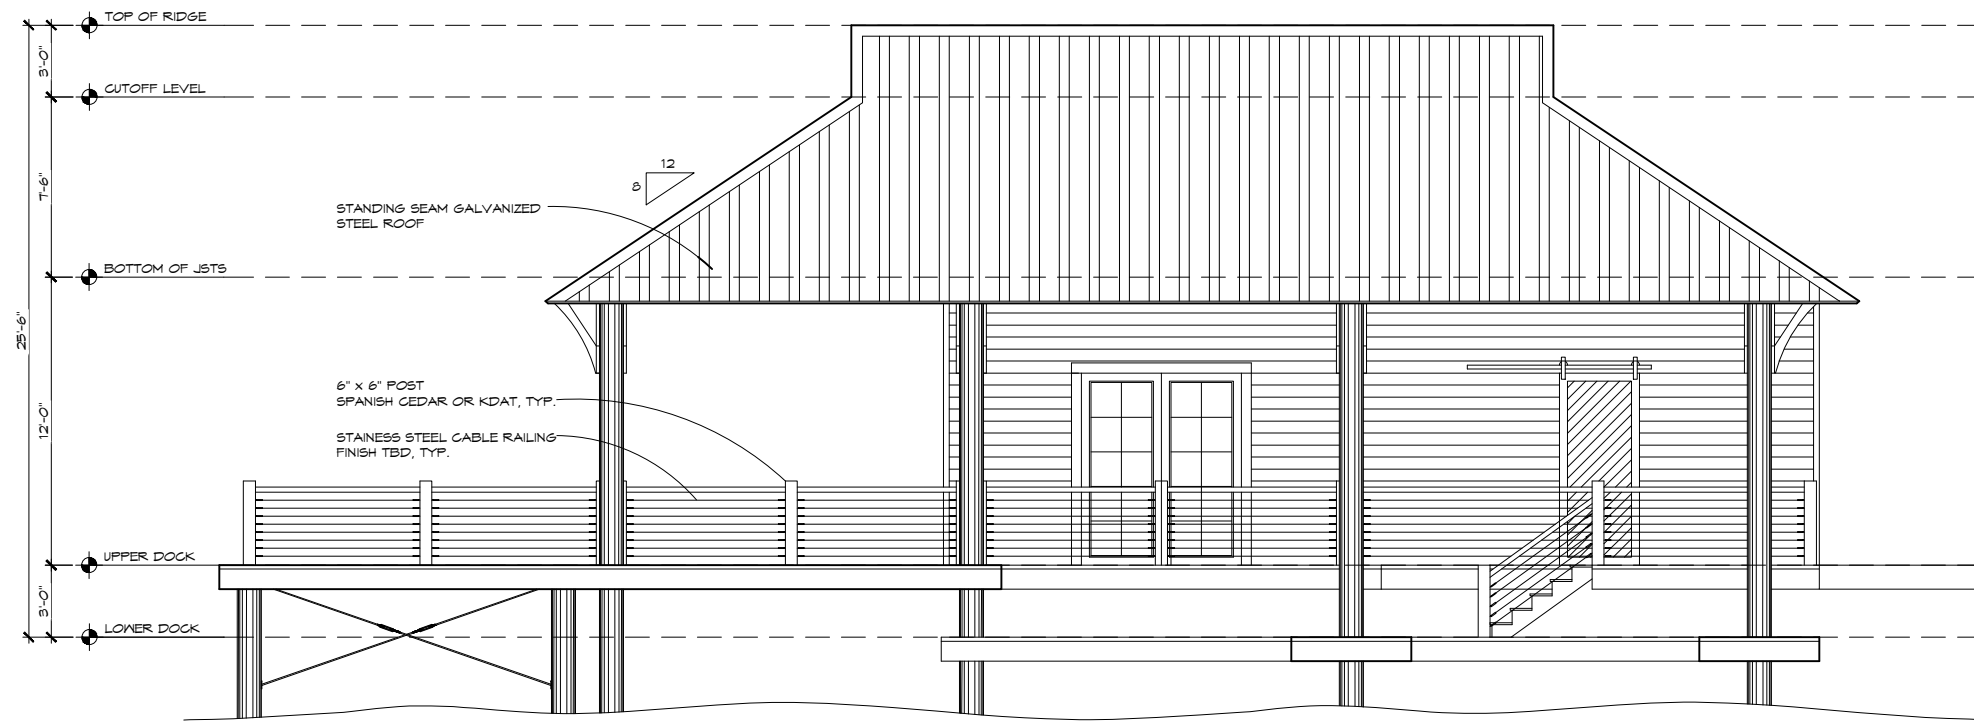


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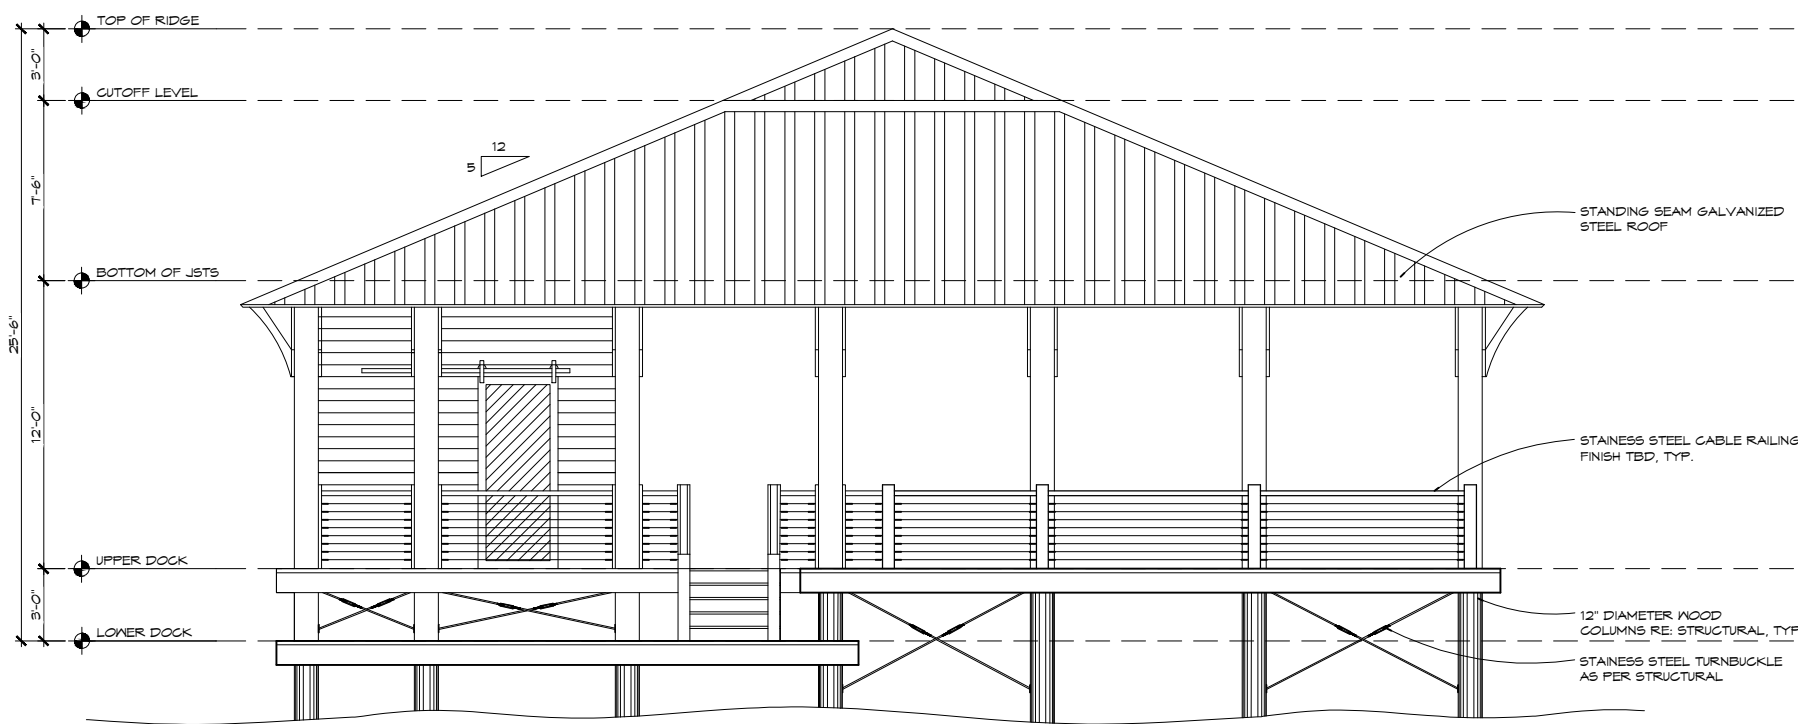
TERRELL
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 LAKE ARTHUR, LOUISIANA




4 NORTH ELEVATION
 SCALE: 1/8" = 1'-0"

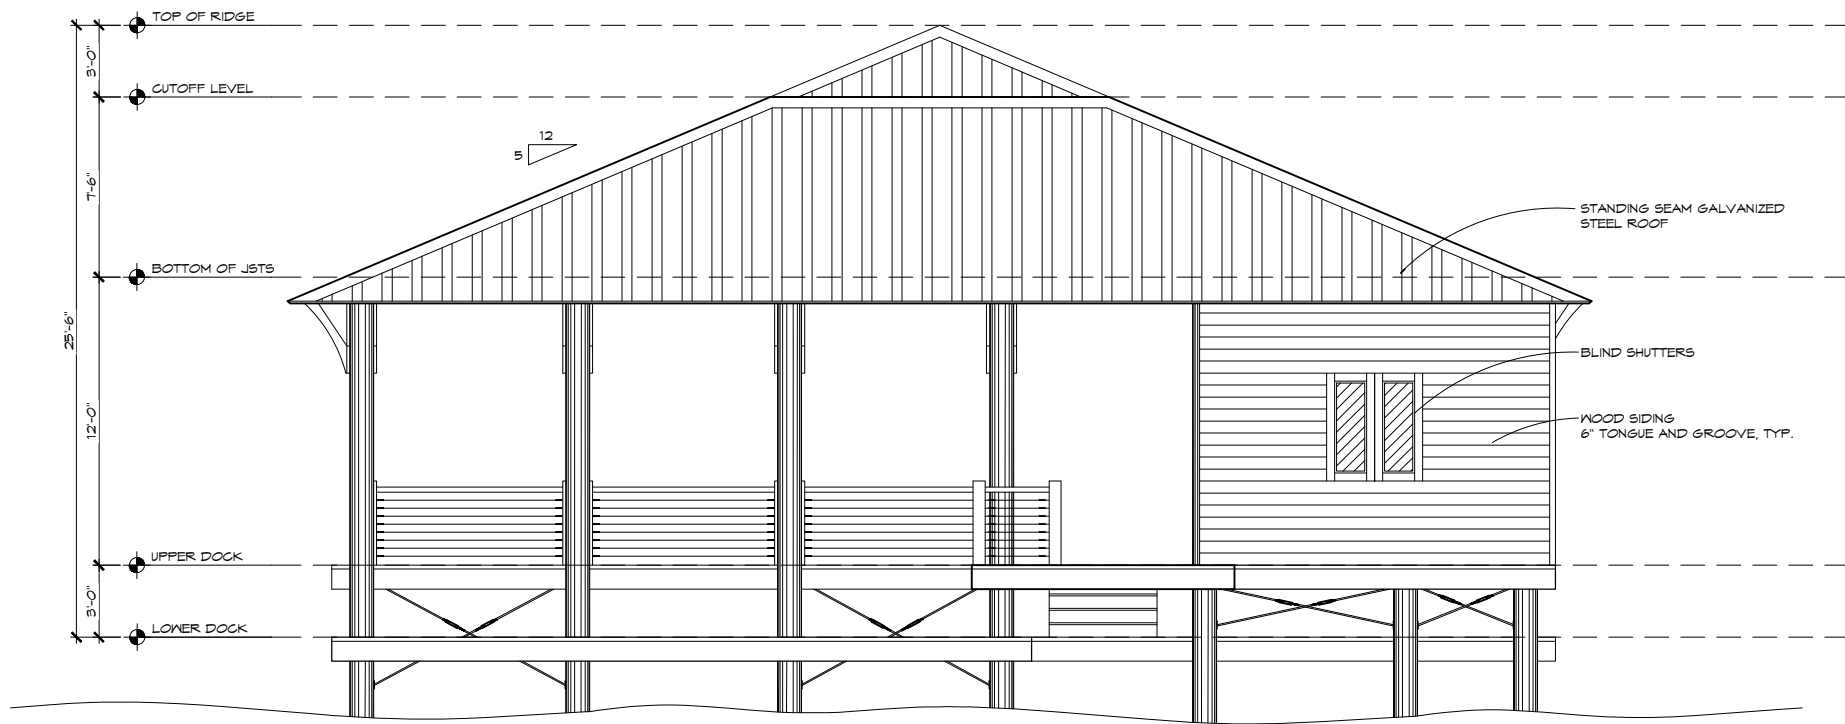

3 EAST ELEVATION
 SCALE: 1/8" = 1'-0"



2 SOUTH ELEVATION
 SCALE: 1/8" = 1'-0"

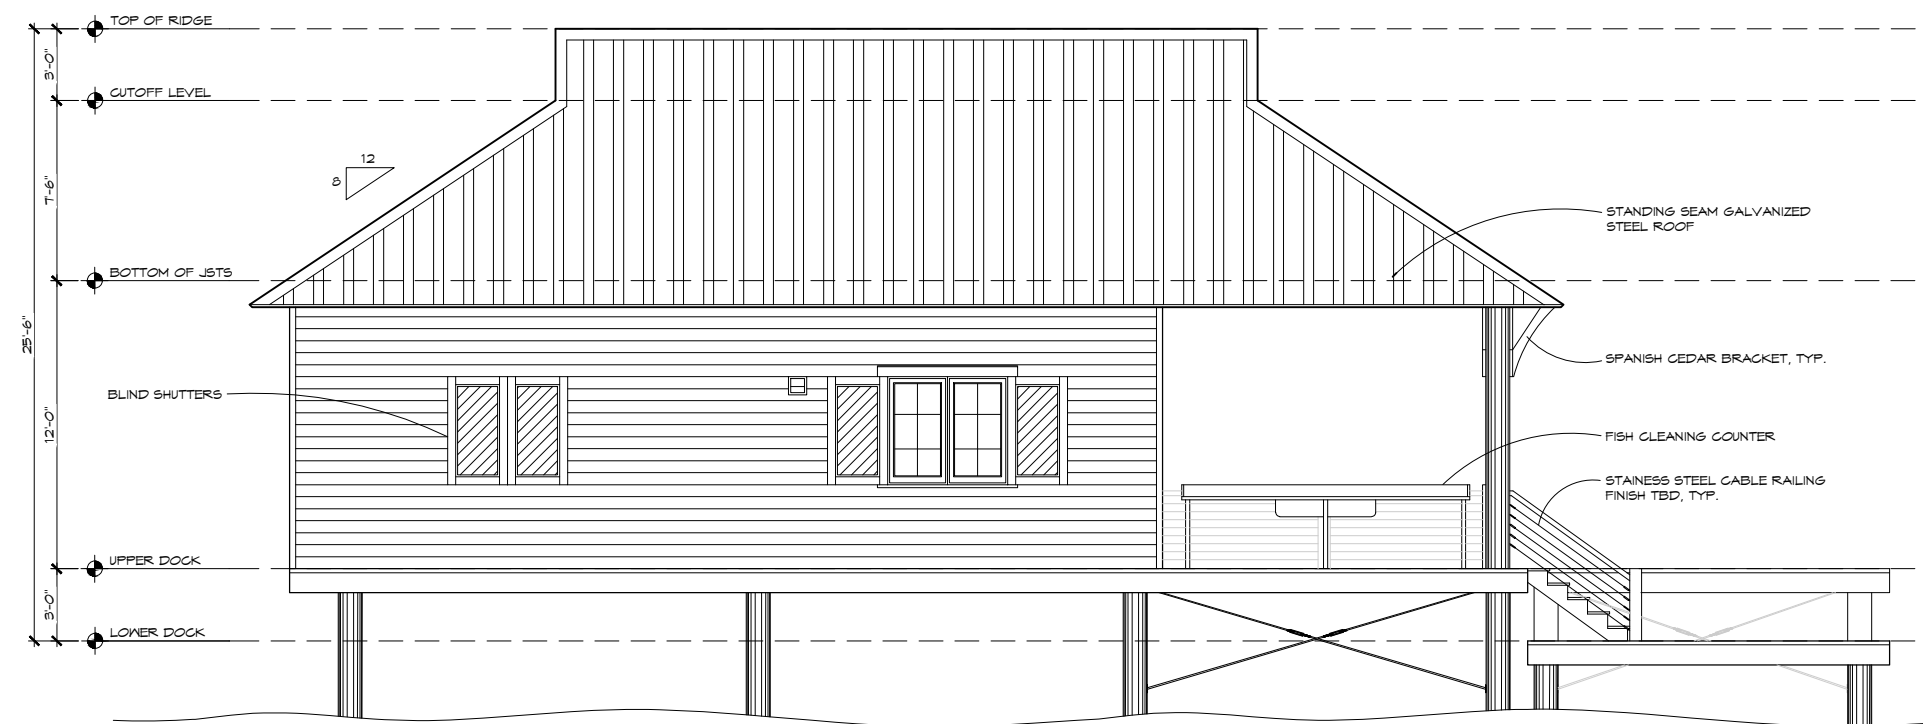

1 WEST ELEVATION
 SCALE: 1/8" = 1'-0"

Issues and Revisions

No.	Date	Issues
01	21.12.17	

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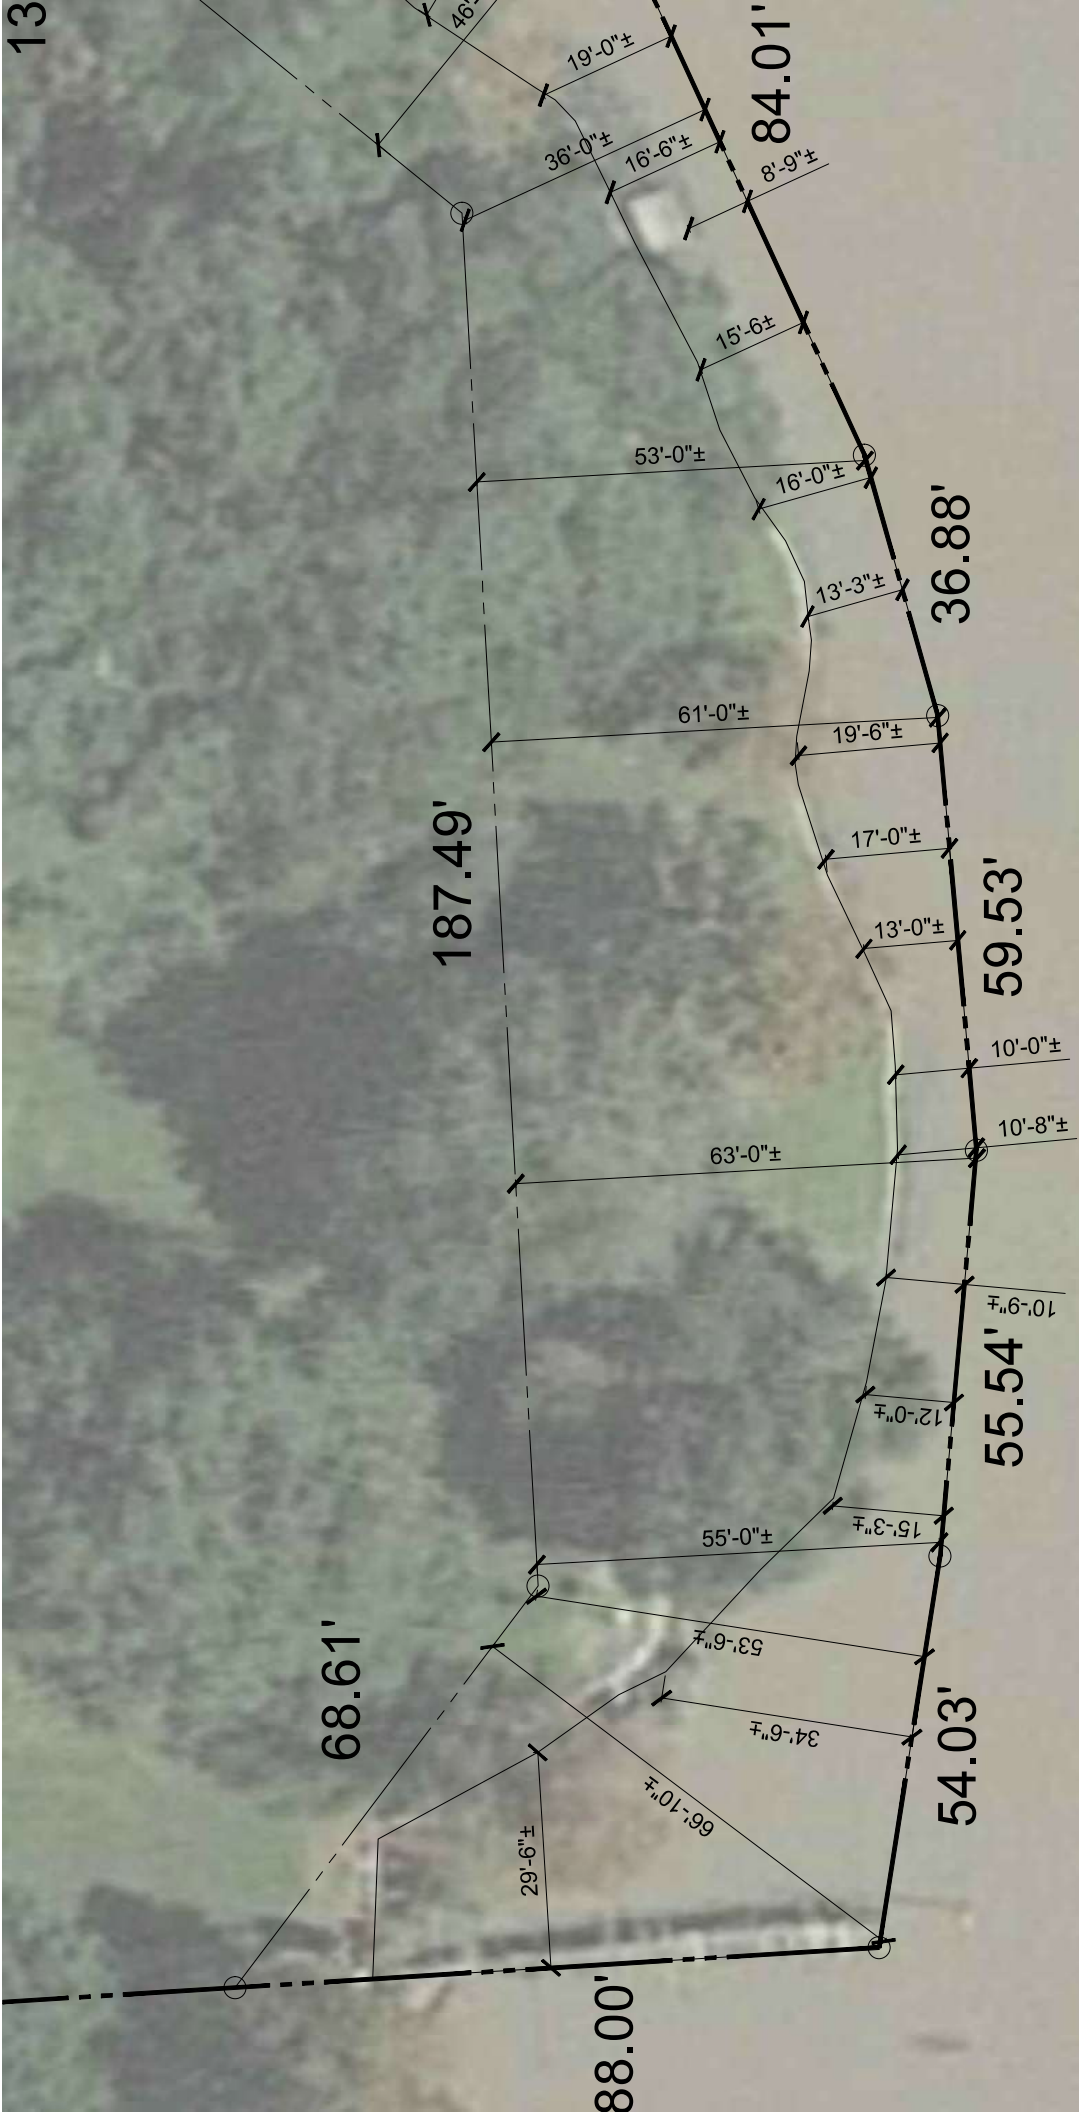
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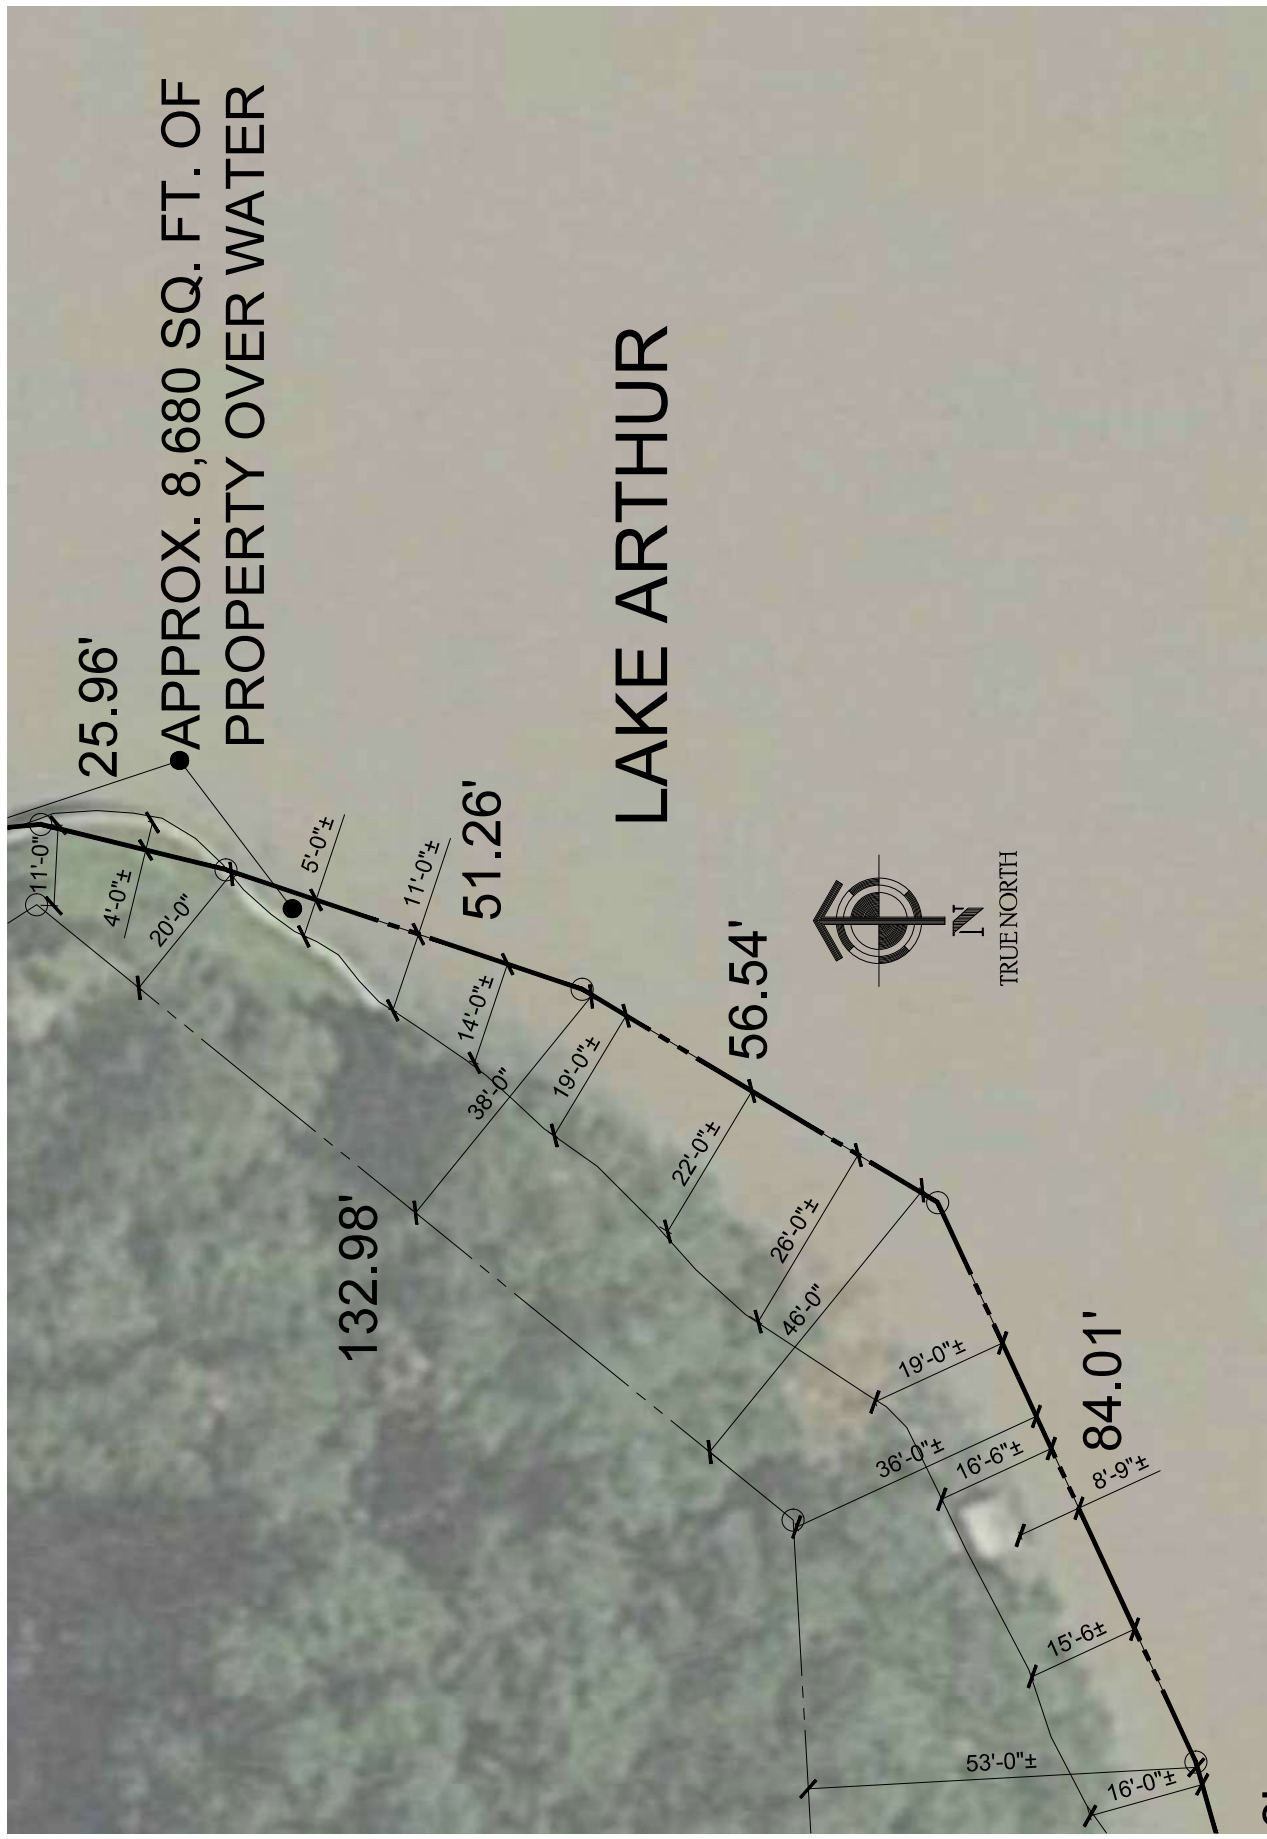
Drawing Name:

ELEVATIONS

Drawn By:

Checked By:





25.96'

● APPROX. 8,680 SQ. FT. OF
PROPERTY OVER WATER

LAKE ARTHUR





132.98'

51.26'

56.54'

84.01'

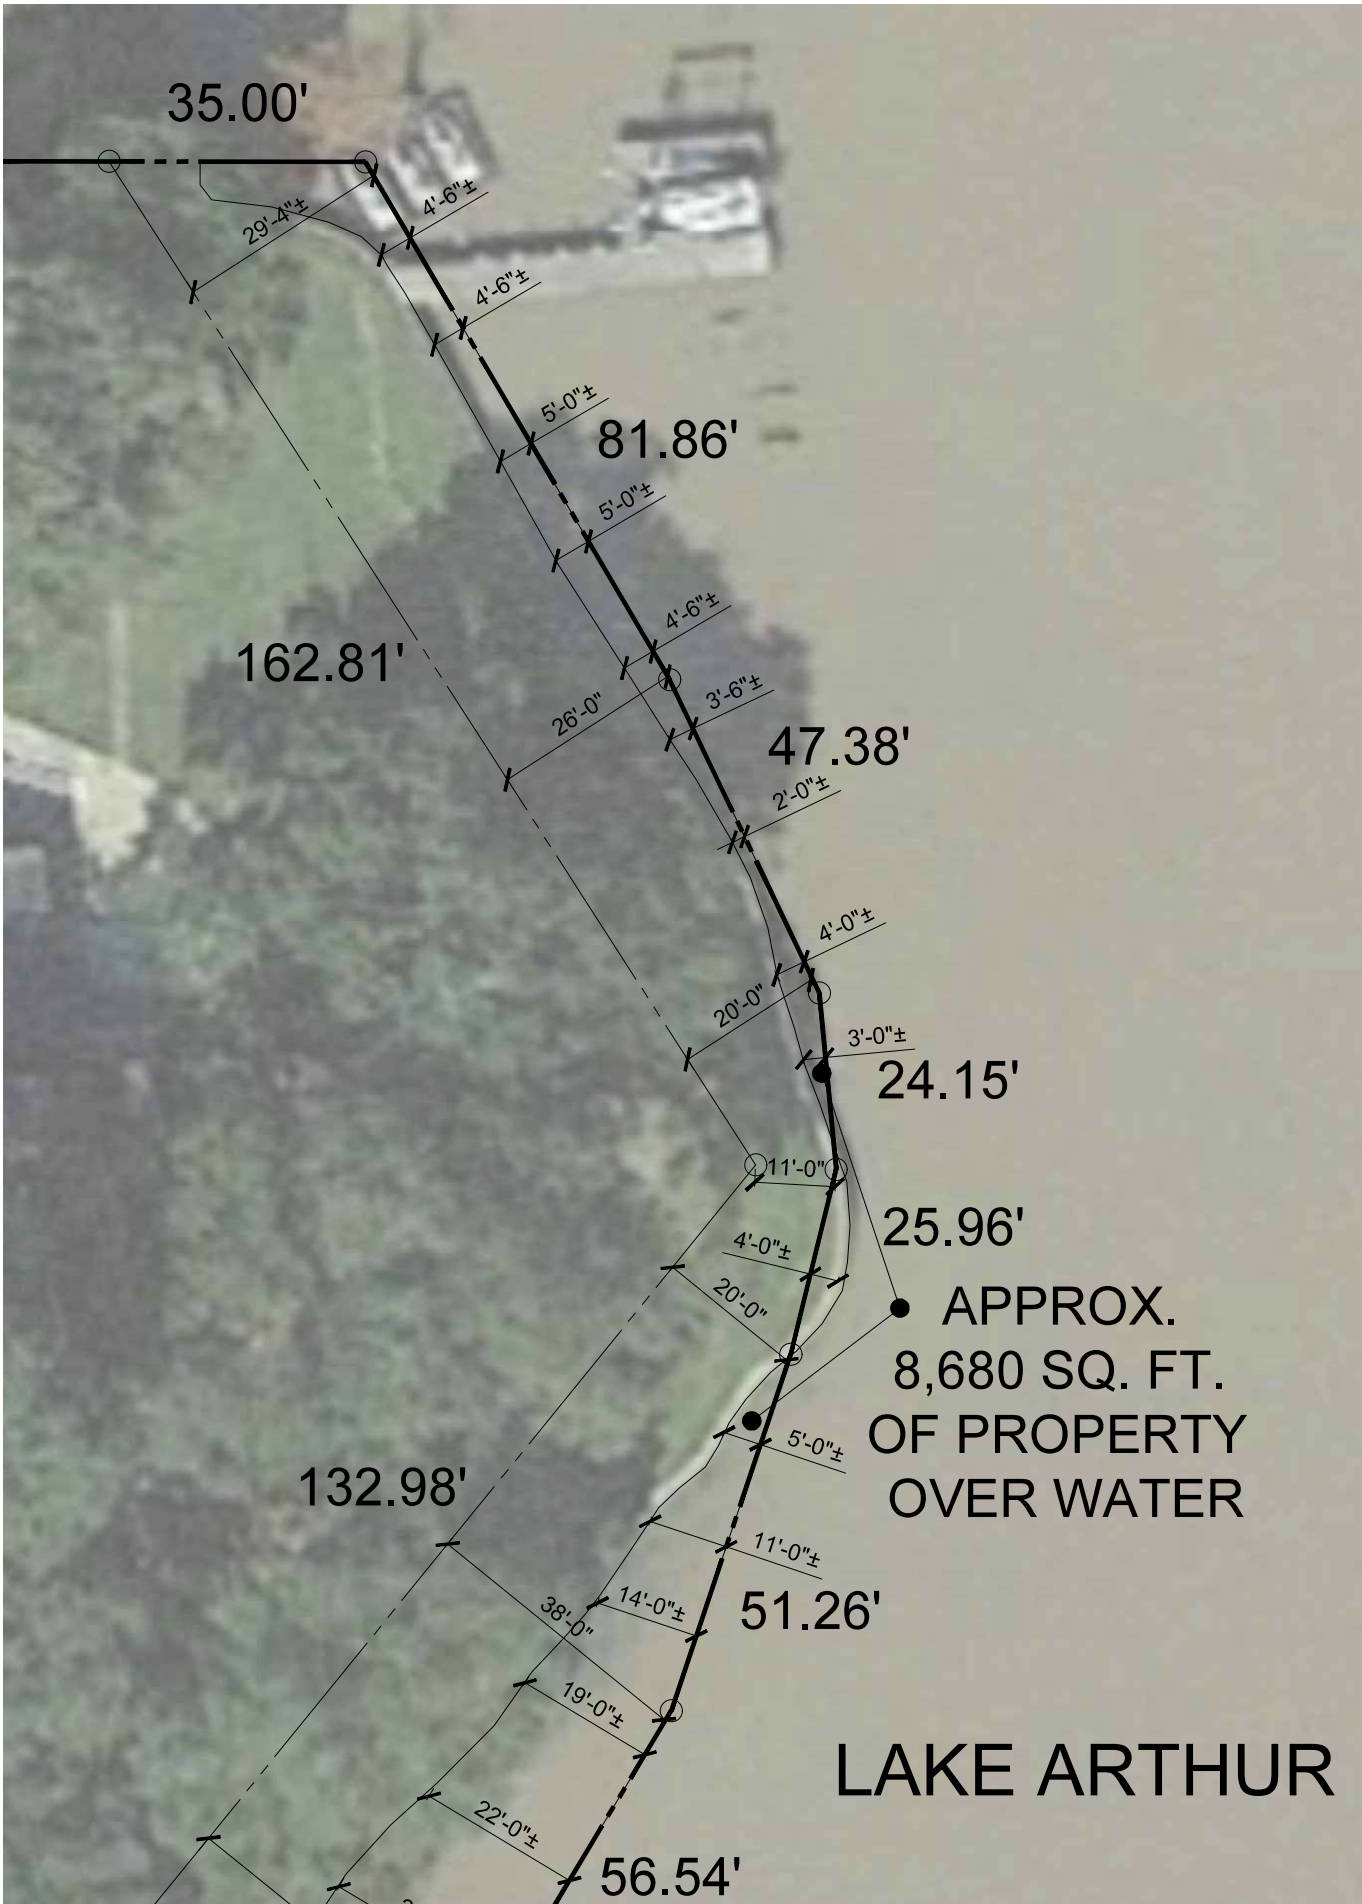

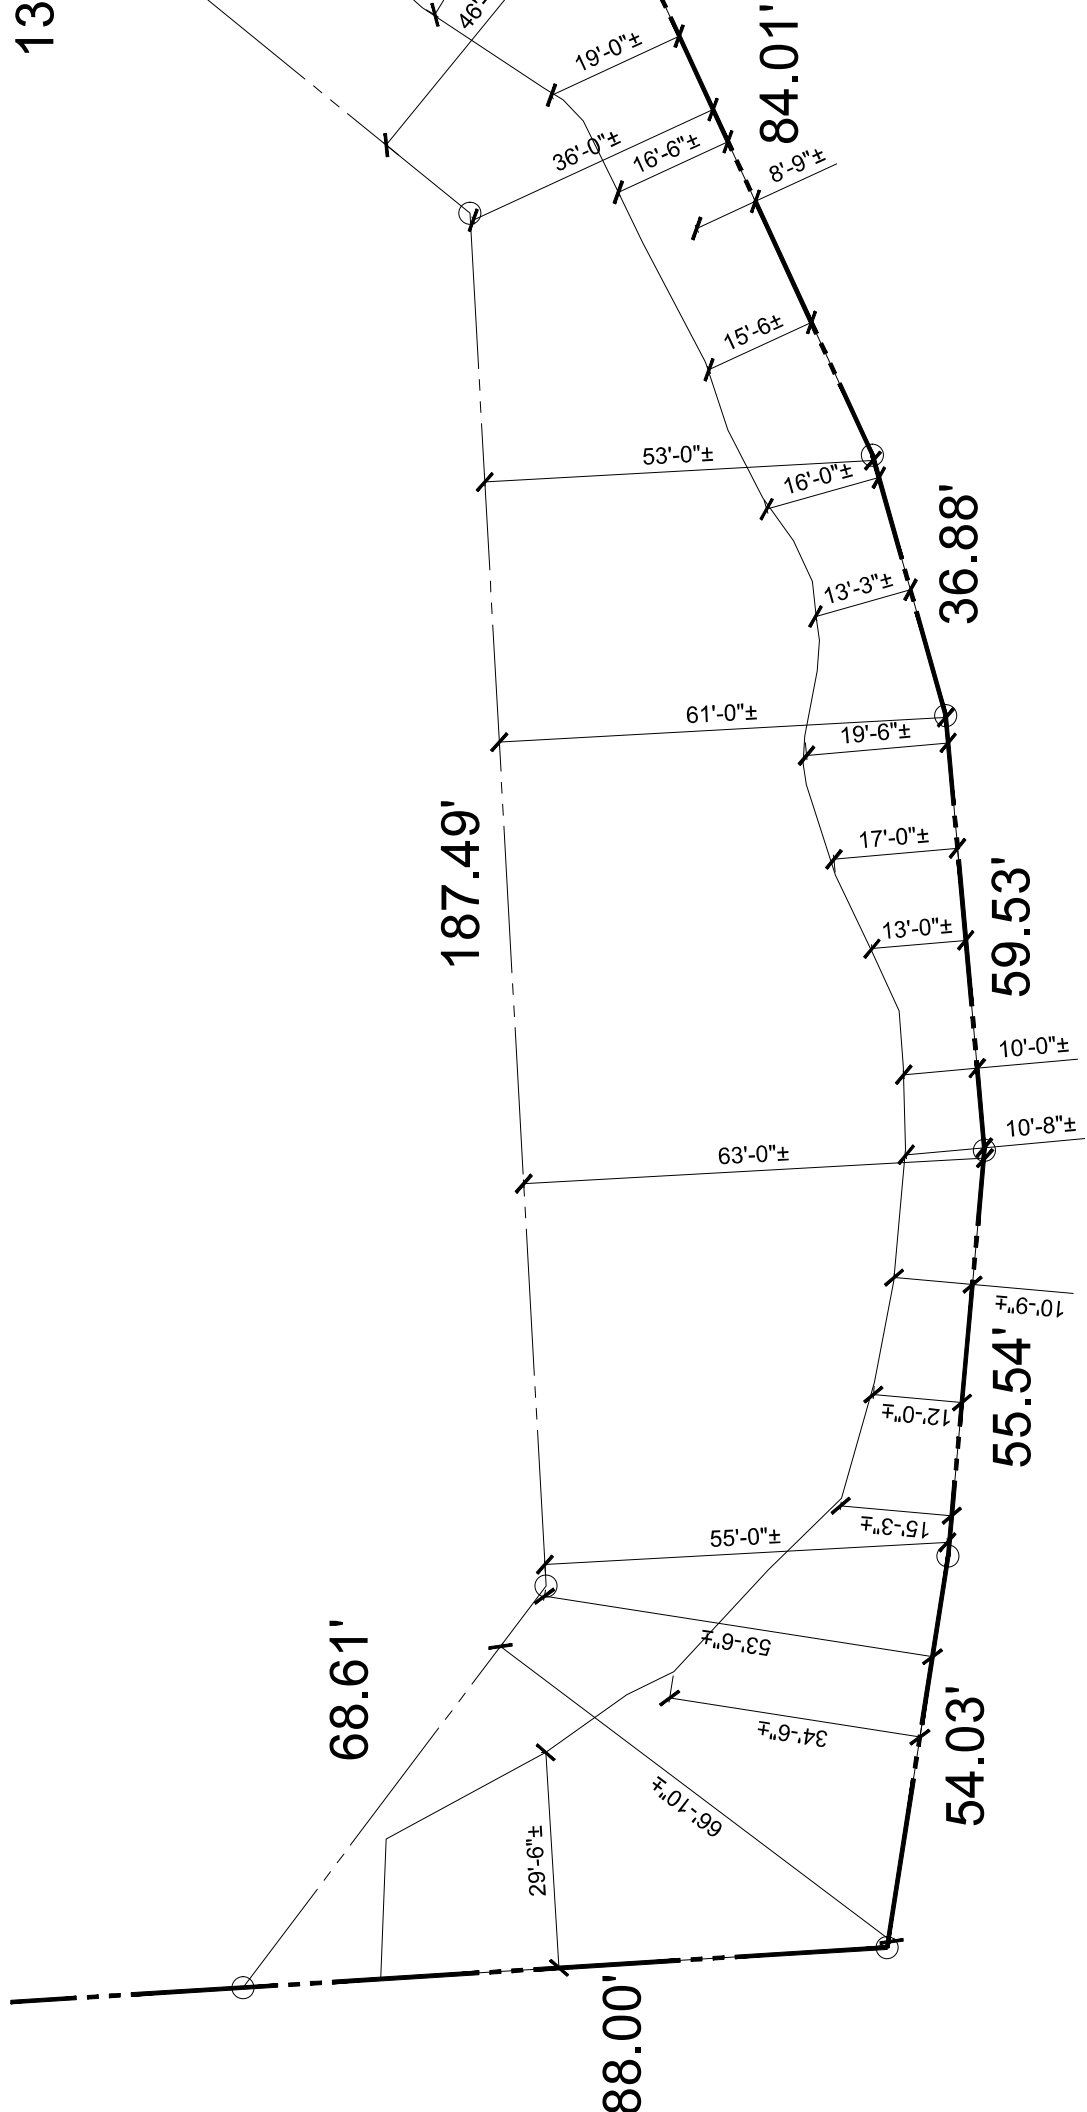

LAKE ARTHUR

25.96' ● APPROX.
8,680 SQ. FT.
OF PROPERTY
OVER WATER

