

JOINT PUBLIC NOTICE

8 February 2021

United States Army
Corps of Engineers
New Orleans District
Regulatory Branch (ODR-E)
7400 Leake Avenue
New Orleans, Louisiana 70118

State of Louisiana
Department of Environmental Quality
ATTN: Water Quality Certifications
Post Office Box 4313
Baton Rouge, Louisiana 70821-4313

(504) 862-2041
benjamin.c.sherman@usace.army.mil
Project Manager
Benjamin Sherman
Permit Application Number
MVN-2020-01251-ES

(225) 219-3225
Project Manager
Elizabeth Hill
WQC Application Number
WQC 210128-01

Interested parties are hereby notified that a permit application has been received by the New Orleans District of the U.S. Army Corps of Engineers pursuant to: [X] Section 10 of the Rivers and Harbors Act of March 3, 1899 (30 Stat. 1151; 33 USC 403); and/or [X] Section 404 of the Clean Water Act (86 Stat. 816; 33 USC 1344).

Application has also been made to the Louisiana Department of Environmental Quality, Water Quality Certifications, for a Water Quality Certification (WQC) in accordance with statutory authority contained in LRS30:2047 A(3), and provisions of Section 401 of the Clean Water Act (P.L.95-17).

BANKLINE PROTECTION AND MAINTENANCE DREDGING ON THE MISSISSIPPI RIVER IN JEFFERSON PARISH

NAME OF APPLICANT: ADM, c/o Lanier & Associates Engineers, Attention: John Maurin, 4101 Magazine St., New Orleans, LA 70115

LOCATION OF WORK: On the Mississippi River at MP 111, at approximately Latitude: 29.946667, Longitude: -90.226944, at 8400 River Rd., in Waggaman, Louisiana, in Jefferson Parish, as shown on the enclosed drawings.
Hydrologic Unit Code: 08090100 (Lower Mississippi- New Orleans)

CHARACTER OF WORK: Perform maintenance dredging of silted-in berth area to approximately -18 feet NAVD, install approximately 550-cubic yards of rock rip rap, and install an approximate 54-

linear foot retaining wall to restore an area of eroded bankline. Approximately 55,000-cubic yards of material would be excavated from the existing berth area and approximately 430-cubic yards would be placed behind the retaining wall as backfill. The remainder of the dredged material would be placed beyond the -55 foot contour of the Mississippi River. No impacts to jurisdictional wetlands are expected, therefore, compensatory mitigation is not proposed.

The comment period for the Department of the Army Permit and the Louisiana Department of Environmental Quality WQC will close **30 days** from the date of this joint public notice. Written comments, including suggestions for modifications or objections to the proposed work, stating reasons thereof, are being solicited from anyone having interest in this permit and/or this WQC request and must be mailed so as to be received before or by the last day of the comment period. Letters concerning the Corps of Engineers permit application must reference the applicant's name and the Permit Application Number, and be mailed to the Corps of Engineers at the address above, **ATTENTION: REGULATORY BRANCH**. **Similar letters concerning the Water Quality Certification must reference the applicant's name and the WQC Application number and be mailed to the Louisiana Department of Environmental Quality at the address above.**

The application for this proposed project is on file with the Louisiana Department of Environmental Quality and may be examined during weekdays between 8:00 a.m. and 4:30 p.m. Copies may be obtained upon payment of costs of reproduction.

Corps of Engineers Permit Criteria

The decision whether to issue a permit will be based on an evaluation of the probable impacts, including cumulative impacts of the proposed activity on the public interest. That decision will reflect the national concern for both protection and utilization of important resources. The benefit which reasonably may be expected to accrue from the proposal must be balanced against its reasonably foreseeable detriments. All factors which may be relevant to the proposal will be considered including the cumulative effects thereof; among those are conservation, economics, aesthetics, general environmental concerns, wetlands, historic properties, fish and wildlife values, flood hazards, floodplain values, land use, navigation, shoreline erosion and accretion, recreation, water supply and conservation, water quality, energy needs, safety, food and fiber production, mineral needs, considerations of property ownership and, in general, the needs and welfare of the people.

The U.S. Army Corps of Engineers is soliciting comments from the public, federal, state, and local agencies and officials, Indian Tribes, and other interested parties in order to consider and evaluate the impacts of this proposed activity. Any comments received will be considered by the U.S. Army Corps of Engineers to determine whether to make, modify, condition, or deny a permit for this proposal. To make this decision, comments are used to assess impacts on endangered species, historic properties, water quality, general environmental effects, and other public interest factors listed

above. Comments are used in the preparation of an Environmental Assessment and/or an Environmental Impact Statement pursuant to the National Environmental Policy Act. Comments are also used to determine the need for a public hearing and to determine the overall public interest of the proposed activity.

The New Orleans District is unaware of properties listed on the National Register of Historic Places near the proposed work. The possibility exists that the proposed work may damage or destroy presently unknown archeological, scientific, prehistorical, historical sites, or data. Issuance of this public notice solicits input from the State Archeologist and State Historic Preservation Officer regarding potential impacts to cultural resources.

The New Orleans District has determined that the project footprint is located in an area that may be known to be utilized by the West Indian Manatee and the Pallid Sturgeon. It has been determined that the activity is not likely to adversely affect the West Indian Manatee or the Pallid Sturgeon based on the Information & Planning Consultation for Endangered Species in Louisiana (IPaC), dated January 27, 2020 between the U.S. Army Corps of Engineers, New Orleans and U.S. Fish and Wildlife Service, Ecological Services Office. Standard Manatee Conditions for In-Water Activities will be included in the authorization, if granted.

Our initial finding is that the proposed work is Not Likely to Adversely Affect any species listed as endangered by the U.S. Departments of Commerce, nor affect any habitat designated as critical to the survival and recovery of such species.

This notice initiates the Essential Fish Habitat (EFH) consultation requirements of the Magnuson-Stevens Fishery Conservation and Management Act. The applicant's proposal may result in the destruction or alteration of approximately 7.97-acres of EFH utilized by various life stages of red drum and penaeid shrimp. Our initial determination is that the proposed action would have no adverse impact on EFH or federally managed fisheries in the Gulf of Mexico. Our final determination relative to project impacts and the need for mitigation measures is subject to review by and coordination with the National Marine Fisheries Service.

If the proposed work involves deposits of dredged or fill material into navigable waters, the evaluation of the probable impacts will include the application of guidelines established by the Administrator of the Environmental Protection Agency. Also, a certification that the proposed activity will not violate applicable water quality standards will be required from the Department of Environmental Quality, Water Quality Certifications, before a permit is issued.


Any person may request, in writing, within the comment period specified in this notice, that a public hearing be held to consider this application. Requests for public hearings shall state, with particularity, the reasons for holding a public hearing.

The applicant has certified that the proposed activity described in the application complies with and will be conducted in a manner that is consistent with the Louisiana Coastal Resources Program. The Department of the Army permit will not be issued unless the applicant received approval or a waiver of the Coastal Use Permit by the Department of Natural Resources.


You are requested to communicate the information contained in this notice to any other parties whom you deem likely to have interest in the matter.

Michael V. Farabee
Chief, Eastern Evaluation Section

Enclosure

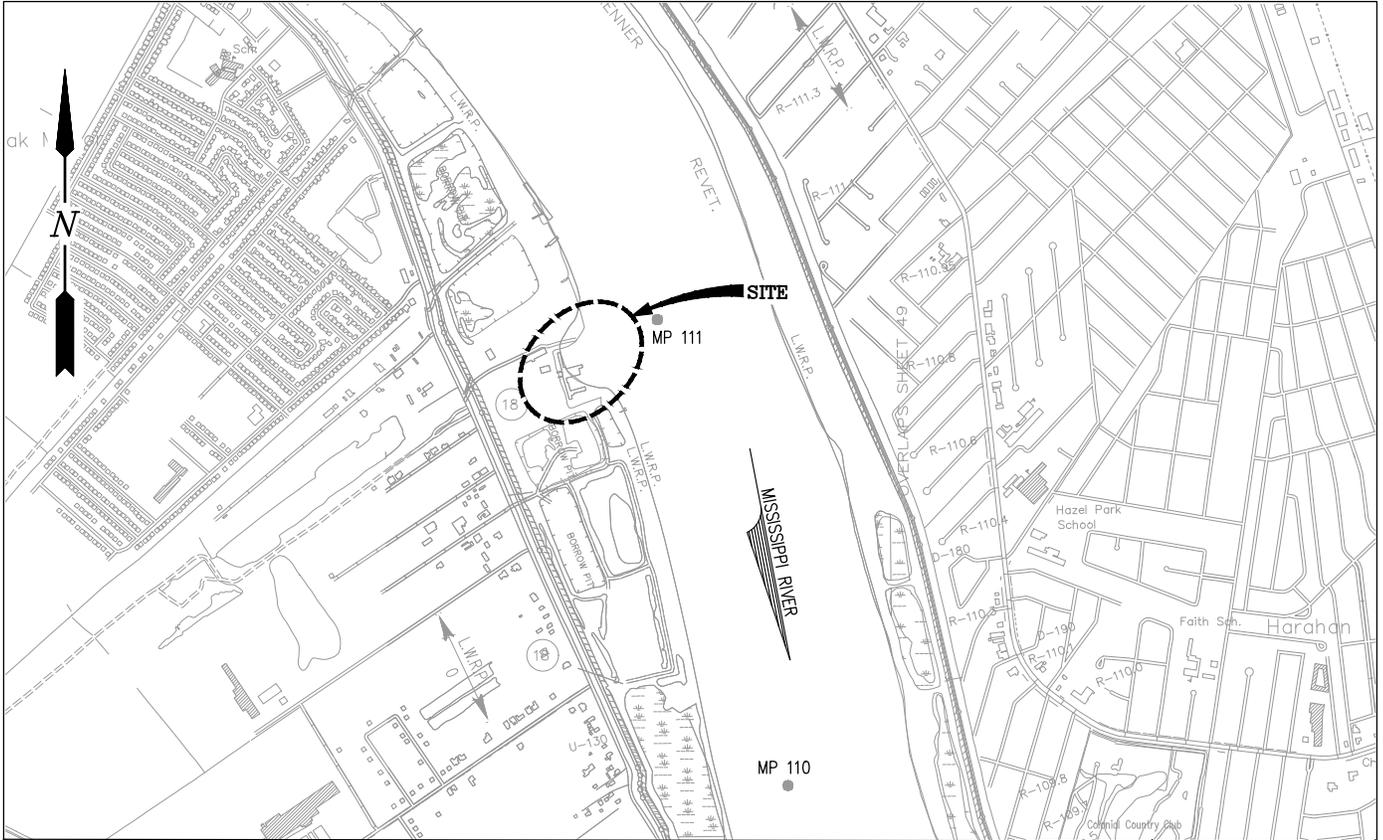

VICINITY MAP

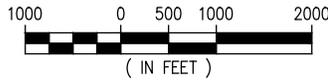

JEFFERSON PARISH
 LATITUDE: 29° 56' 48"
 LONGITUDE: 90° 13' 37"

GENERAL NOTES

1. AS-BUILT DRAWINGS AND/OR PLANS SHALL HAVE WRITTEN ON THEM THE DATE OF COMPLETION OF SAID ACTIVITIES AND SHALL BE SUBMITTED TO THE LOUISIANA DEPARTMENT OF NATURAL RESOURCES, OFFICE OF COASTAL MANAGEMENT, P.O. BOX 44487, BATON ROUGE, LA 70804-4487 WITHIN 30 DAYS FOLLOWING PROJECT COMPLETION.
2. ALL STRUCTURES, FACILITIES, WELL AND PIPELINES/FLOWLINES OCCURRING IN OPEN WATER AREAS OR IN OILFIELD CANALS OR SLIPS SHALL BE REMOVED WITHIN 120 DAYS OF ABANDONMENT OF THE FACILITIES FOR THE HEREIN PERMITTED USE UNLESS PRIOR WRITTEN APPROVAL TO LEAVE SUCH STRUCTURES IN PLACE IS RECEIVED FROM THE COASTAL MANAGEMENT DIVISION. THIS CONDITION DOES NOT PRECLUDE THE NECESSITY FOR REVISING THE CURRENT PERMIT OR OBTAINING A SEPARATE COASTAL USE PERMIT, SHOULD ONE BE REQUIRED.
3. STRUCTURES MUST ALSO BE MARKED/LIGHTED IN ACCORDANCE WITH U.S. COAST GUARD REGULATIONS.
4. IN ORDER TO ENSURE THE SAFETY OF ALL PARTIES, THE PERMITEE SHALL CONTACT THE LOUISIANA ONE CALL SYSTEM (1-800-272-3020) A MINIMUM OF 48 HOURS PRIOR TO THE COMMENCEMENT OF ANY EXCAVATION (DIGGING, DREDGING, JETTING, ETC.) OR DEMOLITION ACTIVITY.
5. ALL ELEVATIONS REFER TO NAVD 88 UNLESS NOTED OTHERWISE.



JOSEPH E. JACQUAT
 LA PE #21953

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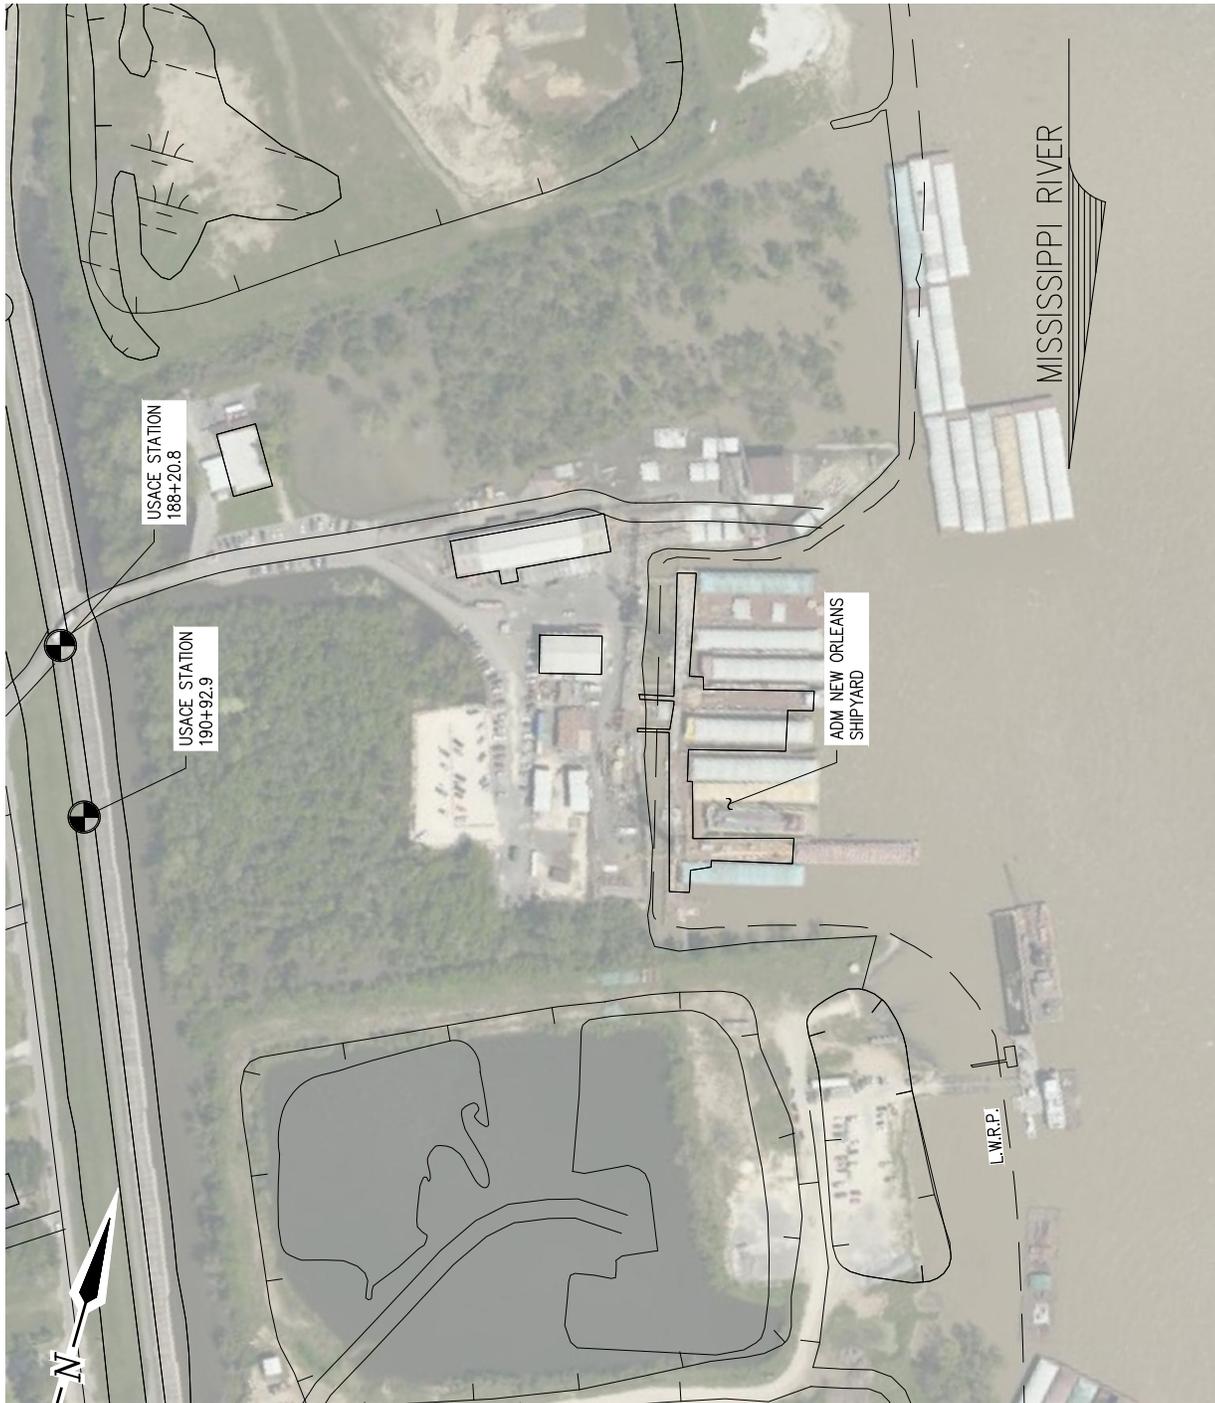


LANIER & ASSOCIATES
CONSULTING ENGINEERS
 INCORPORATED

LA: C-1120 TX: F-2981
 NEW ORLEANS, LA • BEAUMONT, TX

WAGGAMAN ADM LOUISIANA
SHIPYARD MAINTENANCE WORK & DREDGING
VICINITY MAP, AREA MAP
& GENERAL NOTES

DATE AUG '20
 DESIGN JEJ
 DRAWN CJJ
 CHECK JDM
 JOB NO 11498
 SHEET No.
1 OF 8



EXISTING SITE PLAN

SCALE: 1"=300'



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WAGGAMAN


ADM

LOUISIANA

**SHIPYARD MAINTENANCE WORK & DREDGING
EXISTING SITE PLAN**

DATE AUG '20
DESIGN JEJ
DRAWN CJJ
CHECK JDM
JOB NO 11498
SHEET No.


2 OF 8

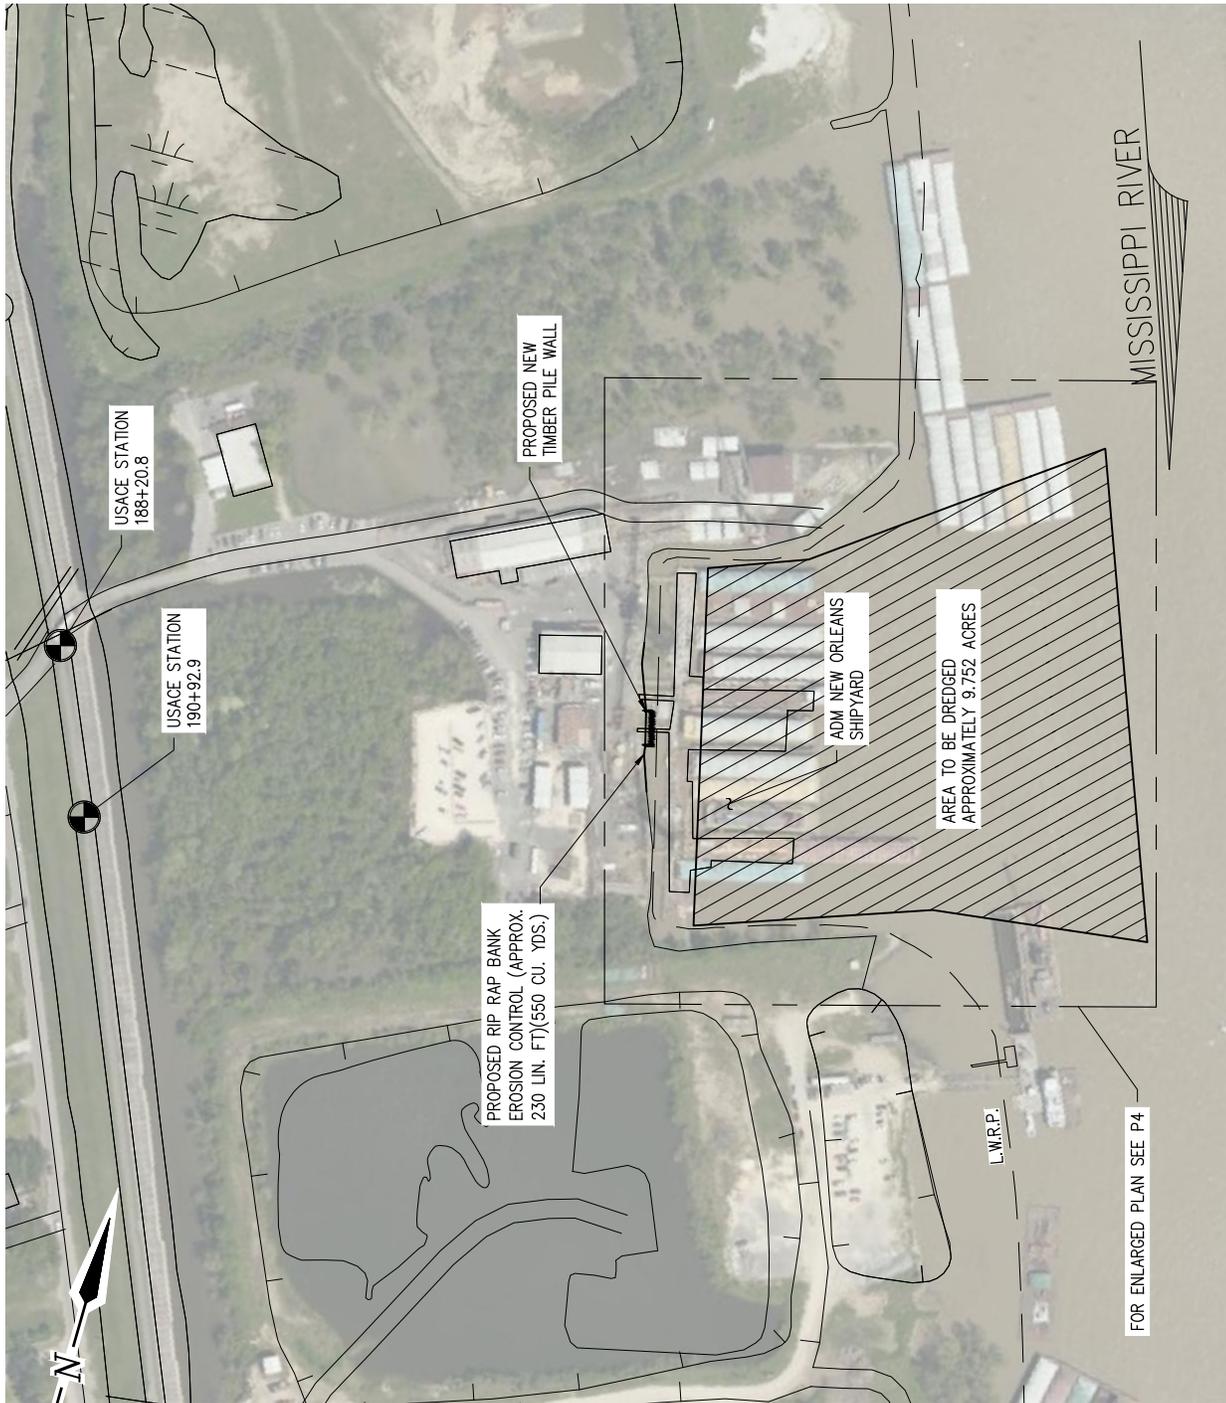

NOTE:
ALL PROPOSED WORK WILL BE PERFORMED FROM
A BARGE-MOUNTED CRANE.

PROPOSED NEW SITE PLAN

SCALE: 1"=300'

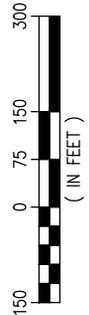

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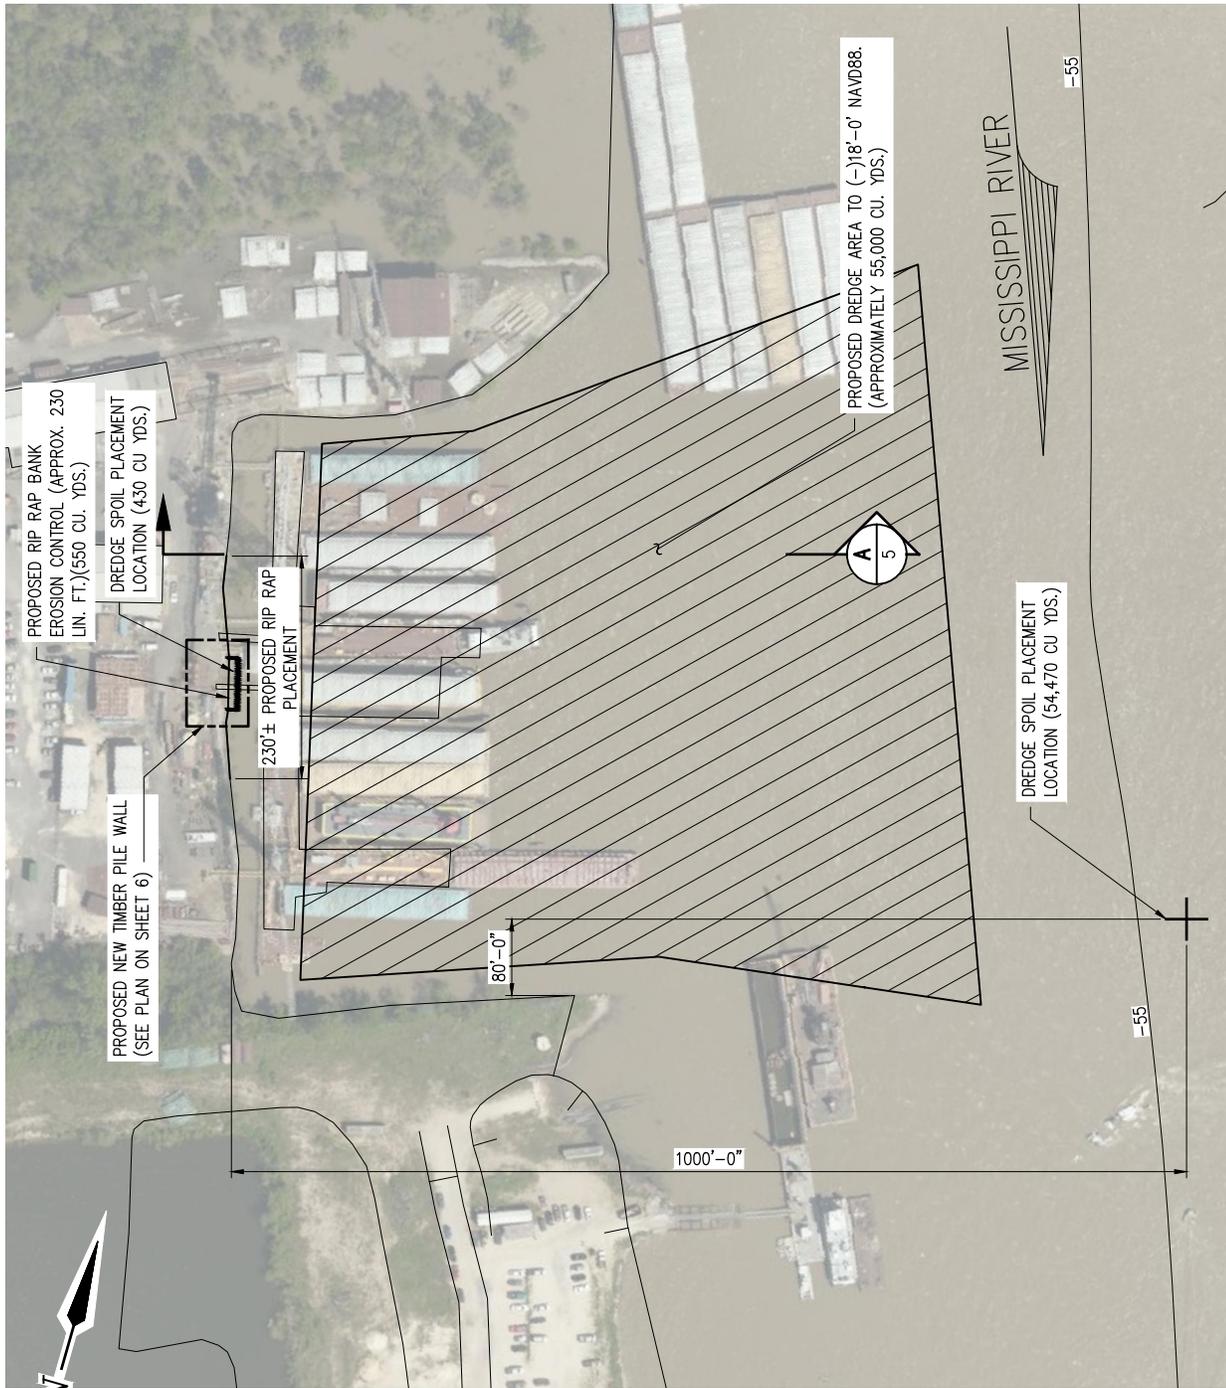
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WAGGAMAN ADM LOUISIANA


SHIPYARD MAINTENANCE WORK & DREDGING
PROPOSED NEW SITE PLAN

DATE AUG '20
DESIGN JEJ
DRAWN CJJ
CHECK JDM
JOB NO 11498
SHEET No.
3 OF 8



ENLARGED PROPOSED NEW SITE PLAN

SCALE: 1"=200'

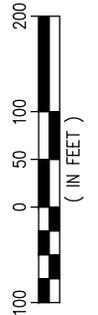

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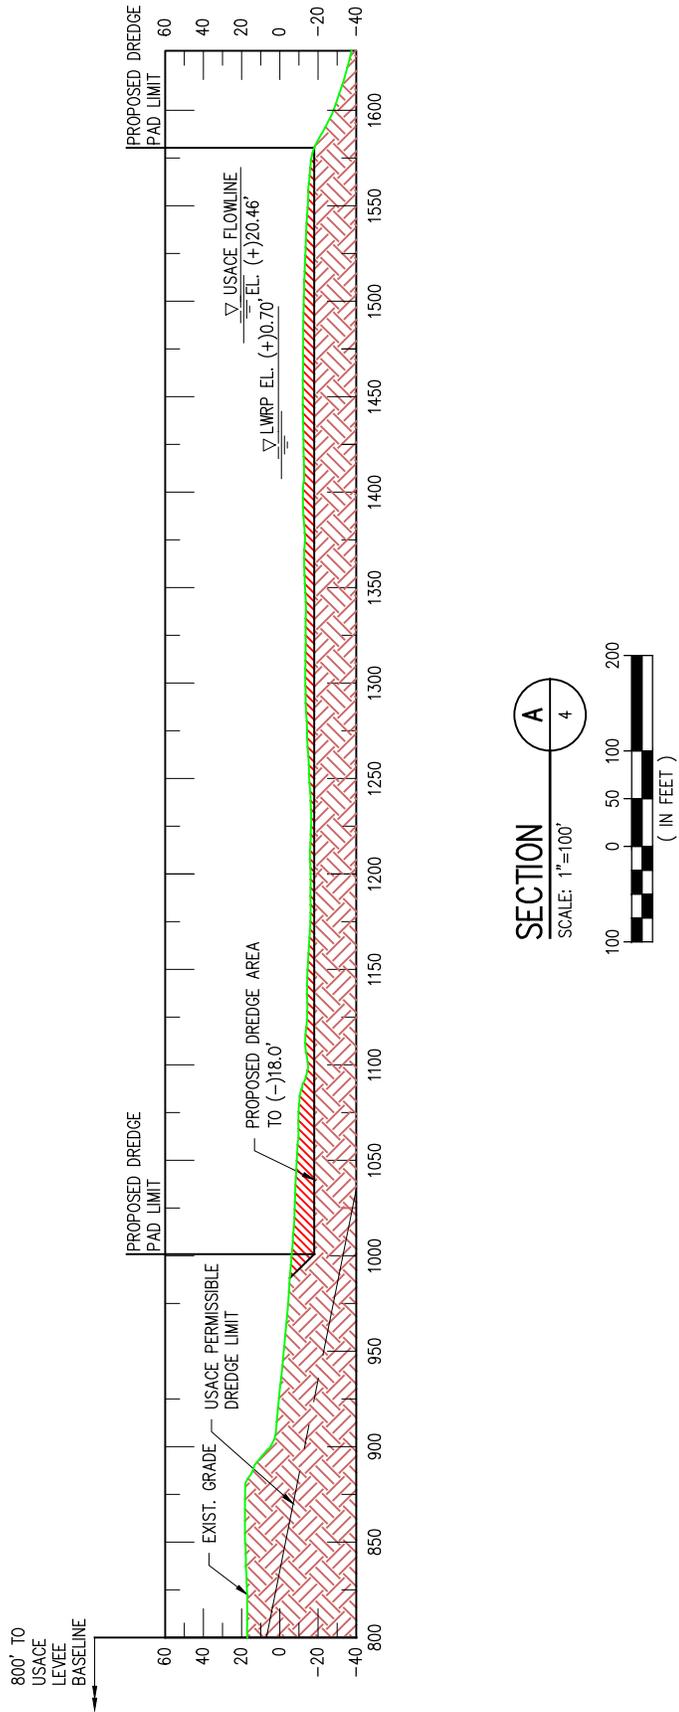
ADM

LOUISIANA

SHIPYARD MAINTENANCE WORK & DREDGING
ENLARGED PROPOSED NEW SITE PLAN

DATE AUG '20
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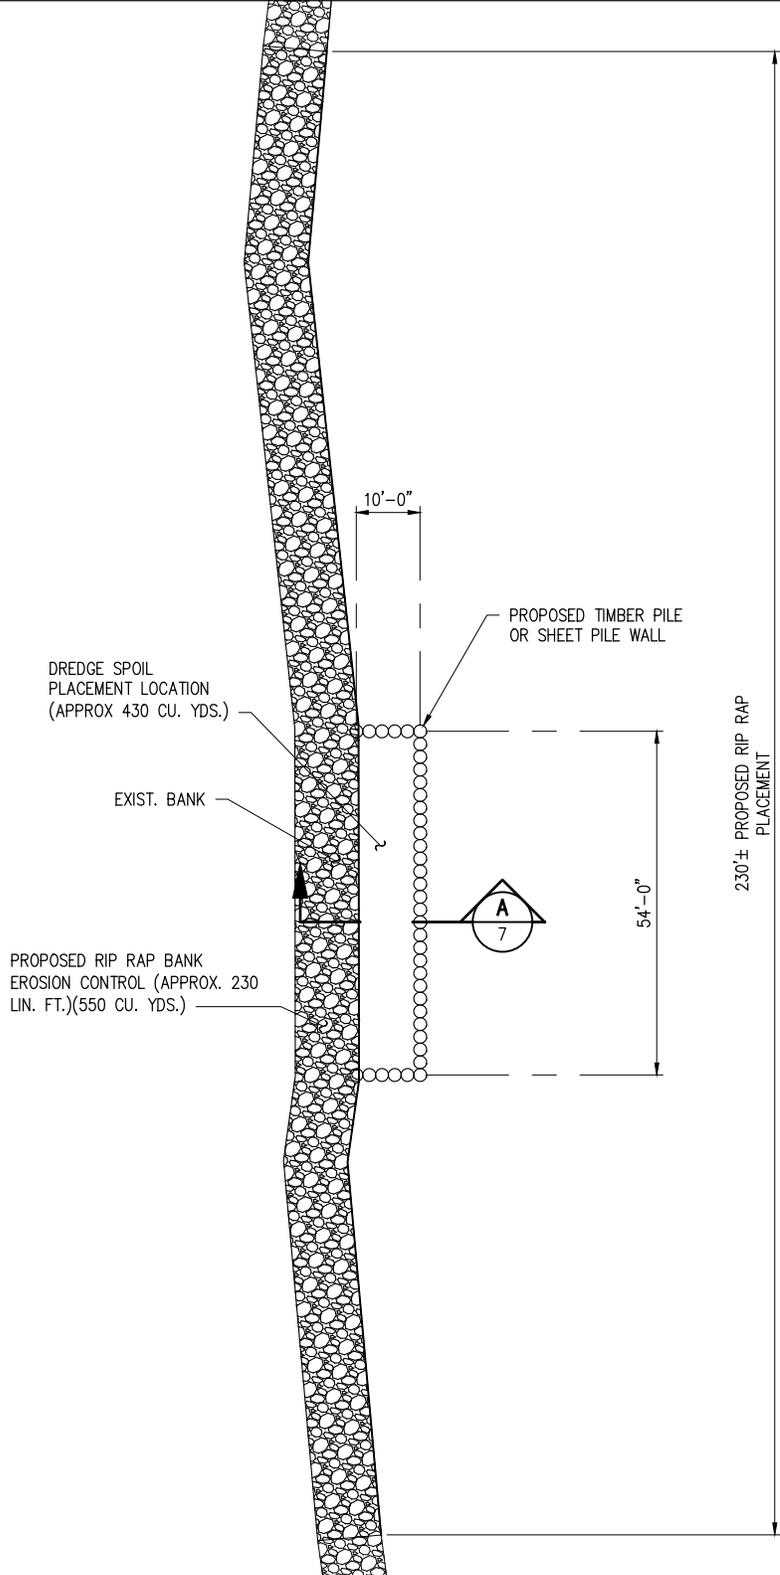
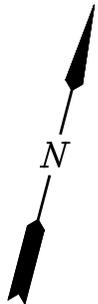
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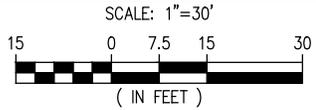
SHIPYARD MAINTENANCE WORK & DREDGING
PROPOSED DREDGING CROSS-SECTION

DATE AUG '20
DESIGN JEJ
DRAWN CJJ
CHECK JDM
JOB NO 11498
SHEET No.

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PROPOSED PILE WALL PLAN




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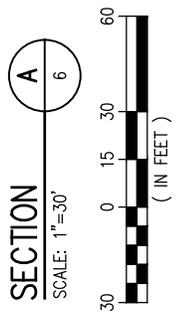
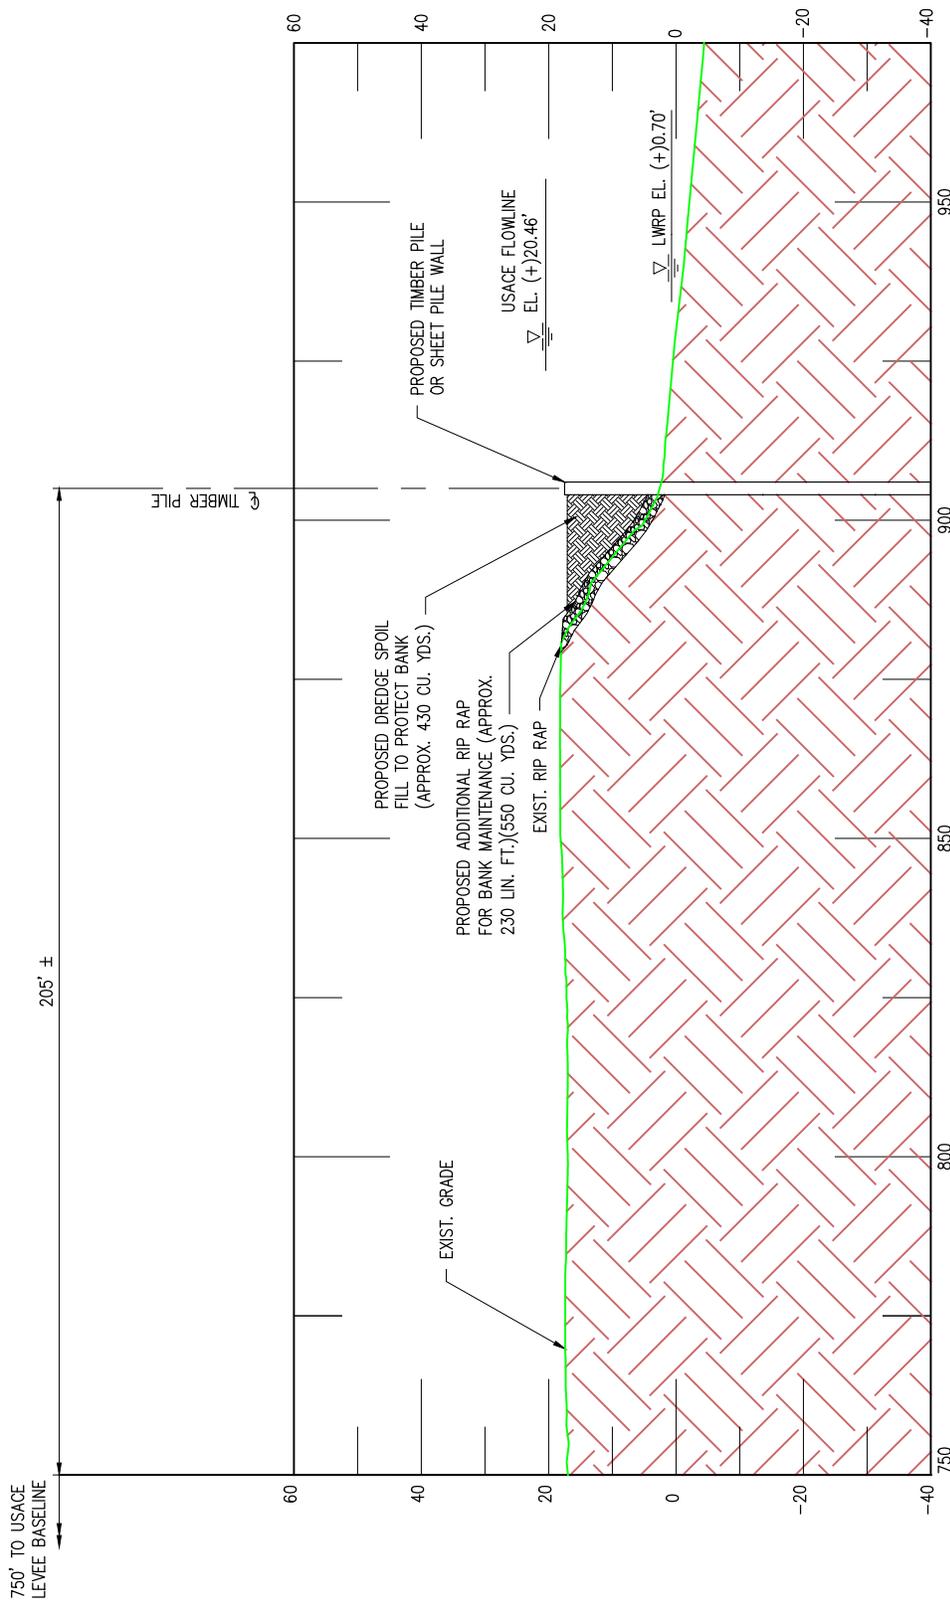
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SHIPYARD MAINTENANCE WORK & DREDGING
PROPOSED PILE WALL PLAN

DATE	AUG '20
DESIGN	JEJ
DRAWN	CJJ
CHECK	JDM
JOB NO.	11498
SHEET No.	6 OF 8



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SHIPYARD MAINTENANCE WORK & DREDGING
PROPOSED NEW WALL CROSS-SECTION

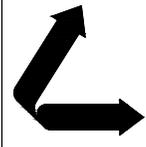DATE	AUG '20
DESIGN	JEJ
DRAWN	CJJ
CHECK	JDM
JOB NO.	11498
SHEET No.	7 OF 8

USACE PROJ. FLOWLINE
EL. (+)20.46'

T.O. PILE EL (+) 17.5'

LWRP 0.70'

MUDLINE EL (-) 6.0'

TIP EL (-) 50'.0

PROPOSED 24"Ø
TIMBER PILE OR
STEEL SHEET PILE

PILE DETAIL
SCALE: 3/16"=1'-0"

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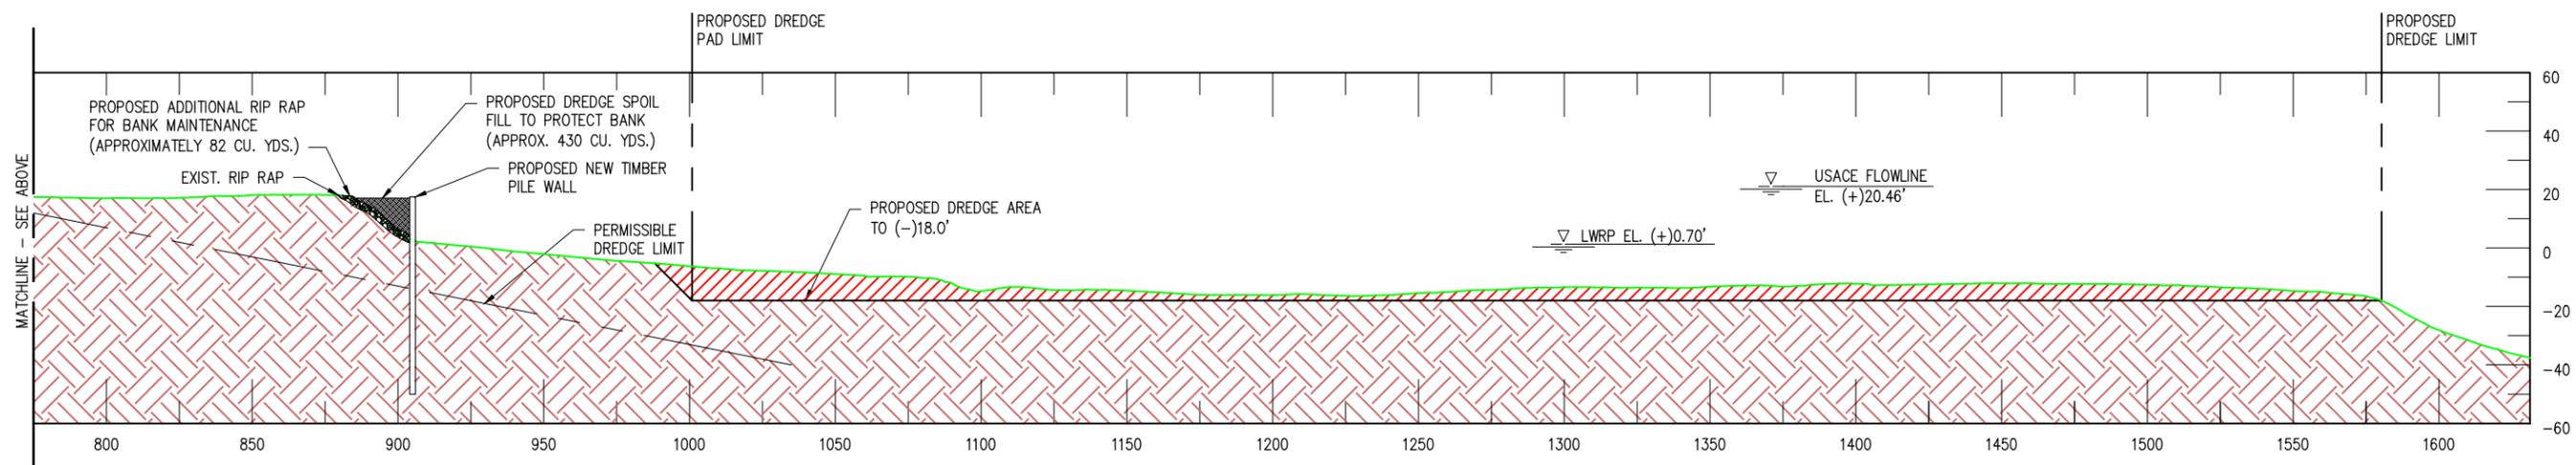
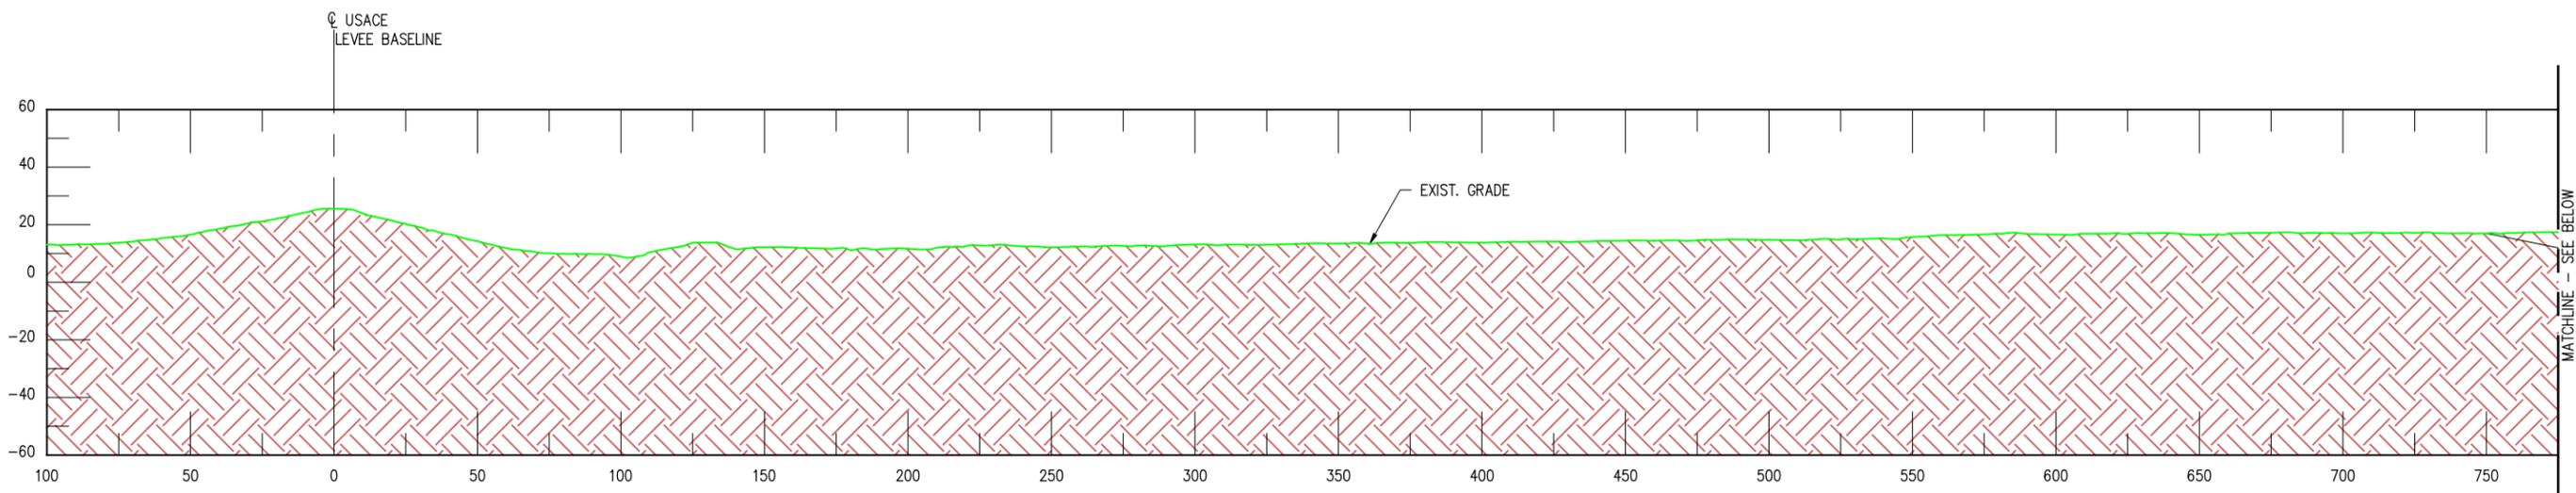
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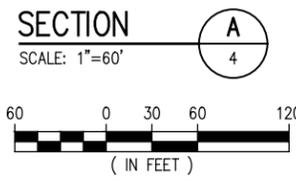
SHIPYARD MAINTENANCE WORK & DREDGING
PROPOSED NEW WALL PILE DETAIL

DATE AUG '20
DESIGN JEJ
DRAWN CJJ
CHECK JDM
JOB NO 11498
SHEET No.

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NOTE:
SURVEY DATA FROM 2016 USACE LIDAR AND 2013 USACE FULL RIVER SURVEY.



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REV	DATE	BY	DESCRIPTION	REV	DATE	BY	DESCRIPTION

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PRELIMINARY - FOR PERMIT PURPOSES ONLY

DATE AUG' 20
SHT SIZE 11"x17"
DESIGN JEJ
DRAWN CJJ
CHECK JDM
APPR'D NPL
JOB NO 11498

WAGGAMAN ADM LOUISIANA

**SHIPYARD MAINTENANCE WORK & DREDGING
PROPOSED DREDGING CROSS SECTIONS**

SHEET NO.
X1

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