### JOINT PUBLIC NOTICE

July 23, 2018

United States Army Corps of Engineers New Orleans District Regulatory Branch 7400 Leake Avenue New Orleans, Louisiana 70118

(504) 862-2675
Project Manager
Jamie Crowe
Jamie.M.Crowe@usace.army.mil
Permit Application Number
MVN 2015-01590 CO

State of Louisiana
Department of Environmental Quality
Water Permits Division
Post Office Box 4313
Baton Rouge, Louisiana 70821-4313

(225) 219-3225 Project Manager Elizabeth Hill

WQC Application Number WQC 170719-01

Interested parties are hereby notified that a permit application has been received by the New Orleans District of the U.S. Army Corps of Engineers pursuant to:
[X] Section 10 of the Rivers and Harbors Act of March 3, 1899 (30 Stat. 1151; 33 USC 403); and/or [X] Section 404 of the Clean Water Act (86 Stat. 816; 33 USC 1344).

Application has also been made to the Louisiana Department of Environmental Quality, Office of Environmental Services, for a Water Quality Certification (WQC) in accordance with statutory authority contained in LRS30:2047 A(3), and provisions of Section 401 of the Clean Water Act (P.L.95-17).

### LOCK AND FLOODWALL STRUCTURE IN THE HOUMA NAVIGATION CANAL IN LAFOURCHE PARISH

**NAME OF APPLICANT**: Terrebonne Levee and Conservation District; c/o APTIM, 2503 Petroleum Drive, Houma, Louisiana 70363.

**LOCATION OF WORK**: Within the Terrebonne Basin, in the West- Central Louisiana Coastal hydrologic unit (HUC 08090302), located in the Houma Navigation Canal (HNC), approximately 4 miles southwest of Dulac, Louisiana, in Lafourche Parish.

**CHARACTER OF WORK**: The applicant proposes to dredge an area, construct an aggregate road for access, and construct a lock structure that provides 110 of clear width and an 800 foot long lock chamber, floodgate with integral sluice gates, a closure wall that consists of a pile-supported T-wall floodwall to connect this project to existing adjacent levees, an operations area, maintenance building, boat ramp, boat shed, and other appurtenant facilities to maintain and operate the structures. The existing floodgate and floodwalls will be removed or incorporated into the proposed flood gate and lock complex. A total of 21.4 acres of brackish marsh will be impacted by construction of the lock structure. Approximately 1,383,000 cubic yards of material will

be dredged from the HNC and the proposed marina canal. All dredged material will be deposited beneficially in 245 acres of open water in the nearby area, as shown in the enclosed disposal plan. Approximately, 37,600 cubic yards of hauled-in dirt will be used for the levee tie-in and as backfill for utilities, while approximately 236,000 cubic yards of rip-rap and 2,400 cubic yards of concrete will be used for the levee tie-in and bank line stabilization/scour protection. Approximately 19,500 cubic yards of limestone and 6,000 cubic yards of asphalt will be used for the access road.

According to the applicant, the project footprint has been minimized to the maximum extent practicable. The alignment and design have been altered such that wetland impacts were reduced from 130 acres to 21.4 acres. Other alignments evaluated resulted in additional wetland impacts.

The comment period for the Department of the Army Permit and the Louisiana Department of Environmental Quality WQC will close 20 days from the date of this joint public notice. Written comments, including suggestions for modifications or objections to the proposed work, stating reasons thereof, are being solicited from anyone having interest in this permit and/or this WQC request and must be mailed, so as to be received before or by the last day of the comment period. Letters concerning the Corps of Engineers permit application must reference the applicant's name and the Permit Application Number, and be mailed to the Corps of Engineers at the address above, ATTENTION: REGULATORY BRANCH. The application for this proposed project is on file with the Louisiana Department of Environmental Quality and may be examined weekdays between 8:00 a.m. and 4:30 p.m. Copies may be obtained upon payment of costs of reproduction. Individuals or parties may request an extension of time in which to comment on the proposed work by writing or e-mailing the Corps of Engineers Project Manager listed above. Any request must be specific and substantively supportive of the requested extension, and received by this office prior to the end of the initial comment period. The Section Chief will review the request and the requestor will be promptly notified of the decision to grant or deny the request. If granted, the time extension will be continuous to the initial comment period and, inclusive of the initial comment period, will not exceed a total of 30 calendar days. Letters concerning the Water Quality Certification must reference the applicant's name and the WQC Application number and be mailed to the Louisiana Department of Environmental Quality at the address above.

#### **Corps of Engineers Permit Criteria**

The decision whether to issue a permit will be based on an evaluation of the probable impacts, including cumulative impacts of the proposed activity on the public interest. That decision will reflect the national concern for both protection and utilization of important resources. The benefit which reasonably may be expected to accrue from the proposal must be balanced against its reasonably foreseeable detriments. All factors which may be relevant to the proposal will be considered including the cumulative effects thereof; among those are conservation, economics, aesthetics, general environmental concerns, wetlands, historic properties, fish and wildlife values,

flood hazards, floodplain values, land use, navigation, shoreline erosion and accretion, recreation, water supply and conservation, water quality, energy needs, safety, food and fiber production, mineral needs, considerations of property ownership and, in general, the needs and welfare of the people.

The U.S. Army Corps of Engineers is soliciting comments from the public, federal, state, and local agencies and officials, Indian Tribes, and other interested parties in order to consider and evaluate the impacts of this proposed activity. Any comments received will be considered by the U.S. Army Corps of Engineers to determine whether to make, modify, condition, or deny a permit for this proposal. To make this decision, comments are used to assess impacts on endangered species, historic properties, water quality, general environmental effects, and other public interest factors listed above. Comments are used in the preparation of an Environmental Assessment and/or an Environmental Impact Statement pursuant to the National Environmental Policy Act. Comments are also used to determine the need for a public hearing and to determine the overall public interest of the proposed activity.

The New Orleans District is unaware of properties listed on the National Register of Historic Places near the proposed work. The possibility exists that the proposed work may damage or destroy presently unknown archeological, scientific, prehistorical, historical sites, or data. Copies of this notice are being sent to the State Archeologist and State Historic Preservation Officer.

Our initial finding is that the proposed work would not affect any species, nor affect any habitat designated as critical to the survival and recovery of such species, listed as endangered by the U.S. Department of Commerce.

The New Orleans District has determined that the proposed project is located in waters known to be utilized by the west Indian manatee (*Trichechus manatus*) and determined that the proposed activity is not likely to adversely affect the species, provided the *Standard Manatee Conditions for In-Water Activities* are included in any authorization from this office. This determination is based on the Standard Local Operating Procedure for Endangered Species of Louisiana (SLOPES), dated October 22, 2014, between the U.S. Army Corps of Engineers and U.S. Fish and Wildlife Service, Ecological Services Office.

This notice initiates the Essential Fish Habitat (EFH) consultation requirements of the Magnuson-Stevens Fishery Conservation and Management Act. The applicant's proposal would result in the destruction or alteration of **21.4 acres** of EFH utilized by various life stages of red drum and penaeid shrimp. Our initial determination is that the proposed action would not have a substantial adverse impact on EFH or federally managed fisheries in the Gulf of Mexico. Our final determination relative to project impacts and the need for mitigation measures is subject to review by and coordination with the National Marine Fisheries Service.

If the proposed work involves deposits of dredged or fill material into navigable

waters, the evaluation of the probable impacts will include the application of guidelines established by the Administrator of the Environmental Protection Agency. Also, a certification that the proposed activity will not violate applicable water quality standards will be required from the Department of Environmental Quality, Office of Environmental Services, before a permit is issued.


Any person may request, in writing, within the comment period specified in this notice, that a public hearing be held to consider this application. Requests for public hearings shall state, with particularity, the reasons for holding a public hearing. You are requested to communicate the information contained in this notice to any other parties whom you deem likely to have interest in the matter.

The applicant has certified that the proposed activity described in the application complies with and will be conducted in a manner that is consistent with the Louisiana Coastal Resources Program. The Department of the Army permit will not be issued unless the applicant received approval or a waiver of the Coastal Use Permit by the Department of Natural Resources.

You are requested to communicate the information contained in this notice to any other parties whom you deem likely to have interest in the matter.

John M. Herman Chief, Central Evaluation Section Regulatory Branch

Enclosure

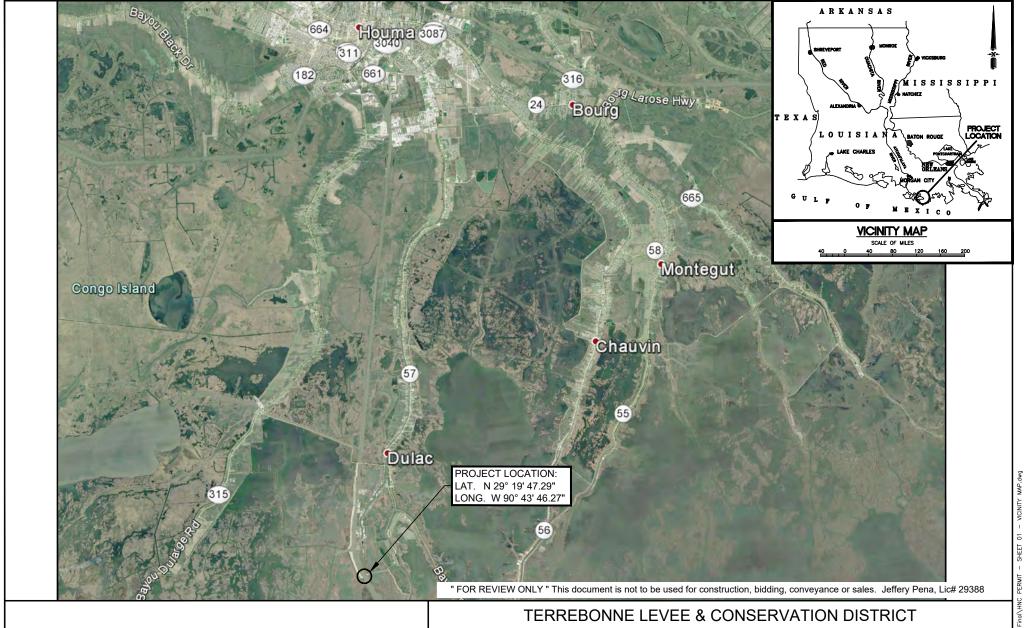

### VICINITY MAP

Date:	Drawn By:	Sheet No.:		Revisio	ns:	
luna 2017	DMC	04	Revision No.:	Date:	Notes:	
June 2017	PMC	01	1	08/01/2017	DNR Appl. Checklist Revs.	
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SHEET#	SHEET TITLE
25	UTILITIES POTABLE WATER AND SEWER SERVICE PLAN
26	UTILITIES POTABLE WATER PLAN VIEW
27	UTILITIES POTABLE WATER PLAN VIEW
28	UTILITIES POTABLE WATER PLAN VIEW
29	UTILITIES POTABLE WATER PLAN VIEW
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38	FLOODGATE JACKET CHANNEL SIDE ELEVATION
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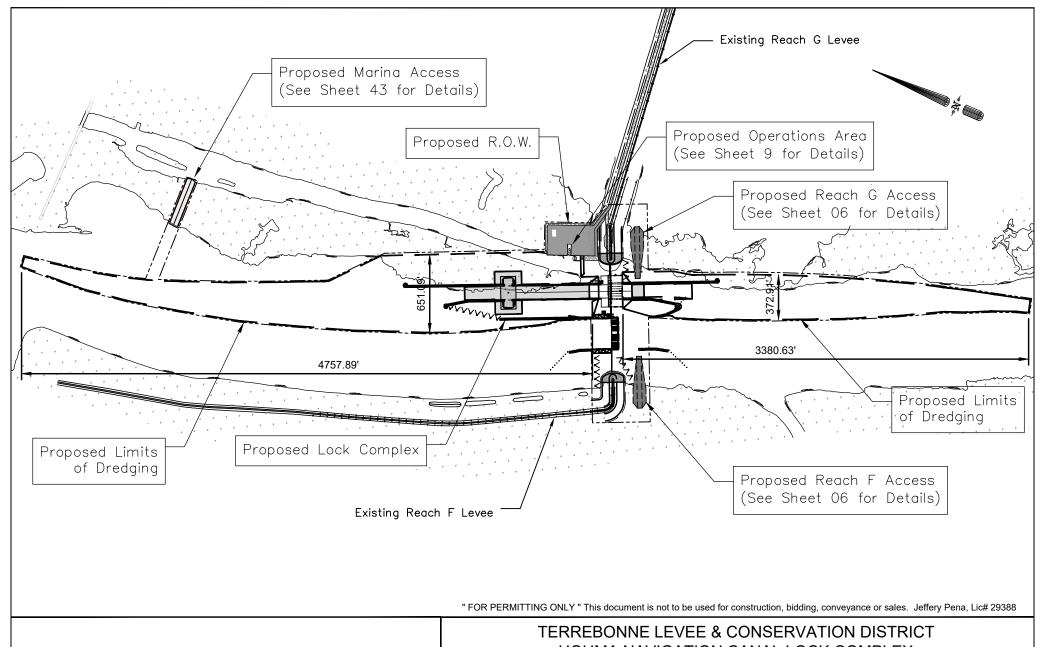
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### TERREBONNE LEVEE & CONSERVATION DISTRICT HOUMA NAVIGATION CANAL LOCK COMPLEX TERREBONNE PARISH, LA. T20S, R17E, SECTS 16 & 21

Date:	Drawn By:	Sheet No.:	Revisions:		
luna 2017	DMC	00	Revision No.:	Date:	Notes:
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### OVERALL PLAN


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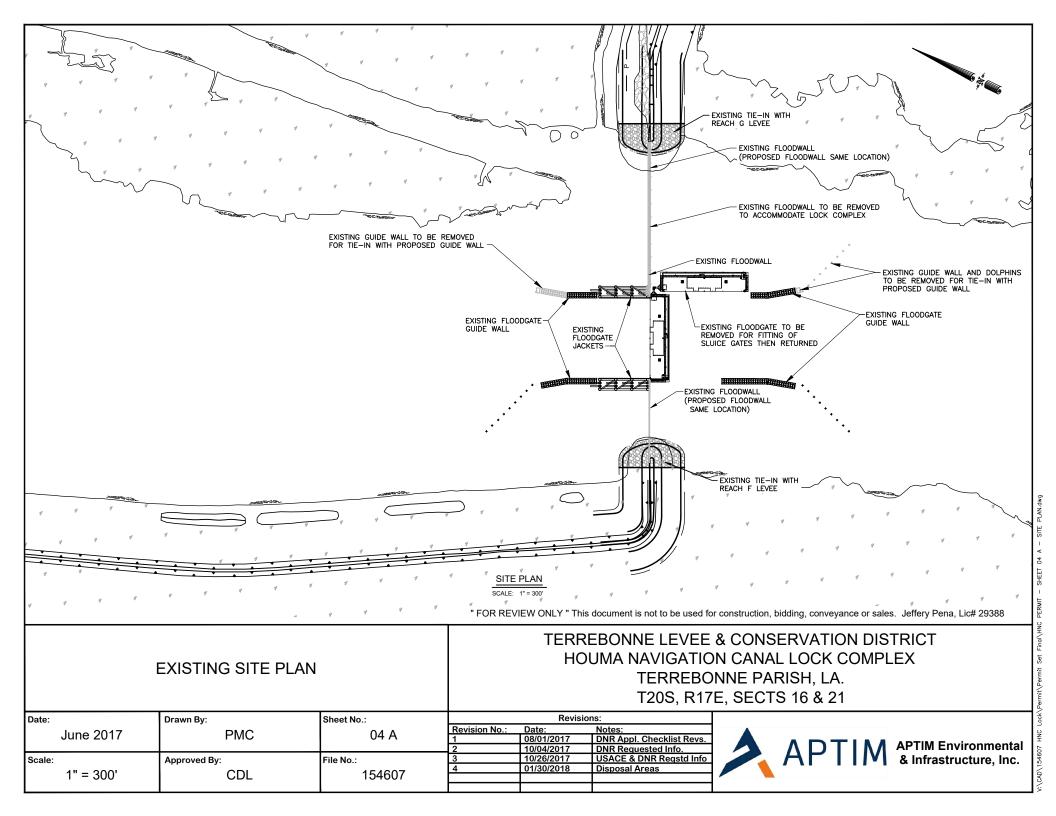
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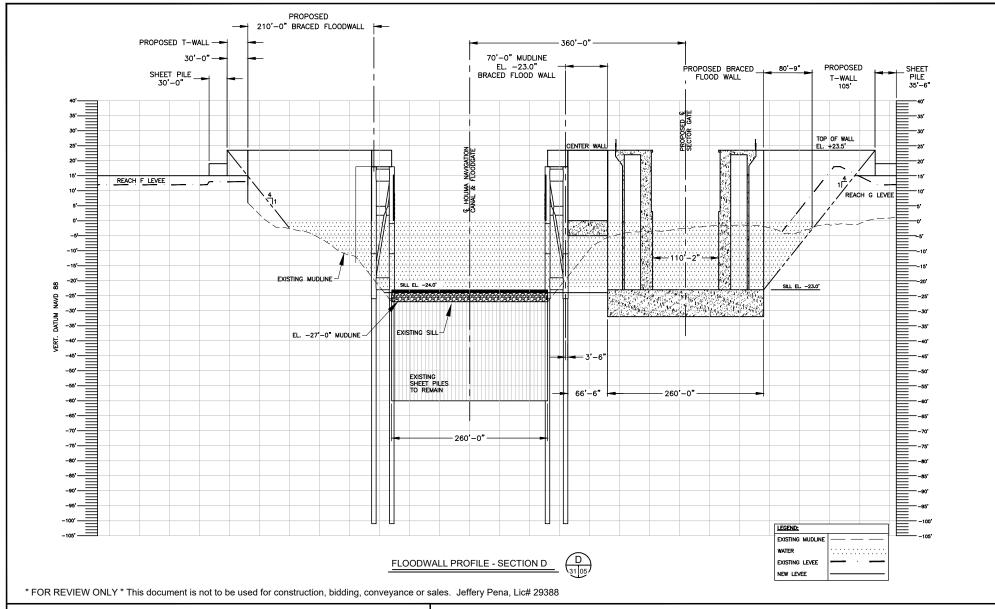
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APTIM Environmental & Infrastructure, Inc.








#### LOCK COMPLEX PROFILE
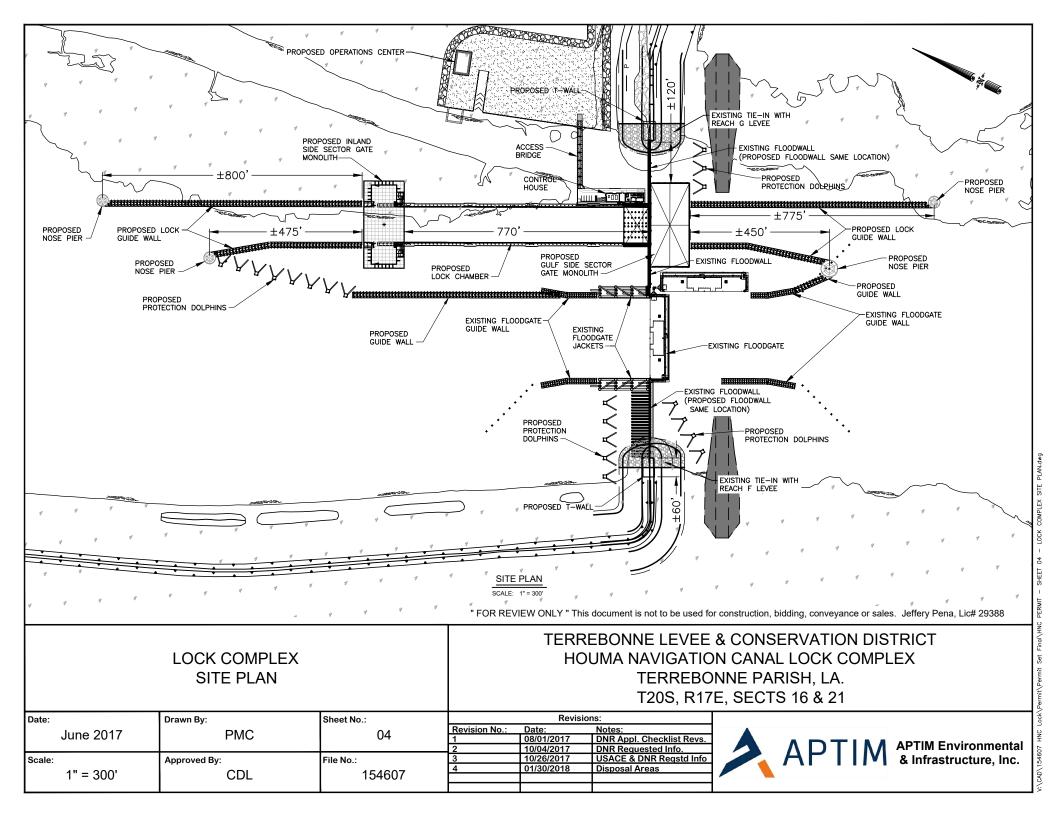
### TERREBONNE LEVEE & CONSERVATION DISTRICT HOUMA NAVIGATION CANAL LOCK COMPLEX TERREBONNE PARISH, LA. T20S, R17E, SECTS 16 & 21

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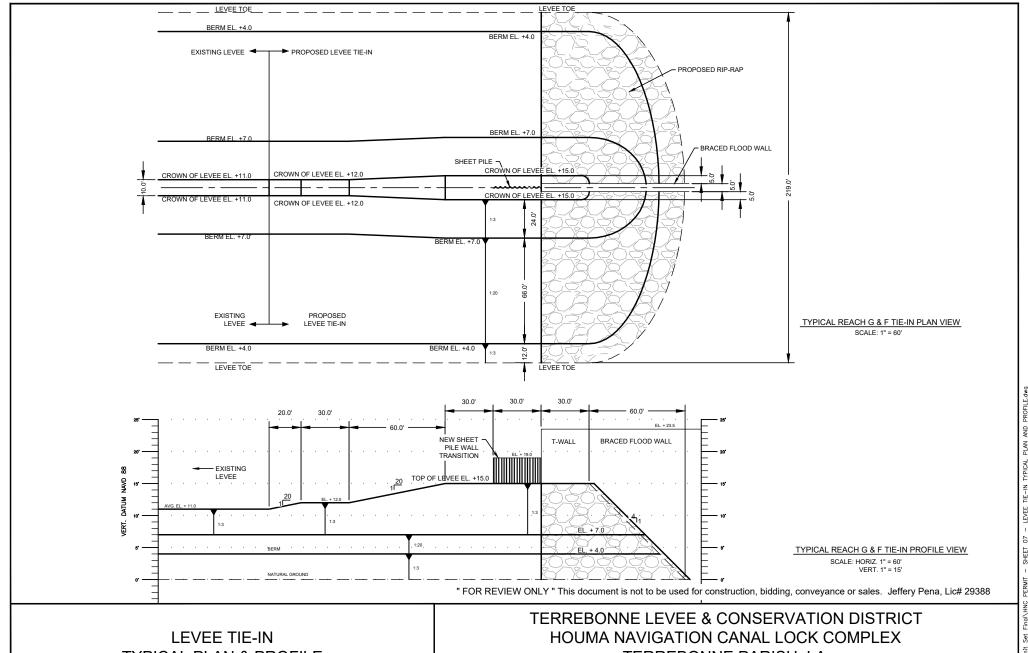
### LEVEE TIE-IN PLAN VIEW

TERREBONNE LEVEE & CONSERVATION DISTRICT HOUMA NAVIGATION CANAL LOCK COMPLEX TERREBONNE PARISH, LA. T20S, R17E, SECTS 16 & 21

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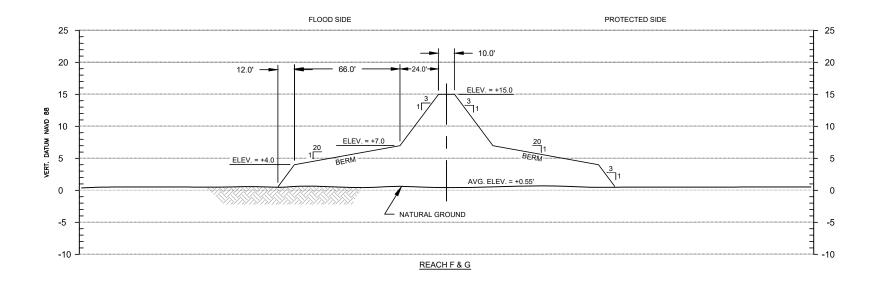


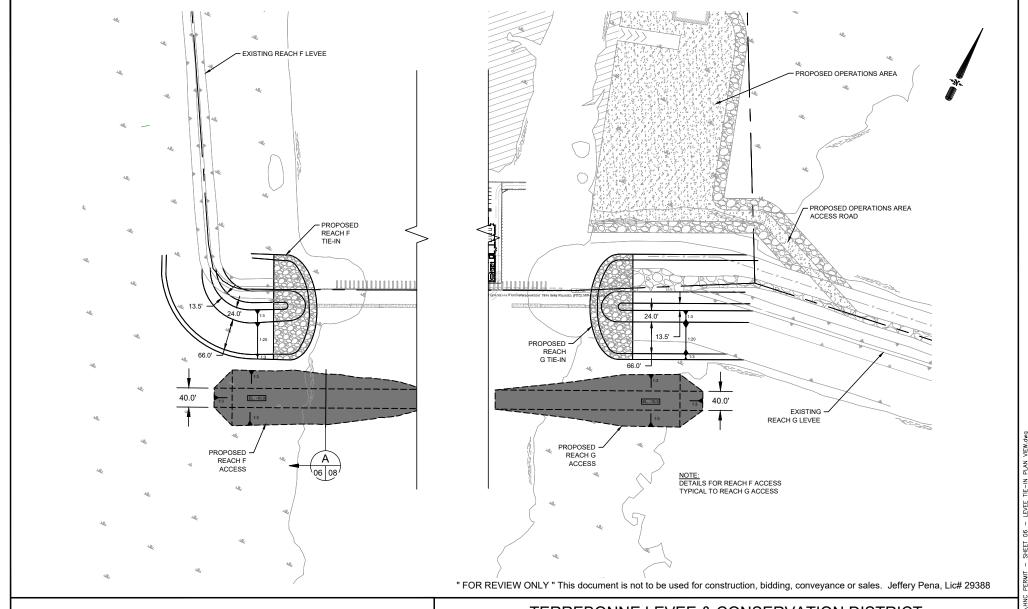
### **TYPICAL PLAN & PROFILE**

TERREBONNE PARISH, LA. T20S, R17E, SECTS 16 & 21


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Reach F and G Levee Access



SECTION SCALE: 1" = 40'-0"

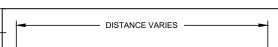
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### LEVEE TIE-IN **TYPICAL CROSS-SECTION**


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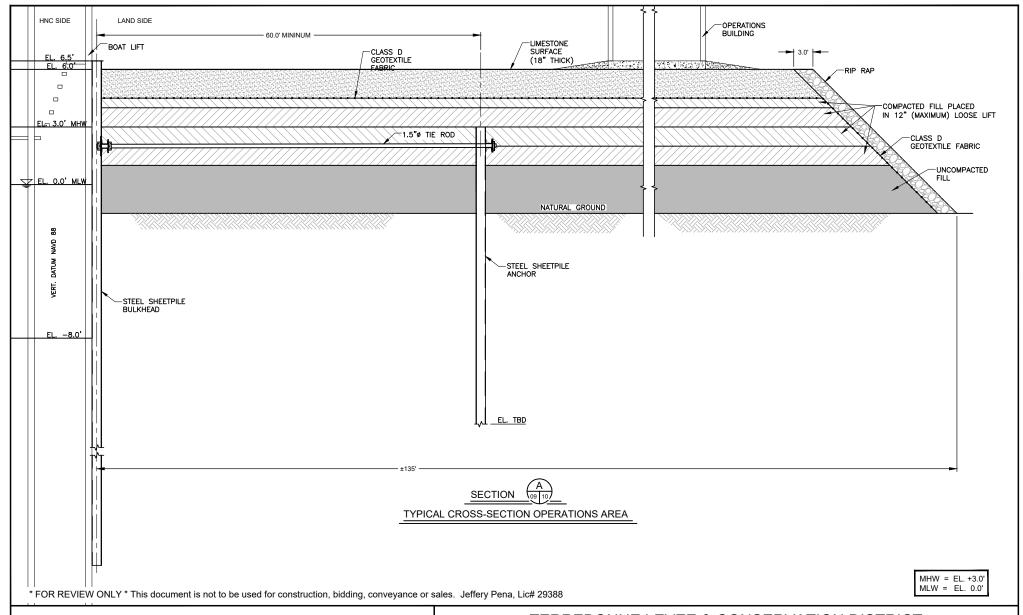
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T20S, R17E, SECTS 16 & 21
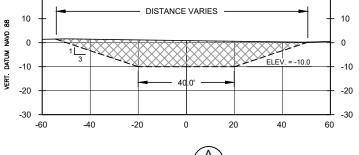
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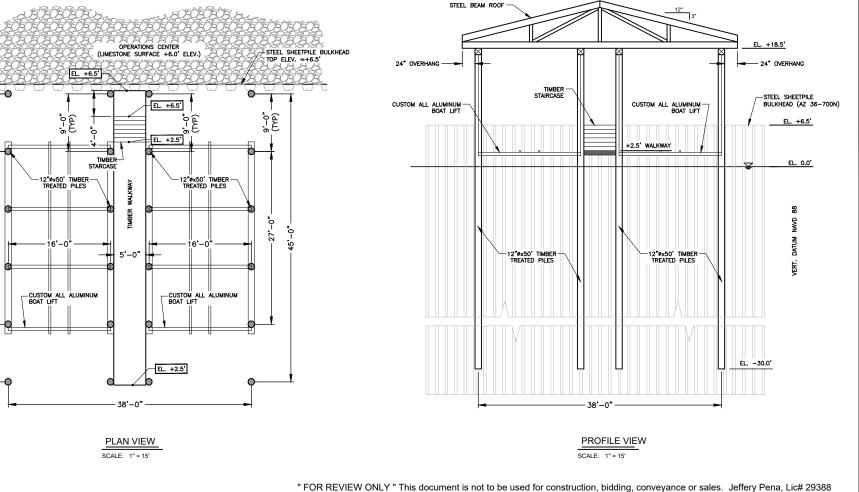




OPERATIONS CENTER TYPICAL EMBANKMENT & BULKHEAD CROSS SECTION
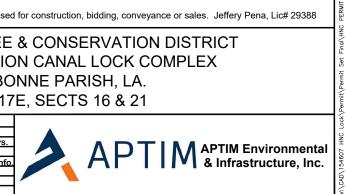
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# OPERATIONS CENTER BOAT LIFT PLAN AND PROFILE

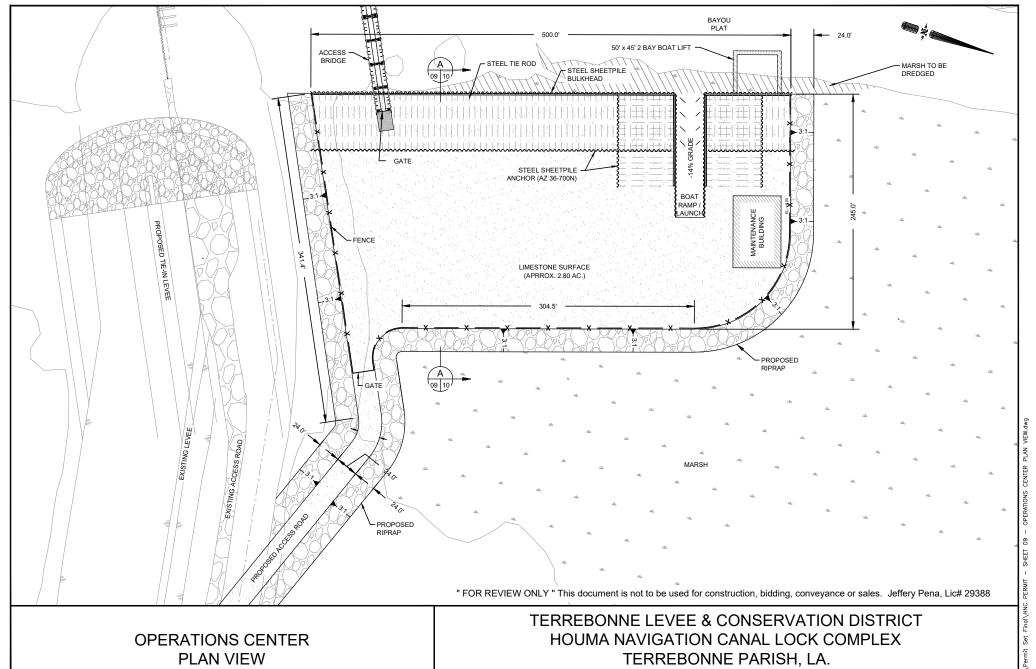
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> TERREBONNE LEVEE & CONSERVATION DISTRICT HOUMA NAVIGATION CANAL LOCK COMPLEX TERREBONNE PARISH, LA. T20S, R17E, SECTS 16 & 21

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luna 2017	DMC	4.4	Revision No.:	Date:	Notes:
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			2	10/04/2017	DNR Requested Info.
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## OPERATIONS CENTER MAINTENANCE BUILDING ELEVATIONS

TERREBONNE LEVEE & CONSERVATION DISTRICT HOUMA NAVIGATION CANAL LOCK COMPLEX TERREBONNE PARISH, LA. T20S, R17E, SECTS 16 & 21

Date:	Drawn By:	Sheet No.:		Revision	ns:		
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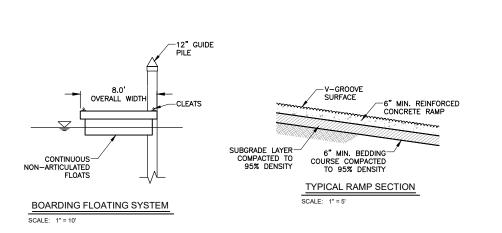



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### OPERATIONS CENTER BOAT LAUNCH PLAN AND PROFILE
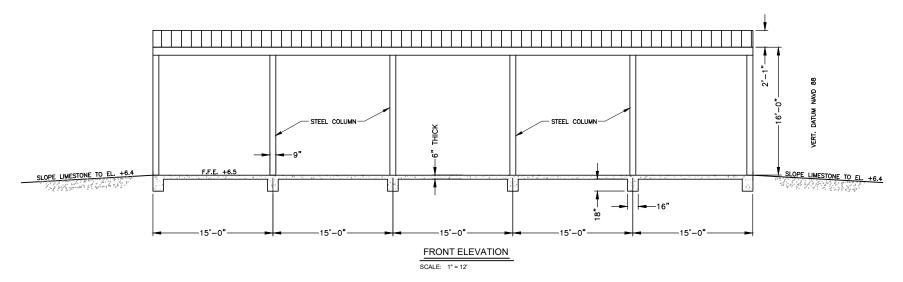
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TYPICAL RAMP SURFACE DETAILS

SCALE: 1" = 10'

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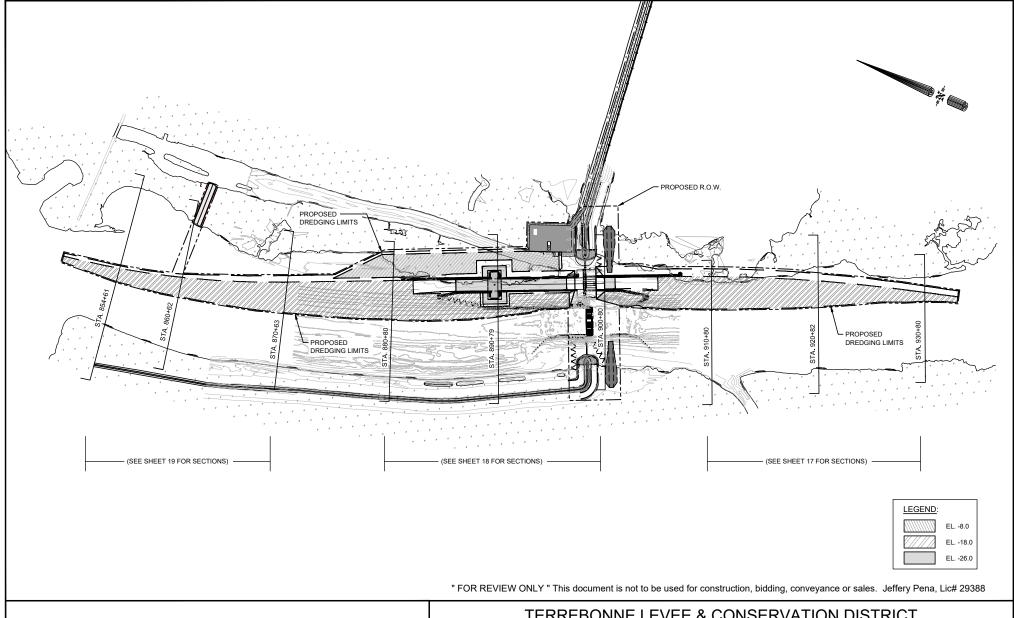
### OPERATIONS CENTER BOAT LAUNCH DETAILS

TERREBONNE LEVEE & CONSERVATION DISTRICT HOUMA NAVIGATION CANAL LOCK COMPLEX TERREBONNE PARISH, LA. T20S, R17E, SECTS 16 & 21
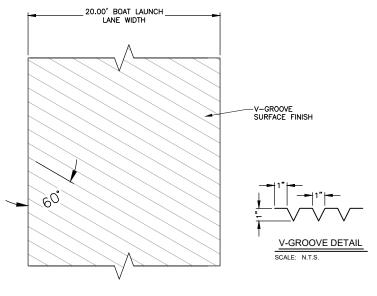
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				2	10/04/2017	DNR Requested Info.		
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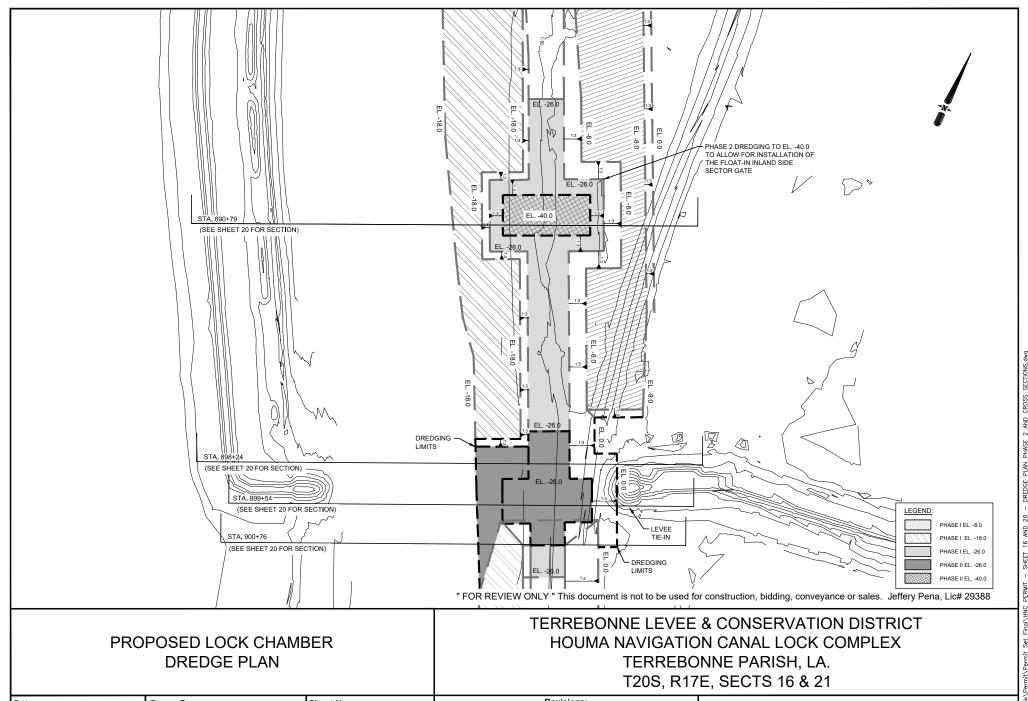
### DREDGE PLAN OVERALL PLAN

### TERREBONNE LEVEE & CONSERVATION DISTRICT HOUMA NAVIGATION CANAL LOCK COMPLEX TERREBONNE PARISH, LA. T20S, R17E, SECTS 16 & 21

	Date:	Drawn By:	Sheet No.:		Revisior	ns:	
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	June 2017	LDE	15	1	08/01/2017	DNR Appl. Checklist Revs.	
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June 2017	LDE	16	1	08/01/2017	DNR Appl. Checklist Revs.
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STA. 910+80
PROFILE FACING NORTHWESTERLY

DREDGE PLAN

**CROSS SECTIONS** 

LDE

CDL

154607

Drawn By:

Approved By:

Date:

Scale:

June 2017

(H) 1"=250'

(V) 1"=50'

HYDRAULIC DREDGE - 4605.7 SQ. FT.

10/04/2017

10/26/2017

DNR Requested Info.

Disposal Areas

USACE & DNR Rgstd Info.

June 2017

(H) 1"=250'

(V) 1"=50'

Scale:

LDE

CDL

Approved By:

18

154607

File No.:

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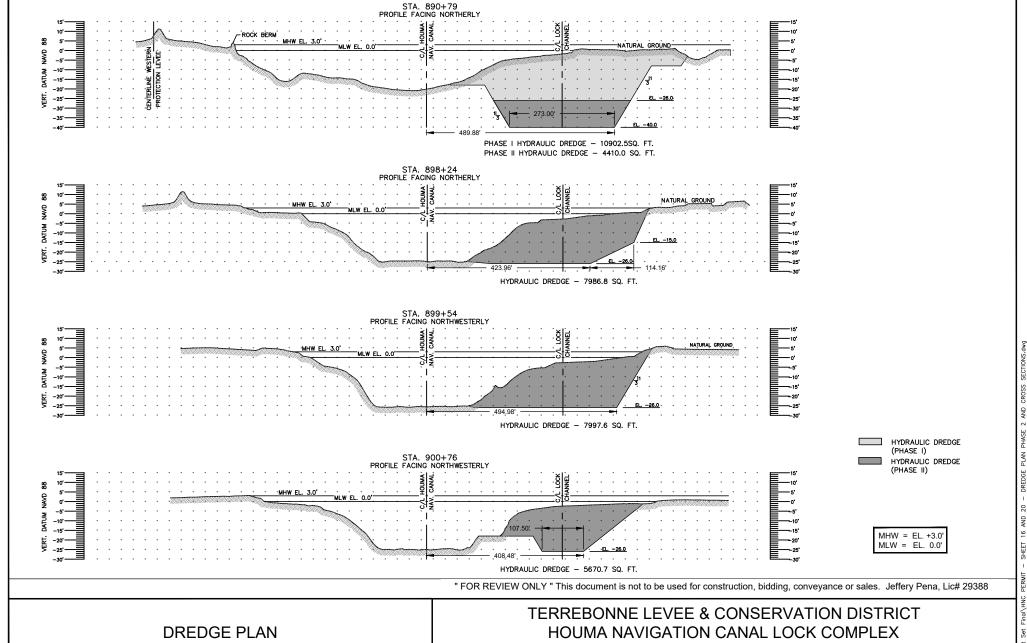
### **DREDGE PLAN CROSS SECTIONS**

TERREBONNE LEVEE & CONSERVATION DISTRICT HOUMA NAVIGATION CANAL LOCK COMPLEX TERREBONNE PARISH, LA. T20S, R17E, SECTS 16 & 21

Date:	Drawn By:	Sheet No.:		Revisio	ns:		
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			2	10/04/2017	DNR Requested Info.		
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(H) 1"=250'	, CDI	454007	4	01/30/2018	Disposal Areas		
`(V) 1"=50'	CDL	154607				1	
(۷) 1 –30							



:\CAD\154607 HNC Lock\Permit\Permit\Set Fina\HNC PERMIT - SHEET 17 THRU 19 - DREDGE PLAN OVERALL CROSS SECTIONS.dwg



# **CROSS SECTIONS**

## TERREBONNE PARISH, LA. T20S, R17E, SECTS 16 & 21

Date:	Drawn By: Sheet No.:		Revision	ns:	
luna 2017	LDE	20	Revision No.:	Date:	Notes:
June 2017	LDE	20	1	08/01/2017	DNR Appl. Checklist Revs.
			2	10/04/2017	DNR Requested Info.
Scale:	Approved By:	File No.:	3	10/26/2017	USACE & DNR Rqstd Info.
(H) 1"=250'		454007	4	01/30/2018	Disposal Areas
`(V) 1"=50'	CDL	154607			
( ) 1 – 30	<b>i</b>				





### FOUR POINT ROAD OVERALL PLAN


Date:	Drawn By:	Sheet No.:		Revisio	าร:
June 2017	l DMC	04	Revision No.:	Date:	Notes:
June 2017	PMC	∠ı [	1	08/01/2017	DNR Appl. Checklist Revs.
			2	10/04/2017	DNR Requested Info.
Scale:	Approved By:	File No.:	3	10/26/2017	USACE & DNR Rqstd Info.
4" 4 0001	CDI	454007	4	01/30/2018	Disposal Areas
1"=1,200'	CDL	154607			



SHEET 22 - FOUR POINT ROAD TYPICAL SECTION. dwg

#### **LEGEND**


- 1.5" SUPERPAVE ASPHALTIC CONCRETE (WEARING COURSE, PG64-22)
- 2) 1" BINDER
- (3.) COLD PLANE REMOVAL OF EXISTING ASPHALT PAVEMENT 1" IN DEPTH
- 4) EXISTING ASPHALTIC CONCRETE SURFACE TO REMAIN
- (5) EXISTING BASE COURSE TO REMAIN & PATCH AS DIRECTED BY ENGINEER (SEE DETAIL THIS SHEET)

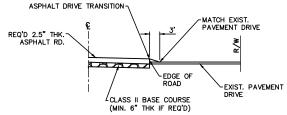


#### SECTION A-A

NOTE:

EXISTING FOUR POINT ROAD TO BE OVERLAID WITH 2.5" ASPHALT

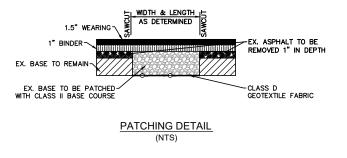

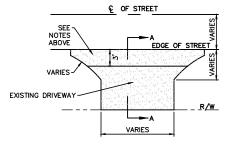


TYPICAL DRIVE TURNOUT (EXISTING)

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### FOUR POINT ROAD TYPICAL SECTIONS

Date:	Drawn By:	Sheet No.:		Revision	ns:
luna 2017	DMC	22	Revision No.:	Date:	Notes:
June 2017	PMC	22 1	1	08/01/2017	DNR Appl. Checklist Revs.
			2	10/04/2017	DNR Requested Info.
Scale:	Approved By:	File No.:	3	10/26/2017	USACE & DNR Rqstd Info.
NTO		454007	4	01/30/2018	Disposal Areas
N.T.S.	CDL	154607			
	l l				



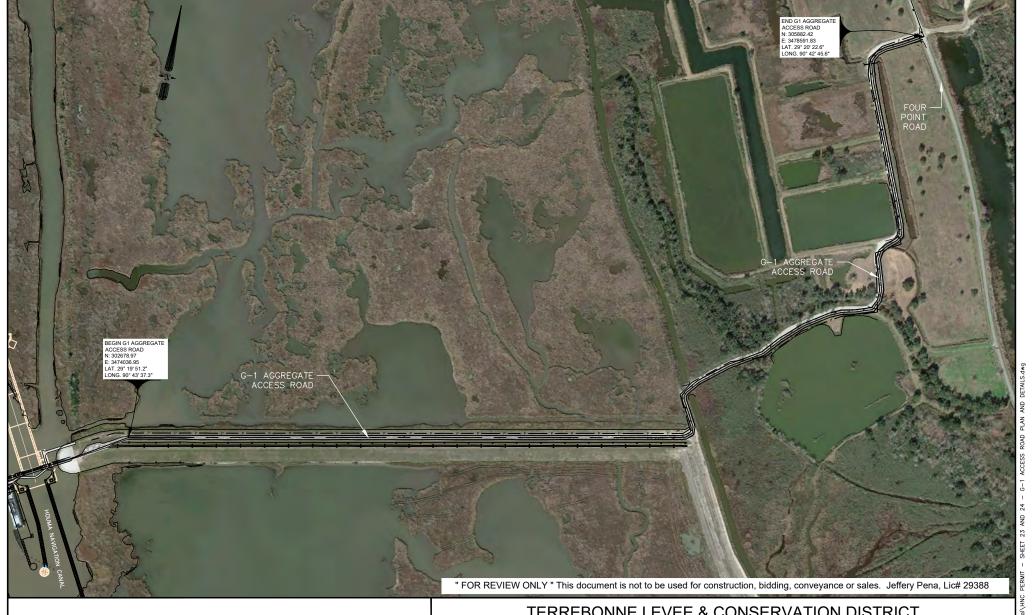


### G-1 ACCESS ROAD OVERALL PLAN

TERREBONNE LEVEE & CONSERVATION DISTRICT HOUMA NAVIGATION CANAL LOCK COMPLEX TERREBONNE PARISH, LA. T20S, R17E, SECTS 16 & 21

Date:	Drawn By:	Sheet No.:	Revisions:		ns:
luna 2017	DMC	22	Revision No.:	Date:	Notes:
June 2017	PMC	23	1	08/01/2017	DNR Appl. Checklist Revs.
			2	10/04/2017	DNR Requested Info.
Scale:	Approved By:	File No.:	3	10/26/2017	USACE & DNR Rqstd Info.
411 0001	''	454007	4	01/30/2018	Disposal Areas
1"=600'	CDL	154607			



54607 HNC Lock\Permit\Permit Set Final\HNC PERMIT - SHEI

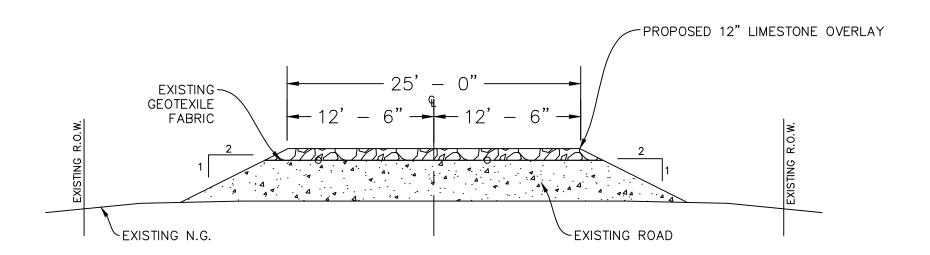

# TYPICAL SECTION EXISTING G-1 ACCESS ROAD WITH PROPOSED 12" LIMESTONE OVERLAY (N.T.S.)

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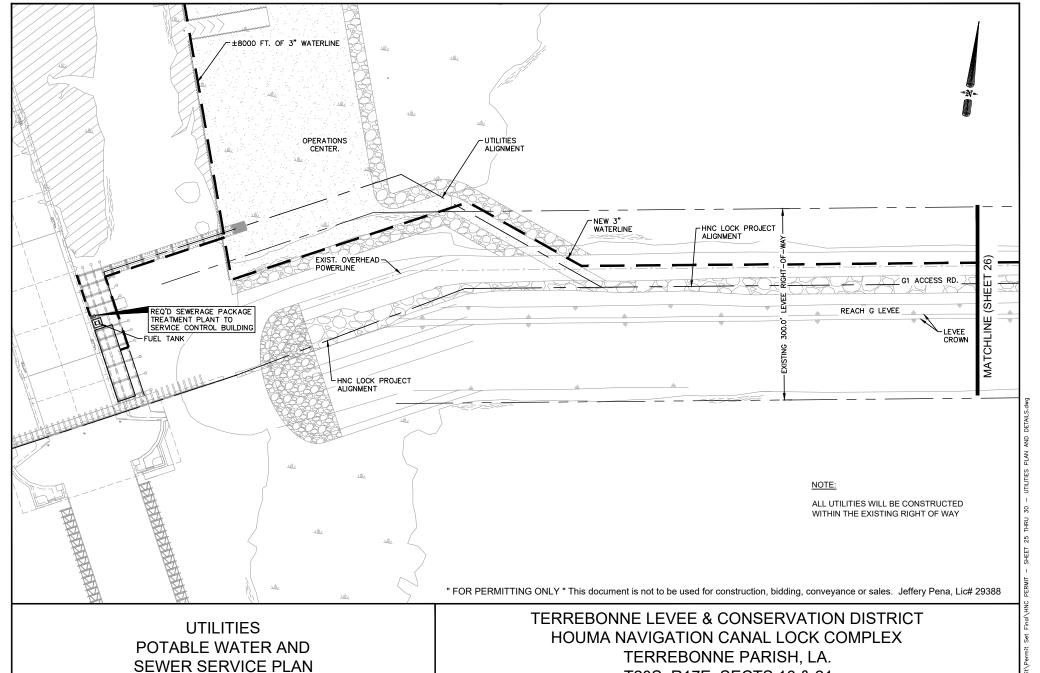
### G-1 ACCESS ROAD DETAILS

TERREBONNE LEVEE & CONSERVATION DISTRICT HOUMA NAVIGATION CANAL LOCK COMPLEX TERREBONNE PARISH, LA. T20S, R17E, SECTS 16 & 21

					į.			
	Date:	Drawn By:	Sheet No.:		Revision	าร:		
	luna 2017	DMC	24	Revision No.:	Date:	Notes:		
	June 2017	PMC	24	1	08/01/2017	DNR Appl. Checklist Revs.		
				2	10/04/2017	DNR Requested Info.		
	Scale:	Approved By:	File No.:	3	10/26/2017	USACE & DNR Rqstd Info.		
	N.T.S. CDL		154607	4	01/30/2018	Disposal Areas		
		CDL						




\CAD\154607 HNC Lock\Permit\Permit Set Final\HNC PERMIT — SHEET 23 AND 24 — G−1 ACCESS ROAD PLAN AND DETAILS.dwg



T20S, R17E, SECTS 16 & 21

Date:	Drawn By:	Sheet No.:		Revisio	ns:	_
luna 2017	DMC	25	Revision No.:	Date:	Notes:	
June 2017	PMC	25	1	08/01/2017	DNR Appl. Checklist Revs.	
			2	10/04/2017	DNR Requested Info.	
Scale:	Approved By:	File No.:	3	10/26/2017	USACE & DNR Rgstd Info.	
4"-450!	·· · · CDI	454607	4	01/30/2018	Disposal Areas	
1"=150'	CDL	154607				,



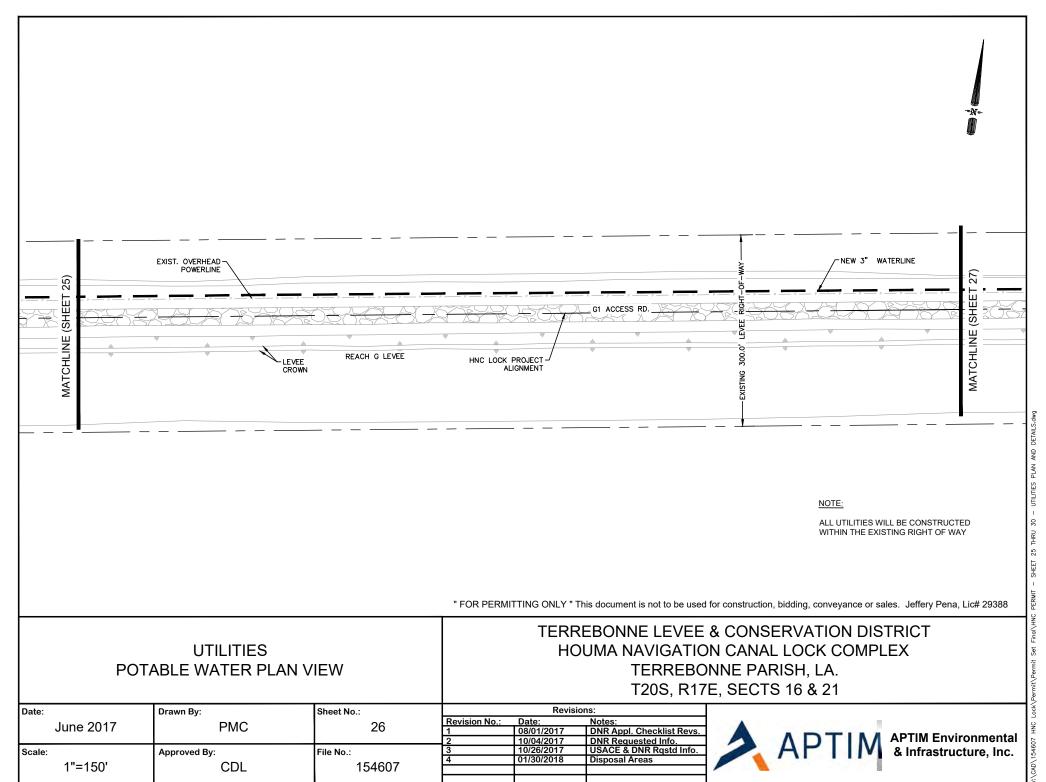


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### **UTILITIES** POTABLE WATER PLAN VIEW

Date:	Drawn By:	Sheet No.: Revisions:		ns:	ī	
luna 2017	DMC	1 00	Revision No.:	Date:	Notes:	
June 2017	PMC	26	1	08/01/2017	DNR Appl. Checklist Revs.	
			2	10/04/2017	DNR Requested Info.	
Scale:	Approved By:	File No.:	3	10/26/2017	USACE & DNR Rqstd Info.	
411 4501	1 ''	454007	4	01/30/2018	Disposal Areas	
1"=150'	CDL	154607				




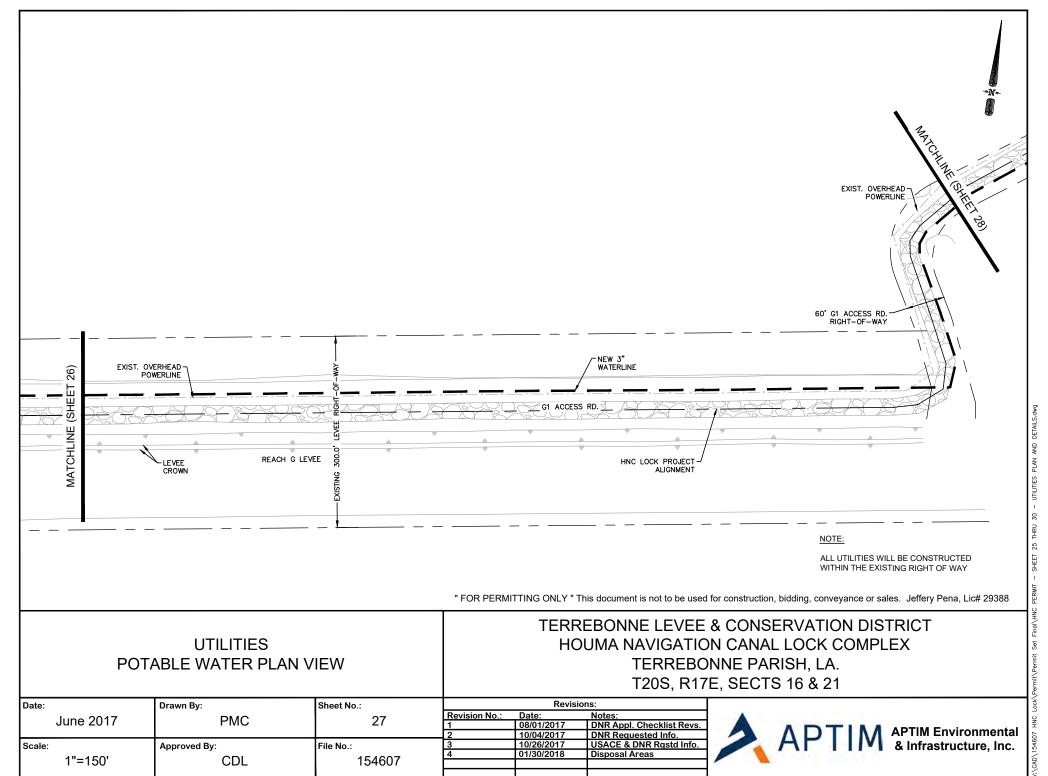

### **UTILITIES** POTABLE WATER PLAN VIEW

Date:	Drawn By:	Sheet No.:	Revisions:		ns:
luna 2017	DMC	0.7	Revision No.:	Date:	Notes:
June 2017	PMC	21	1	08/01/2017	DNR Appl. Checklist Revs.
			2	10/04/2017	DNR Requested Info.
Scale:	Approved By:	File No.:	3	10/26/2017	USACE & DNR Rqstd Info.
4"-450"	1 ''	454007	4	01/30/2018	Disposal Areas
1"=150'	CDL	154607			




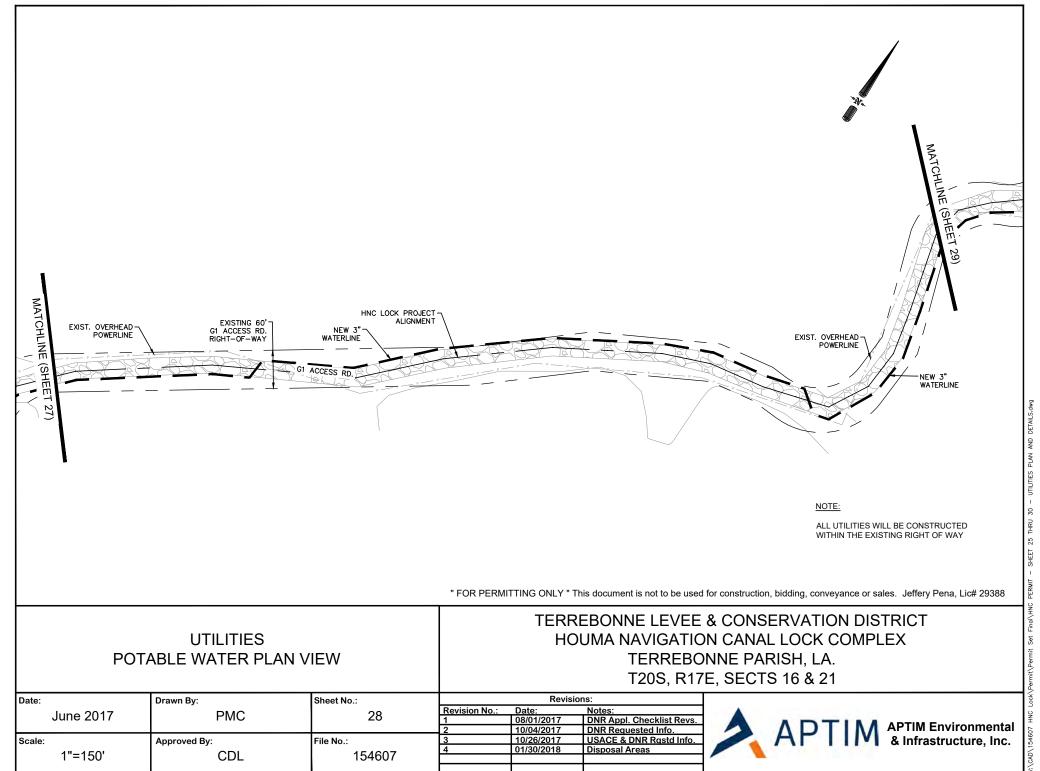

### **UTILITIES** POTABLE WATER PLAN VIEW

Date:	Drawn By:	Sheet No.: Re		Revisior	isions:	
luna 2017	DMC	20	Revision No.:	Date:	Notes:	
June 2017	PMC	28	1	08/01/2017	DNR Appl. Checklist Revs.	
			2	10/04/2017	DNR Requested Info.	
Scale:	Approved By:	File No.:	3	10/26/2017	USACE & DNR Rgstd Info.	
4"-450	''	454007	4	01/30/2018	Disposal Areas	
1"=150'	CDL	154607				



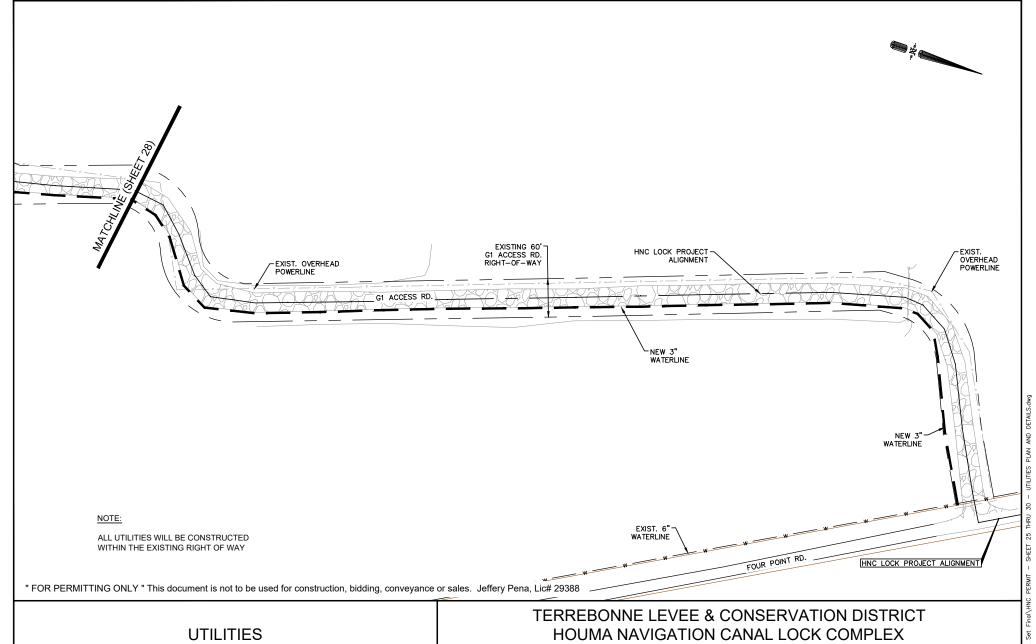


# POTABLE WATER PLAN VIEW

TERREBONNE PARISH, LA. T20S, R17E, SECTS 16 & 21

Date:	Drawn By:	Sheet No.:	Revisions:		าร:	
luna 2017	DMC	20	Revision No.:	Date:	Notes:	
June 2017	PMC	29	1	08/01/2017	DNR Appl. Checklist Revs.	
			2		DNR Requested Info.	
Scale:	Approved By:	File No.:	3		USACE & DNR Rqstd Info.	
4"-450	''	454007	4	01/30/2018	Disposal Areas	
1"=150'	CDL	154607				
			, and the second			



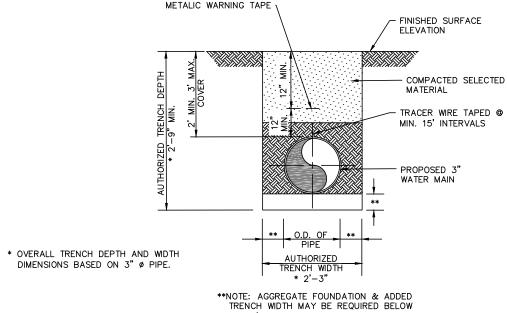

TRENCH WIDTH MAY BE REQUIRED BELOW AND / OR AROUND WATERLINE IN SPECIAL CIRCUMSTANCES OR UNSTABLE SOIL CONDITIONS AS DIRECTED BY ENGINEER

RIVERSAND OR AGGREGATE REQUIRED UNDER IMPROVED OR HARD SURFACE.

TYPICAL WATERLINE TRENCH SECTION

N.T.S.

NOTE:


ALL UTILITIES WILL BE CONSTRUCTED WITHIN THE EXISTING RIGHT OF WAY

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# UTILITIES POTABLE WATER AND SEWER SERVICE DETAILS

Date:	Drawn By:	Sheet No.:	Revisions:			
luna 2017	DMC	l 20	Revision No.:	Date:	Notes:	
June 2017	PMC	30	1	08/01/2017	DNR Appl. Checklist Revs.	
			2	10/04/2017	DNR Requested Info.	
Scale:	Approved By:	File No.:	3	10/26/2017	USACE & DNR Rqstd Info.	
l NTC	] `` OD!	454007	4	01/30/2018	Disposal Areas	
N.T.S.	CDL	154607				



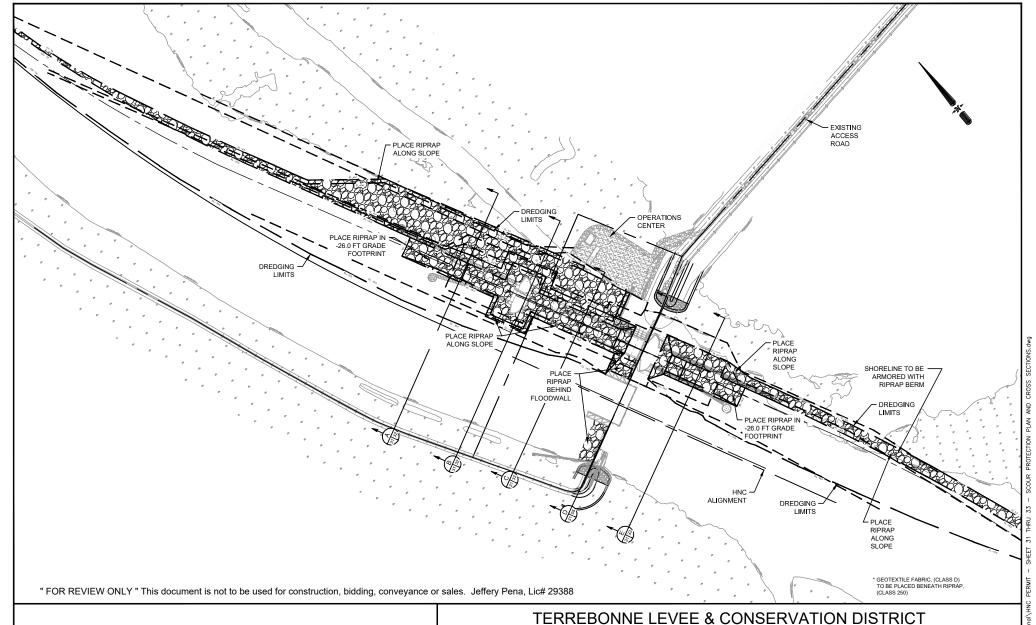

### SCOUR PROTECTION PLAN VIEW

Date:	Drawn By:	Sheet No.:		Revisior	ns:
luna 2017	DMC	0.4	Revision No.:	Date:	Notes:
June 2017	PMC	31	1	08/01/2017	DNR Appl. Check
			2	10/04/2017	DNR Requested
Scale:	Approved By:	File No.:	3	10/26/2017	USACE & DNR R
4" - 0001	''	454007	4	01/30/2018	Disposal Areas
1" = 600'	CDL	154607			



# SCOUR PROTECTION CROSS SECTIONS


# TERREBONNE LEVEE & CONSERVATION DISTRICT HOUMA NAVIGATION CANAL LOCK COMPLEX TERREBONNE PARISH, LA.

	Date:	Drawn By:	Sheet No.:		Revision	ns:	Г		
	luna 2017	DMC	32 F	Revision No.:	Date:	Notes:	ı		
	June 2017	PMC		1	08/01/2017	DNR Appl. Checklist Revs.	ı		
				2	10/04/2017	DNR Requested Info.	1		
	Scale:	Approved By:	File No.:	1 08/01/2017 DNR Appl. Ch 2 10/04/2017 DNR Request 3 10/26/2017 USACE & DNI	USACE & DNR Rqstd Info.	1			
	Horiz. 1" = 200'	· · · · · · · · · · · · · · · · · · ·	454007	4	01/30/2018	Disposal Areas	1		
	Vert. 1" = 40'	CDL	154607				_		
	V GI L. 1 - 40						ı		



APTIM Environmental & Infrastructure, Inc.

- SHEET 31 THRU 33 - SCOUR PROTECTION PLAN AND CROSS SECTIONS.dwg

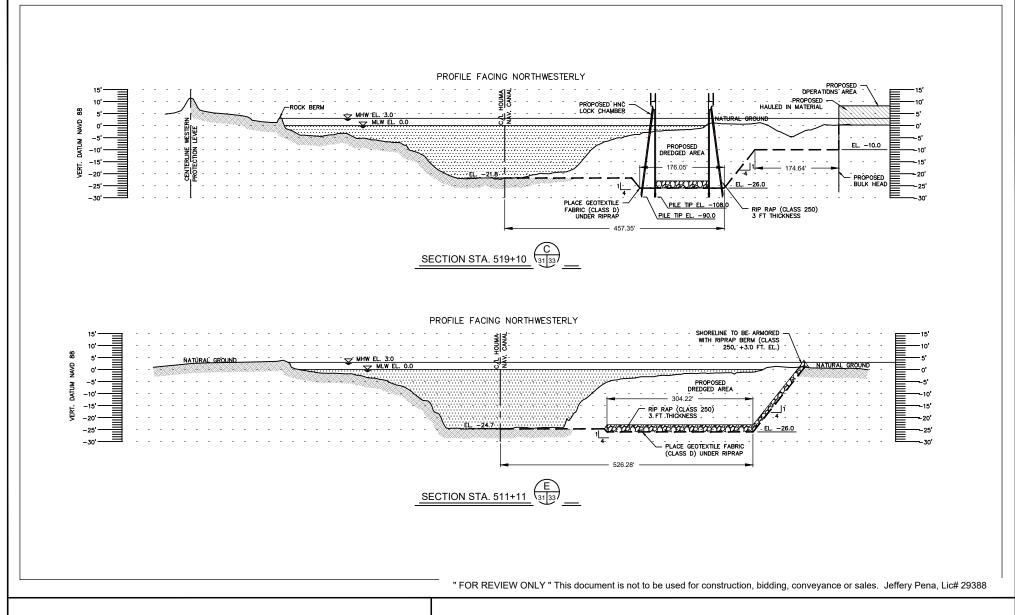


# SCOUR PROTECTION CROSS SECTIONS

# TERREBONNE LEVEE & CONSERVATION DISTRICT HOUMA NAVIGATION CANAL LOCK COMPLEX TERREBONNE PARISH, LA.

Date:	Drawn By:	Sheet No.:		Revision	ns:	Г
luna 2017	DMC	م م	Revision No.:	Date:	Notes:	i
June 2017	PMC	33	1	08/01/2017	DNR Appl. Checklist Revs.	ĺ
			2	10/04/2017	DNR Requested Info.	ı
Scale:	Approved By:	File No.:	3	10/26/2017	USACE & DNR Rqstd Info.	
Horiz. 1" = 200'	•	454007	4	01/30/2018	Disposal Areas	1
Vert. 1" = 40'	CDL	154607				ľ
V CI L. I - 40	<b>'</b>					i




- SHEET 31 THRU 33 - SCOUR PROTECTION PLAN AND CROSS SECTIONS.dwg :\CAD\154607 HNC Lock\Permit\Permit Set Final\HNC PERMIT

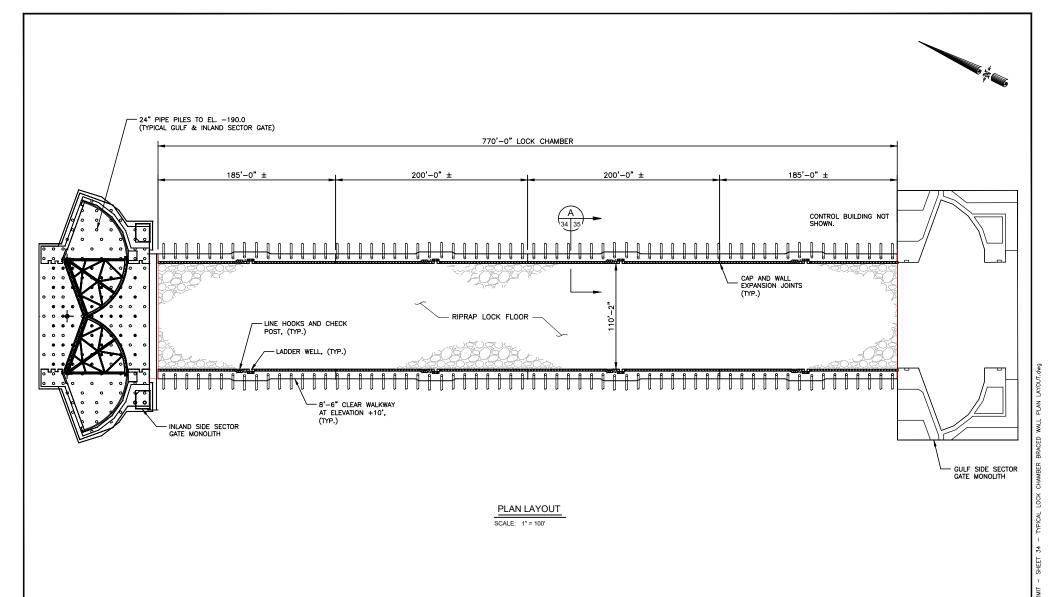


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#### TYPICAL LOCK CHAMBER **BRACED WALL PLAN LAYOUT**

Date:	Drawn By:	Sheet No.:		Revisior	ns:
June 2017	DMC	24	Revision No.:	Date:	Notes:
June 2017	PMC	34	1	08/01/2017	DNR Appl. Checklist Revs.
			2	10/04/2017	DNR Requested Info.
Scale:	Approved By:	File No.:	3	10/26/2017	USACE & DNR Regstd Info
4" - 4001	,,	454007	4	01/30/2018	Disposal Areas
1" = 100'	CDL	154607			
			, and the second		



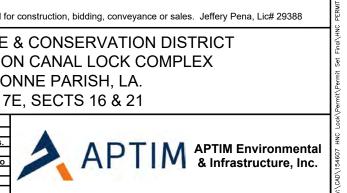
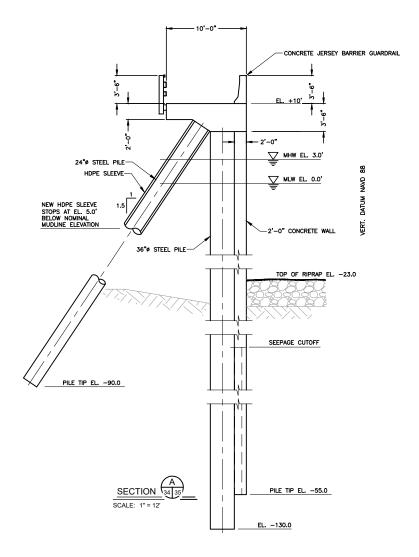
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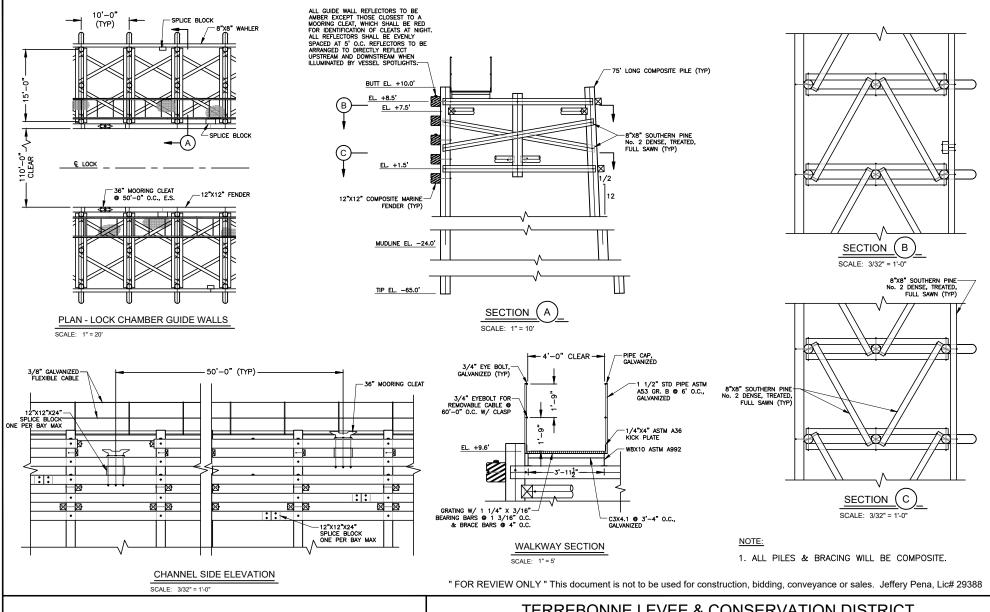
### TYPICAL LOCK CHAMBER BRACED WALL SECTION

TERREBONNE LEVEE & CONSERVATION DISTRICT HOUMA NAVIGATION CANAL LOCK COMPLEX TERREBONNE PARISH, LA. T20S, R17E, SECTS 16 & 21

Date:	Drawn By:	Sheet No.:		Revision	ns:
June 2017	DMC	٥.	Revision No.:	Date:	Notes:
June 2017	PMC	35	1	08/01/2017	DNR Appl. Checklist Revs.
			2	10/04/2017	DNR Requested Info.
Scale:	Approved By:	File No.:	3	10/26/2017	USACE & DNR Regstd Info
4" - 40!	,,	454007	4	01/30/2018	Disposal Areas
1" = 12'	CDL	154607			



HNC Lock\Permit\Permit Set Final\HNC PERMIT - SHEET 35 - TYPICAL LOCK CHAMBER BRACED WALL SECTION




## TYPICAL GUIDE WALL DETAILS

### TERREBONNE LEVEE & CONSERVATION DISTRICT HOUMA NAVIGATION CANAL LOCK COMPLEX TERREBONNE PARISH, LA. T20S, R17E, SECTS 16 & 21

Date:	Drawn By:	Sheet No.:		Revisio	ns:
June 2017	DMC	36 R	Revision No.:	Date:	Notes:
June 2017	PMC		1	08/01/2017	DNR Appl. Checklist Revs.
			2	10/04/2017	DNR Requested Info.
Scale:	Approved By:	File No.:	3	10/26/2017	USACE & DNR Regstd Info
VADIEC	1 ''	454007	4	01/30/2018	Disposal Areas
VARIES	CDL	154607			
1				·	



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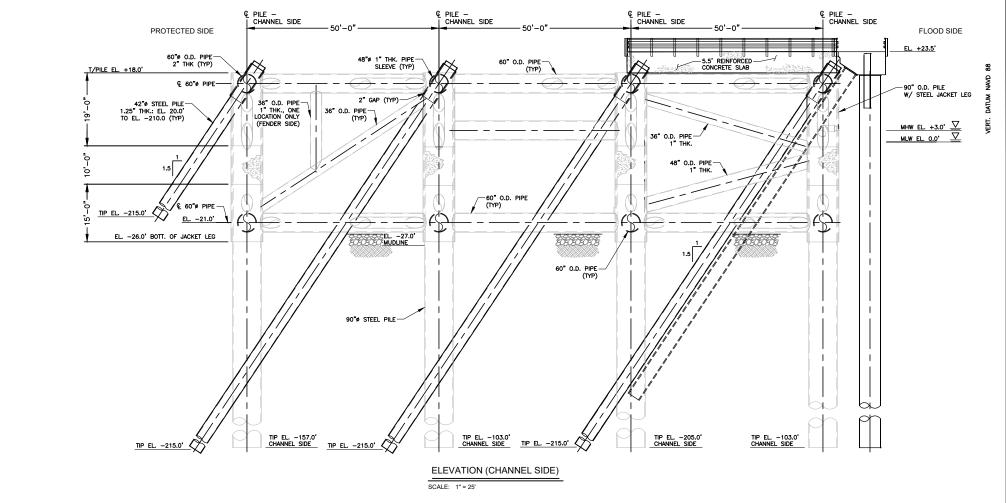

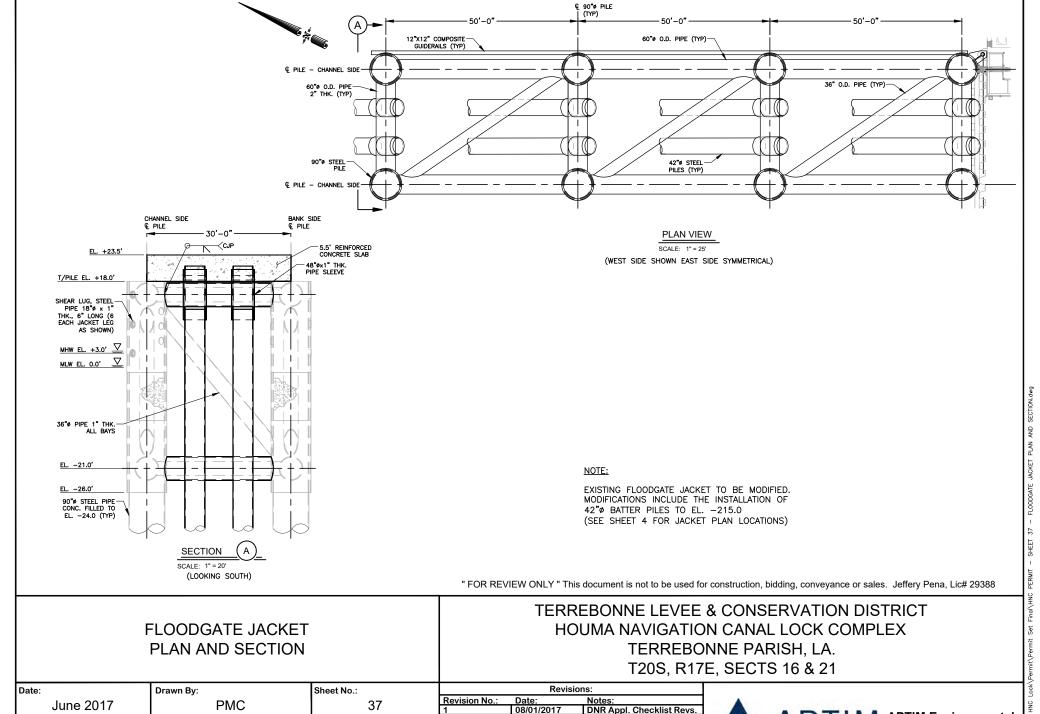
### FLOODGATE JACKET PLAN AND SECTION

HOUMA NAVIGATION CANAL LOCK COMPLEX TERREBONNE PARISH, LA. T20S, R17E, SECTS 16 & 21

Date:	Drawn By: Sheet No.:		Revisions:		
June 2017	DMC	27	Revision No.:	Date:	Notes:
June 2017	PMC	] 3/	1	08/01/2017	DNR Appl. Checklist Revs.
			2	10/04/2017	DNR Requested Info.
Scale:	Approved By:	File No.:	3	10/26/2017	USACE & DNR Regstd Info
VADIEC	1 · · · · · ODI	454007	4	01/30/2018	Disposal Areas
VARIES	CDL	154607			





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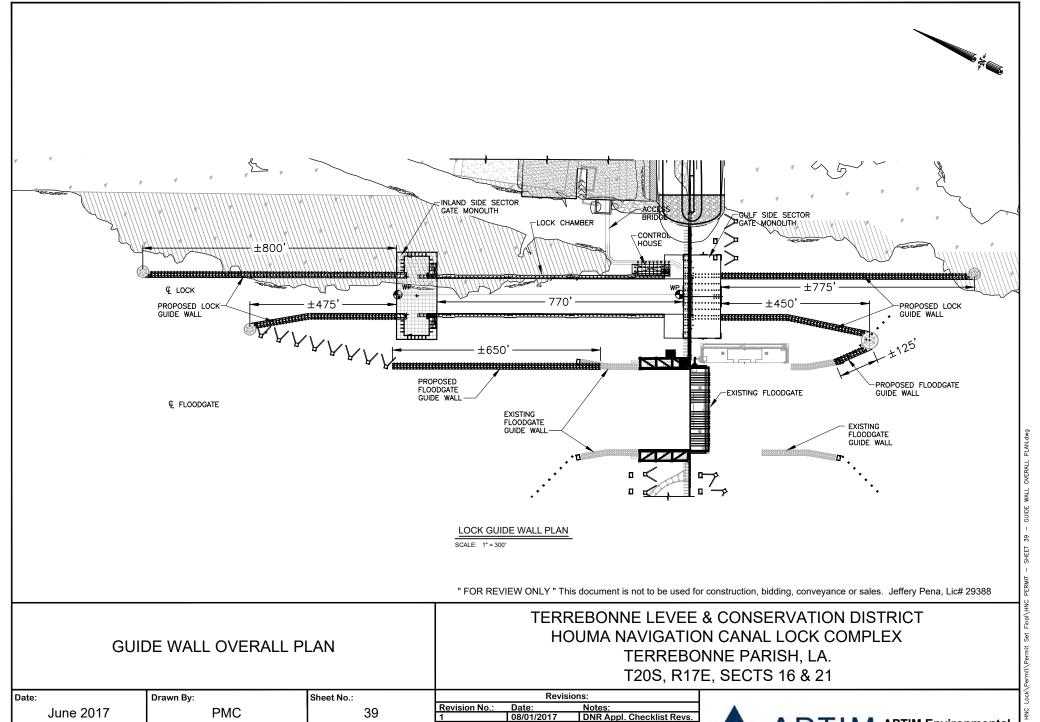
#### FLOODGATE JACKET CHANNEL SIDE ELEVATION

TERREBONNE LEVEE & CONSERVATION DISTRICT HOUMA NAVIGATION CANAL LOCK COMPLEX TERREBONNE PARISH, LA. T20S, R17E, SECTS 16 & 21

Date:	Drawn By:	Sheet No.:		Revisio	ns:
luna 2017	DMC	38	Revision No.:	Date:	Notes:
June 2017	PMC		1	08/01/2017	DNR Appl. Checklist Revs.
			2	10/04/2017	DNR Requested Info.
Scale:	Approved By:	File No.:	3	10/26/2017	USACE & DNR Regstd Info
4" - 051	1 ''	454007	4	01/30/2018	Disposal Areas
1" = 25'	CDL	154607			
		I			




HNC Lock/Permit/Permit Set Final/HNC PERMIT - SHEET 38 - FLOODGATE JACKET CHANNEL SIDE ELEVATION.dwg



#### **GUIDE WALL OVERALL PLAN**

Date:	Drawn By:	Sheet No.:		Revisior	ıs:
luna 2017	DMC	م م	Revision No.:	Date:	Notes:
June 2017	PMC	39	1	08/01/2017	DNR Appl. Checklist Revs.
			2	10/04/2017	DNR Requested Info.
Scale:	Approved By:	File No.:	3	10/26/2017	USACE & DNR Regstd Info
4" - 2001	, CDI	454607	4	01/30/2018	Disposal Areas
1" = 300'	CDL	154607			



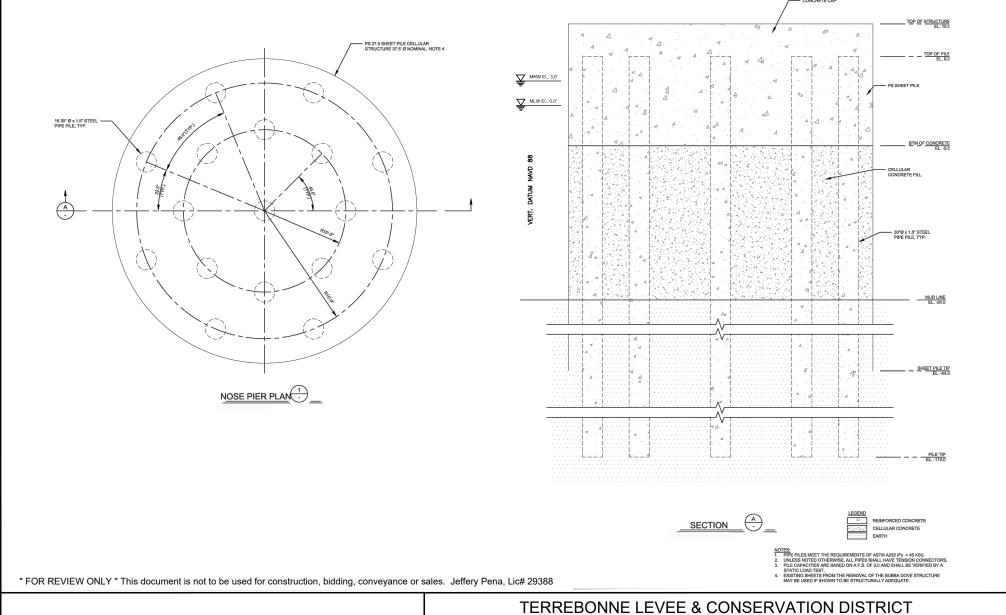


### NOSE PIER DETAILS

TERREBONNE LEVEE & CONSERVATION DISTRICT HOUMA NAVIGATION CANAL LOCK COMPLEX TERREBONNE PARISH, LA. T20S, R17E, SECTS 16 & 21

Date:	Drawn By:	Sheet No.:		Revisio	ons:
luna 2017	June 2017 PMC	40	Revision No.:	Date:	Notes:
June 2017			1	08/01/2017	DNR Appl. Checklist Revs.
			2	10/04/2017	DNR Requested Info.
Scale:	Approved By:	File No.:	3	10/26/2017	USACE & DNR Regstd Info
NTO	''	454007	4	01/30/2018	Disposal Areas
N.T.S.	CDL	154607			
i		I			




- SHEET 40 - NOSE PIER DETAILS.dwg

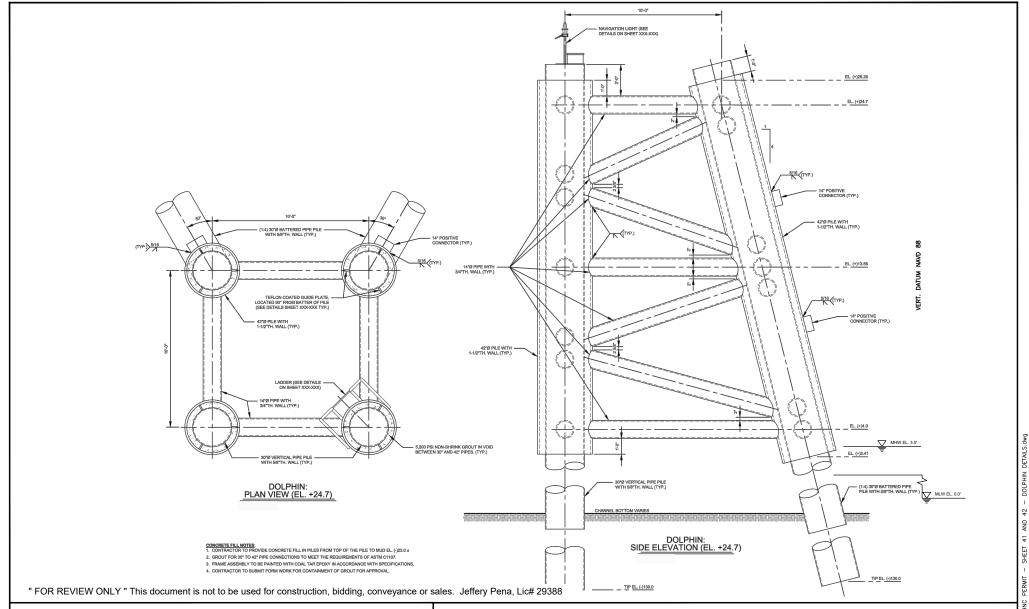

### DOLPHIN PLAN AND ELEVATION FLOOD SIDE +24.7

					<u> </u>
Date:	Drawn By:	Sheet No.:		Revisio	ns:
luna 2017	DMC	1 44	Revision No.:	Date:	Notes:
June 2017	PMC	41	1	08/01/2017	DNR Appl. Checklist Revs.
			2	10/04/2017	DNR Requested Info.
Scale:	Approved By:	File No.:	3	10/26/2017	USACE & DNR Regstd Info
NTC	1 ' CDI	154607	4	01/30/2018	Disposal Areas
N.1.5	N.T.S CDL	154607			




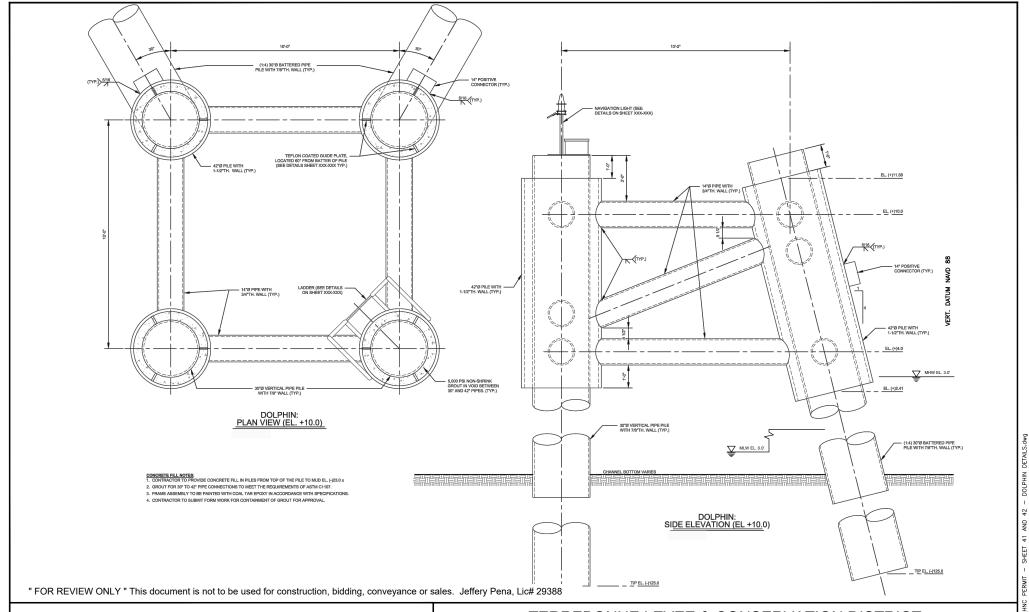

### DOLPHIN PLAN AND ELEVATION PROTECTED SIDE +10.0'

					<u></u>	
Date:	Drawn By:	Sheet No.:		Revision	ns:	
luna 2017	DMC	40	Revision No.:	Date:	Notes:	
June 2017	PMC	42	1	08/01/2017	DNR Appl. Checklist Revs.	
			2	10/04/2017	DNR Requested Info.	
Scale:	Approved By:	File No.:	3	10/26/2017	USACE & DNR Regstd Info	
NTC	·· · · · · · · · · · · · · · · · · · ·	454607	4	01/30/2018	Disposal Areas	į,
N.T.S.	CDL	154607				•




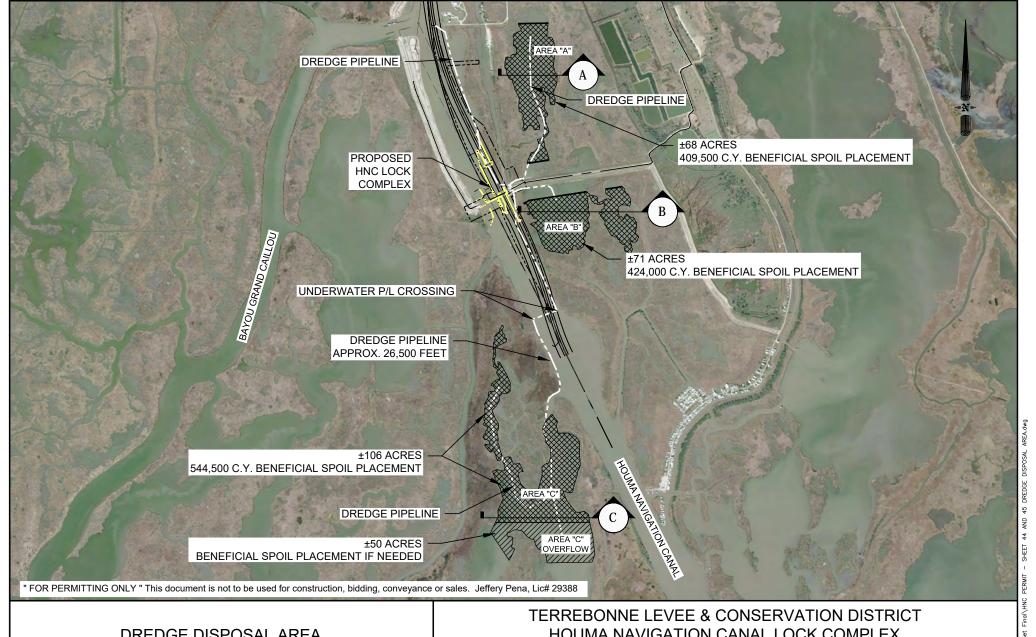


## DREDGE DISPOSAL AREA PLAN

Date:	Drawn By:	Sheet No.:		Revisior	is:
luna 2017	IDE	4.4	Revision No.:	Date:	Notes:
June 2017	LDE	44	1	08/01/2017	DNR Appl. Checklist Revs.
			2	10/04/2017	DNR Requested Info.
Scale:	Approved By:	File No.:	3		DNR Requested Info.
411-0.0001	· · · · · · · · · · · · · · · · · · ·	454007	4	01/30/2018	Disposal Areas
1"=2,600'	CDL	154607			
			,		· ·



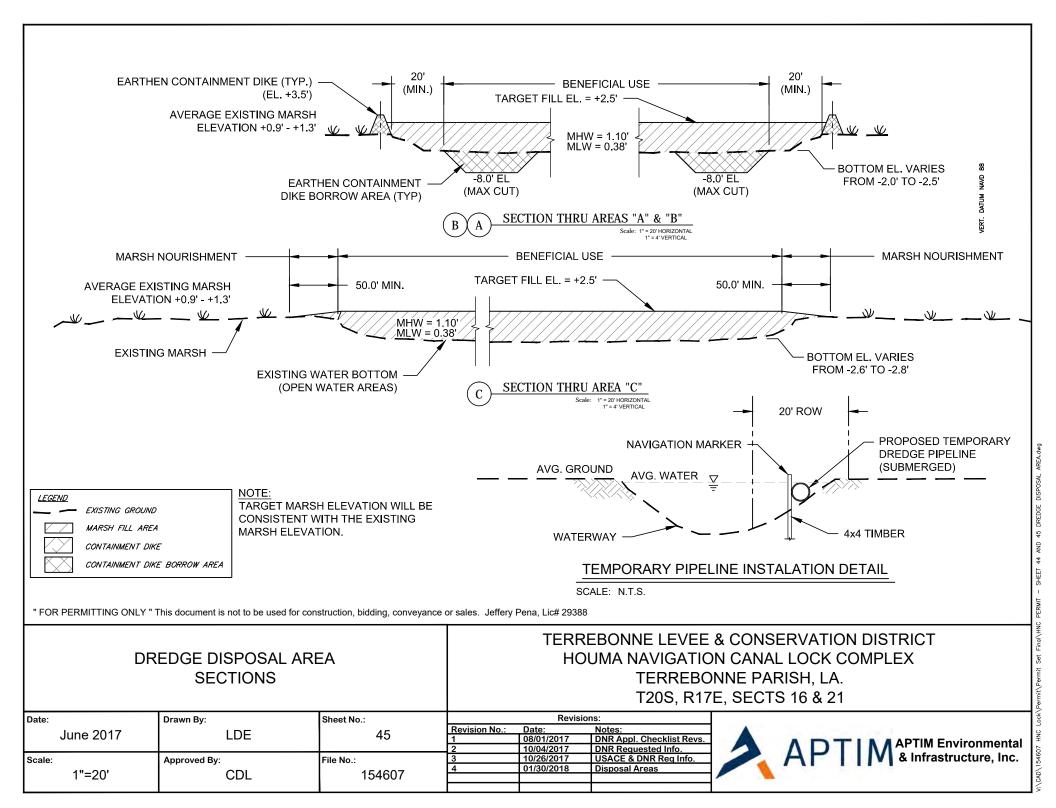

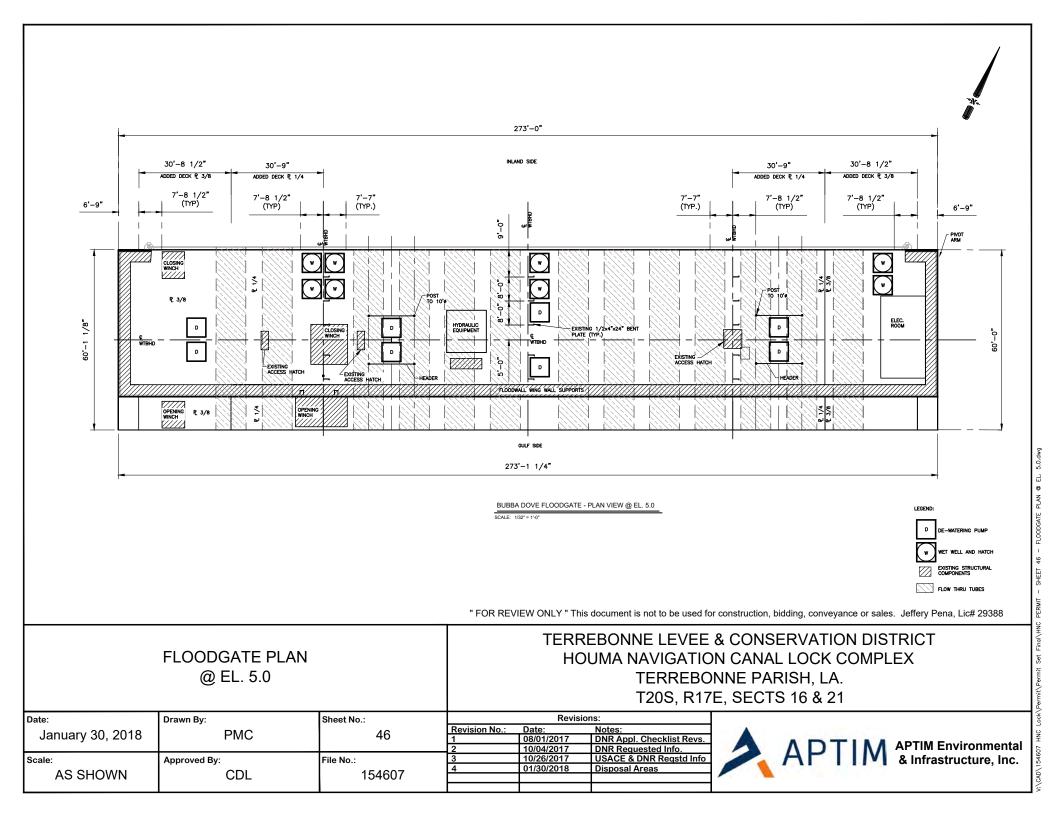


BUBBA DOVE FLOODGATE - ELEVATION VIEW

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#### FLOODGATE ELEVATION VIEW

	Date:	Drawn By:	Sheet No.:	Revisions:		
	January 20, 2010	DMC	47	Revision No.:	Date:	Notes:
	January 30, 2018	PMC	47	1	08/01/2017	DNR Appl. Checklist Revs.
				2	10/04/2017	DNR Requested Info.
	Scale:	Approved By:	File No.:	3	10/26/2017	USACE & DNR Regstd Info
	1"=40,000'	, CDI	154607	4	01/30/2018	Disposal Areas
		CDL				

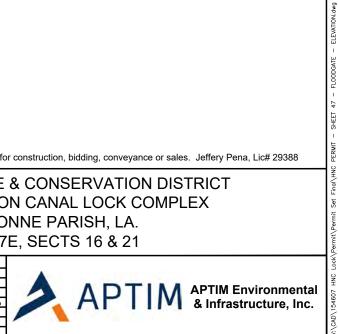

#### **GENERAL NOTES:**

Approximately 1,378,000 cubic yards of material will be dredged from the HNC and used to create a marsh platform, shown on Sheet 44.

Approximately 28,500 cubic yards of hauled in material will be used for the levee tie-in along with approximately 16,000 cubic yards of rip rap.

Approximately 220,000 cubic yards of rip rap and 2,400 cubic yards of concrete will be used for bankline stabilization and scour protection.

Approximately 500 cubic yards of hauled in material, 19,500 cubic yards of limestone, and 6,000 cubic yards of asphalt will be used for the access roads.

Approximately 8,600 cubic yards of hauled in material will be used to backfill the utility locations.

Approximately 5,000 cubic yards of dredged material from marina access canal.

Approximately 19.2 acres of wetlands will be impacted by this activity.

The existing 250' floodgate and floodwalls constructed under permit # MVN 2009-00559-WJJ and P 2009 0205 will be removed or incorporated into the proposed floodgate and lock complex.

The Dredge Material will be used beneficially to create approximately 245 Acres of Marsh Habitat with a 50 acre overflow area if needed Areas A and B will have partial containment.

" FOR REVIEW ONLY " This document is not to be used for construction, bidding, conveyance or sales. Jeffery Pena, Lic# 29388

#### **GENERAL NOTES**

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	Date:	Drawn By: Sheet No.:		Revisions:		
	June 2017	PMC	48	Revision No.:	Date:	Notes:
				1	08/01/2017	DNR Appl. Checklist Revs.
				2	10/04/2017	DNR Requested Info.
	Scale:	Approved By:	File No.:	3	10/26/2017	USACE & DNR Regstd Info
		••	454007	4	01/30/2018	Disposal Areas
	N.T.S.	CDL	154607			



Based on the Flood Closure Criteria from the Final RPEIS dated May 2013, the HNC Lock and Floodgate will be closed once a watch has been issued by the National Hurricane Center AND the stage measured at the gate location reaches +2.5 ft NAVD88. The gates can only be reopened once the watch has been discontinued AND the stages on the differential between the interior water level and exterior water level is equal to or less than the +1.0 feet as measured on the upstream and downstream staff gage AND the channel has been cleared of obstructions.

#### SALINITY CONTROL:

The HNC Lock and floodgate would be closed for salinity only if:

- 1. Flows in the Atchafalaya River are below 100,000 cfs as measured at Simmesport gage (USGS 07381490) or
- 2. If a gage on the outside of the Lock Complex exceeds a salinity value that has been correlated with preventing exceedance of the maximum allowable chloride level of 250 ppm. The structure should be closed for at least 12 hours and fluctuations in chloride levels should be monitored and recorded hourly.

The HNC Lock complex may be opened when all of the following criteria have been met:

1. After monitoring chloride levels over the 12 hour period at the new gage on the outside of the Lock complex drops below the salinity closure trigger.

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#### OPERATION PLAN

TERREBONNE LEVEE & CONSERVATION DISTRICT HOUMA NAVIGATION CANAL LOCK COMPLEX TERREBONNE PARISH, LA. T20S, R17E, SECTS 16 & 21

	Date:	Drawn By:	Sheet No.:	Revisions:		
	luna 2017	DMC	40	Revision No.:	Date:	Notes:
	June 2017	PMC	49	1	08/01/2017	DNR Appl. Checklist Revs.
				2	10/04/2017	DNR Requested Info.
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