

DEPARTMENT OF THE ARMY U.S. ARMY CORPS OF ENGINEERS, NEW ORLEANS DISTRICT 7400 LEAKE AVE NEW ORLEANS, LA 70118-3651

JOINT PUBLIC NOTICE

April 4, 2022

United States Army Corps of Engineers New Orleans District Attn: Regulatory Division, RGW 7400 Leake Ave. New Orleans, Louisiana 70118-3651

Project Manager: James W. Little, Jr. (504) 862-1879 james.little@usace.army.mil Application #: MVN-2008-03027-WII State of Louisiana Department of Environmental Quality Attn: Water Quality Certifications Post Office Box 4313 Baton Rouge, Louisiana 70821-4313

Project Manager: Elizabeth Hill (225) 219-3225 WQC Application Number: WQC-210255-01

Interested parties are hereby notified that a permit application has been received by the New Orleans District of the U.S. Army Corps of Engineers pursuant to: [X] Section 10 of the Rivers and Harbors Act of March 3, 1899 (30 Stat. 1151; 33 USC 403); and/or [X] Section 404 of the Clean Water Act (86 Stat. 816; 33 USC 1344).

The application has also been mailed to the Louisiana Department of Environmental Quality, for a Water Quality Certification (WQC) in accordance with statutory authority contained in Louisiana Revised Statute 30:2074 A(3), and provisions of Section 401 of the Clean Water Act (P.L. 95-17).

CONSTRUCT, OPERATE AND MAINTAIN A NEW NATURAL GAS SALT DOME STORAGE FACILITY AND ASSOCIATED STRUCTURES IN CAMERON AND CALCASIEU PARISHES

NAME OF APPLICANT: LA Storage, LLC, c/o T. Baker Smith, LLC, Attn: Mr. Brady Trahan, 107 Global Circle, Lafayette, Louisiana 70503.

LOCATION OF WORK: In Cameron and Calcasieu Parish, Brine Pipeline POB 30.002958, -93.41655; POE 30.059283, -93.3488; located off of Black Lake Road, west of Hackberry, Louisiana, as shown on the attached drawings. (Hydrologic Unit Code 08080206, Lower Calcasieu Watershed)

CHARACTER OF WORK: Construct, operate and maintain a new natural gas salt dome storage facility. The Project will involve the conversion of three existing salt dome caverns to natural gas storage service and the development of one new salt dome cavern for additional natural gas storage service. In addition, the applicant will construct and operate on-site compression facilities (Pelican Compressor Station), approximately 5.2 miles of 42-inch-diameter bi-directional natural gas pipeline, and

approximately 6.6 miles of 16-inch-diameter brine disposal pipeline. Approx. 251,725 cubic yards of material will be displaced by dredging operations and 316,572 cubic yards of fill material will be brought on site. Approximately 70.24 acres of wet pasture, 0.08 of an acre of fresh marsh, 53.22 acres of intermediate marsh, 3.68 acres of brackish marsh, 9.97 acres of scrub-shrub wetlands, 5.80 acres of bottomland hardwoods, and 166.98 acres of jurisdictional waters would be impacted by proposed activities. Should a DA permit be warranted, the applicant proposes to purchase compensatory mitigation credits at CEMVN approved mitigation banks in the area.

The comment period on the requested Department of the Army Permit and the Louisiana Department of Environmental Quality WQC will close 20 days from the date of this public notice. Written comments, including suggestions for modifications or objections to the proposed work, stating reasons thereof, are being solicited from anyone having interest in this permit request, and must be submitted so as to be received before or by the last day of the comment period. Letters and/or comments concerning the subject permit application must reference the Applicant's Name and the Permit Application Number and can be preferably emailed to the Corps of Engineers project manager listed above or forwarded to the Corps of Engineers at the address above, ATTENTION: REGULATORY DIVISION, RGW, JAMES W. LITTLE, JR. Individuals or parties may also request an extension of time in which to comment on the proposed work by mail or preferably by emailing the specified project manager listed above. Any request for an extension of time to comment must be specific and substantively supportive of the requested extension and received by this office prior to the end of the initial comment period. The Branch Chief will review the request and the requestor will be promptly notified of the decision to grant or deny the request. If granted, the time extension will be continuous and inclusive of the initial comment period and will not exceed a total of 30 calendar days. Letters concerning the Water Quality Certification must reference the applicant's name and the WQC Application number and be mailed to the Louisiana Department of Environmental Quality at the address above.

The application for this proposed project is on file with the Louisiana Department of Environmental Quality and may be examined during weekdays between 8:00 a.m. and 4:30 p.m. Copies may be obtained upon payment of costs of reproduction.

Corps of Engineers Permit Criteria

The decision whether to issue a permit will be based on an evaluation of the probable impacts, including cumulative impacts of the proposed activity on the public interest. That decision will reflect the national concern for both protection and utilization of important resources. The benefit which reasonably may be expected to accrue from the proposal must be balanced against its reasonably foreseeable detriments. All factors which may be relevant to the proposal will be considered including the cumulative effects thereof; among those are conservation, economics, aesthetics, general environmental concerns, wetlands, historic properties, fish and wildlife values, flood hazards, floodplain values, land use, navigation, shoreline erosion and accretion, recreation, water supply and conservation, water quality, energy needs, safety, food and

fiber production, mineral needs, considerations of property ownership and, in general, the needs and welfare of the people.

The U.S. Army Corps of Engineers is soliciting comments from the public, federal, state, and local agencies and officials, Indian Tribes, and other interested parties in order to consider and evaluate the impacts of this proposed activity. Any comments received will be considered by the U.S. Army Corps of Engineers to determine whether to make, modify, condition, or deny a permit for this proposal. To make this decision, comments are used to assess impacts on endangered species, historic properties, water quality, general environmental effects, and other public interest factors listed above. Comments are used in the preparation of an Environmental Assessment and/or an Environmental Impact Statement pursuant to the National Environmental Policy Act. Comments are also used to determine the need for a public hearing and to determine the overall public interest of the proposed activity.

The possibility exists that the proposed work may damage or destroy presently unknown archeological, scientific, prehistorical, historical sites, or data. As deemed necessary, copies of this public notice will be sent to the State Archeologist, State Historic Preservation Officer and federally listed tribes regarding potential impacts to cultural resources.

Our initial finding based on the Information Planning and Consultation (IPaC) tool for Endangered Species in Louisiana, as signed on January 27, 2020, between the U.S. Army Corps of Engineers, New Orleans and the U.S. Fish and Wildlife Service, the proposed project was evaluated under the determination key on 3 December 2020 and it has been determined that the proposed project is "Not likely to adversely Affect" the West Indian Manatee (*Trichechus manatus*) and the Eastern Black Rail (*Laterallus jamaicensis ssp.*), the project will have "No Effect" on the Red Cockaded Woodpecker (*Picoiodes borealis*), Green Sea Turtle (*Chelonia mydas*), Hawksbill Sea Turtle (*Eretmochelys imbricata*), Kemp's Ridley Sea Turtle (*Lepidochelys kempii*), Leatherback Sea Turtle (*Dermochelys coriacea*), and Loggerhead Sea Turtle (*Caretta caretta*). The Standard Manatee Conditions for in-water activities shall be included as permit conditions if a Department of the Army permit is issued.

This notice initiates the Essential Fish Habitat (EFH) consultation requirements of the Magnuson-Stevens Fishery Conservation and Management Act. The applicant's proposal may result in the destruction, alteration, and/or disturbance of **223.96 acres** of EFH utilized by various life stages of red drum and penaeid shrimp. Our initial determination is that the proposed action would not have a substantial adverse impact on EFH or federally managed fisheries in the Gulf of Mexico. Our final determination relative to project impacts and the need for mitigation measures is subject to review by and coordination with the National Marine Fisheries Service.

If the proposed work involves deposits of dredged or fill material into navigable waters, the evaluation of the probable impacts will include the application of guidelines established by the Administrator of the Environmental Protection Agency. Also, a certification that the proposed activity will not violate applicable water quality standards will be required from the LA Department of Environmental Quality before a Department of the Army permit can be issued.


Any person may request, (preferably by email to the project manager, or in writing), within the comment period specified in this notice, that a public hearing be held to consider this application. Requests for public hearings shall state, with particularity, the reasons for holding a public hearing.


The applicant has certified that the proposed activity described in the application complies with and will be conducted in a manner that is consistent with the Louisiana Coastal Resources Program. The Department of the Army permit will not be issued unless the applicant receives approval or a waiver of the Coastal Use Permit by the Louisiana Department of Natural Resources-Office of Coastal Management.


You are invited to communicate the information contained in this notice to any other parties whom you deem likely to have interest in the matter.


Darrell S. Barbara Chief, Western Evaluation Branch Regulatory Division


Enclosure

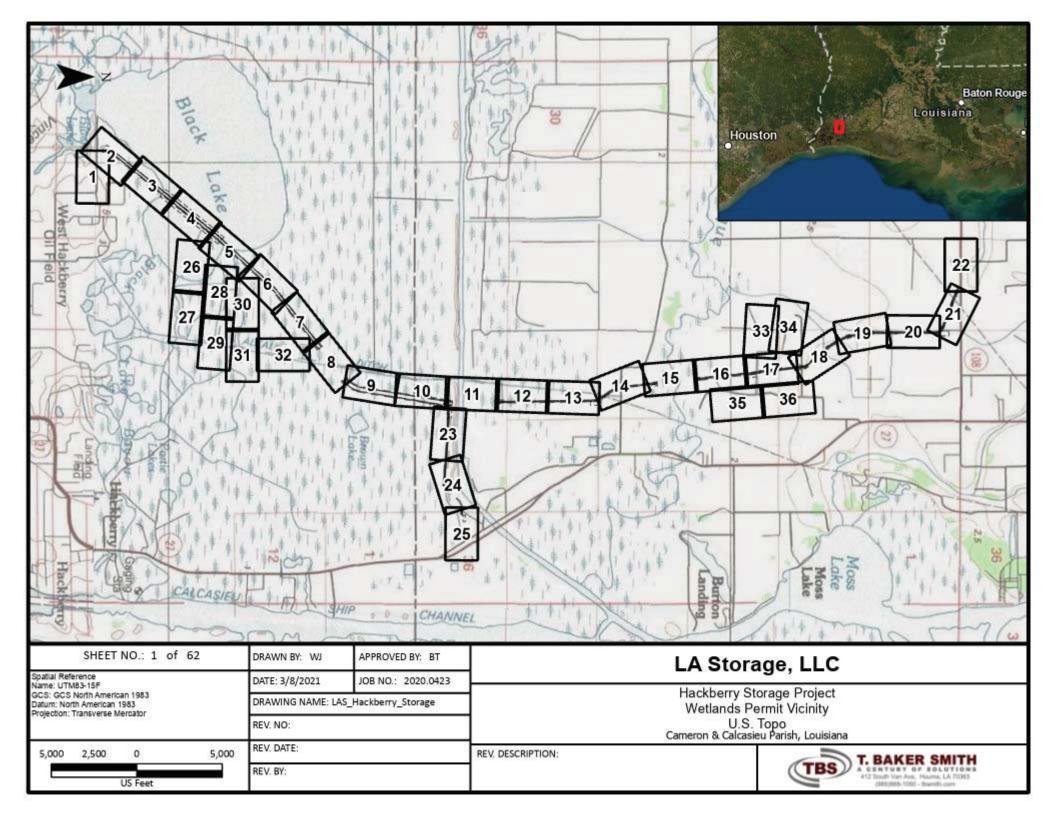


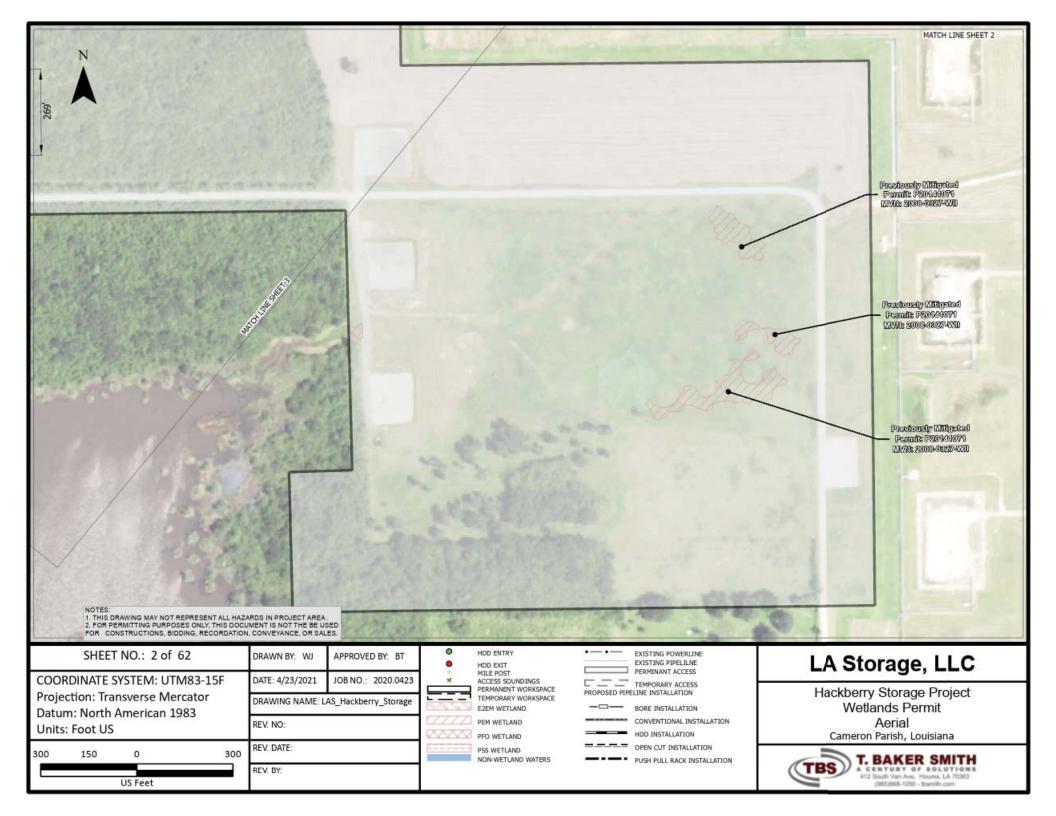


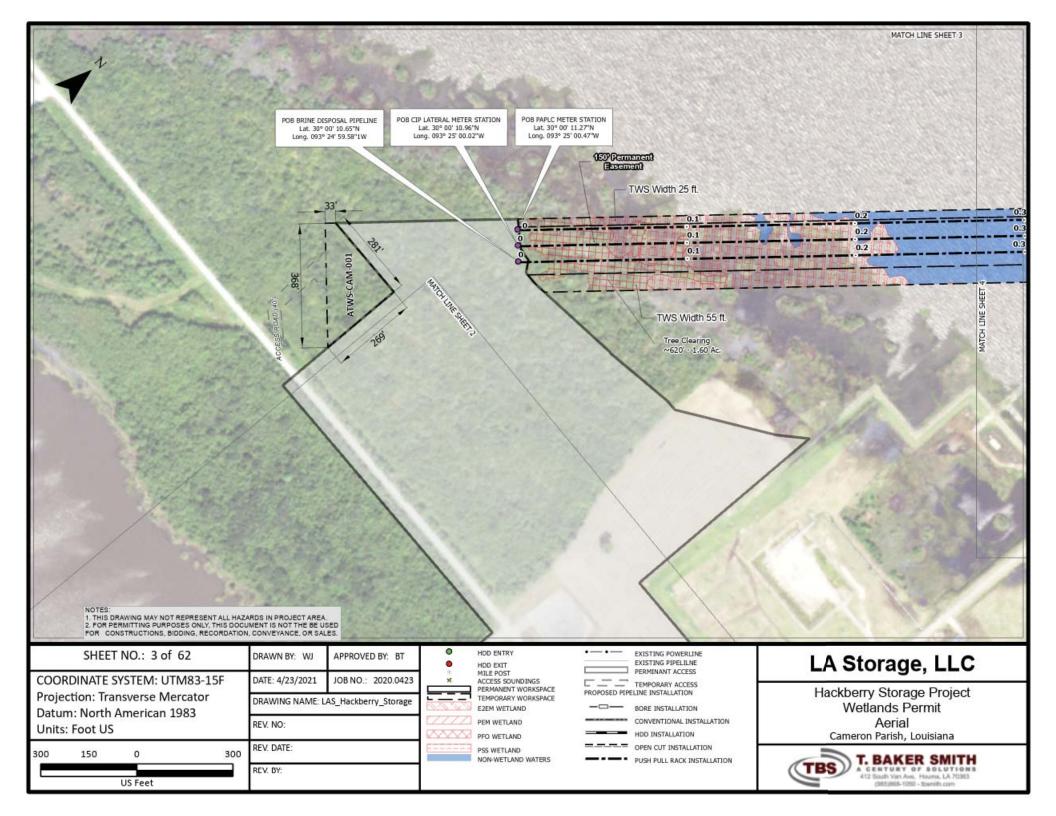


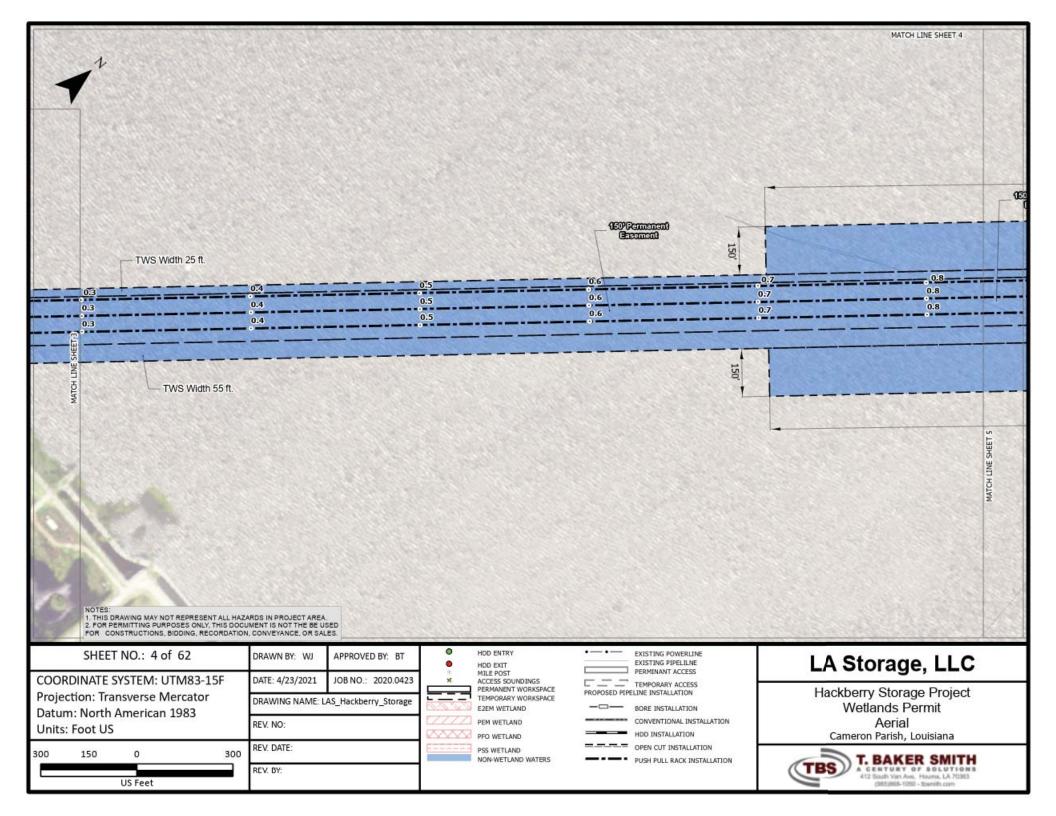


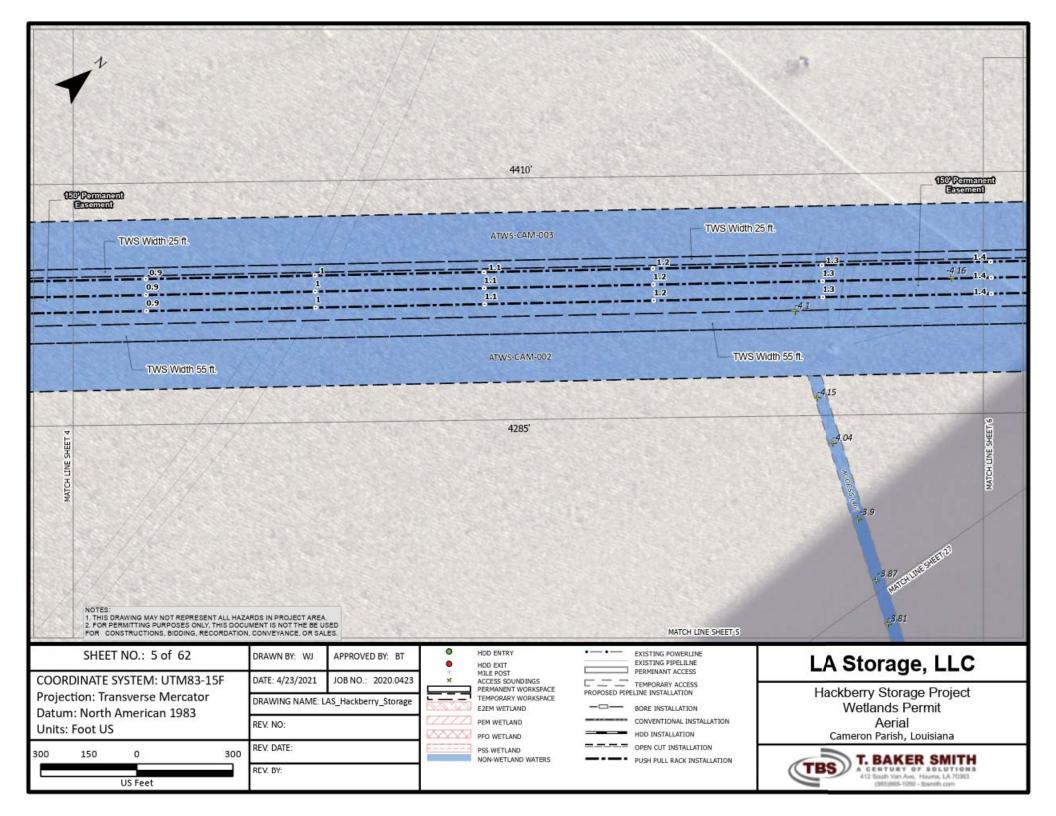


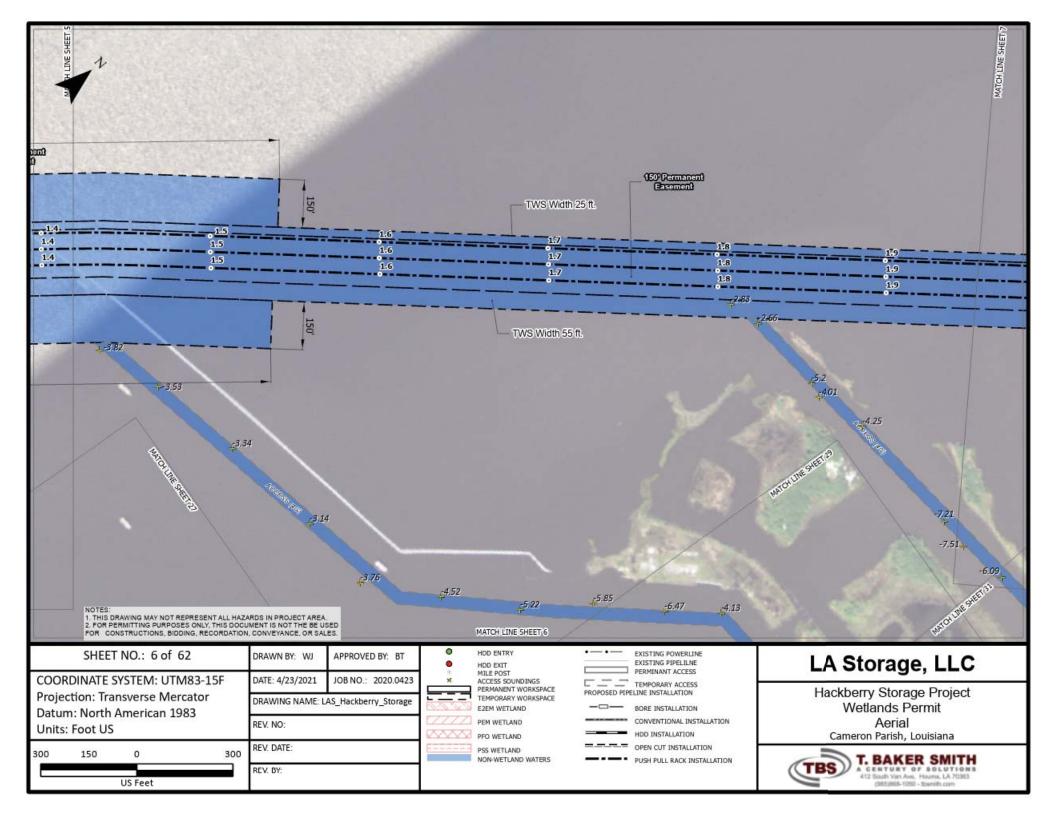


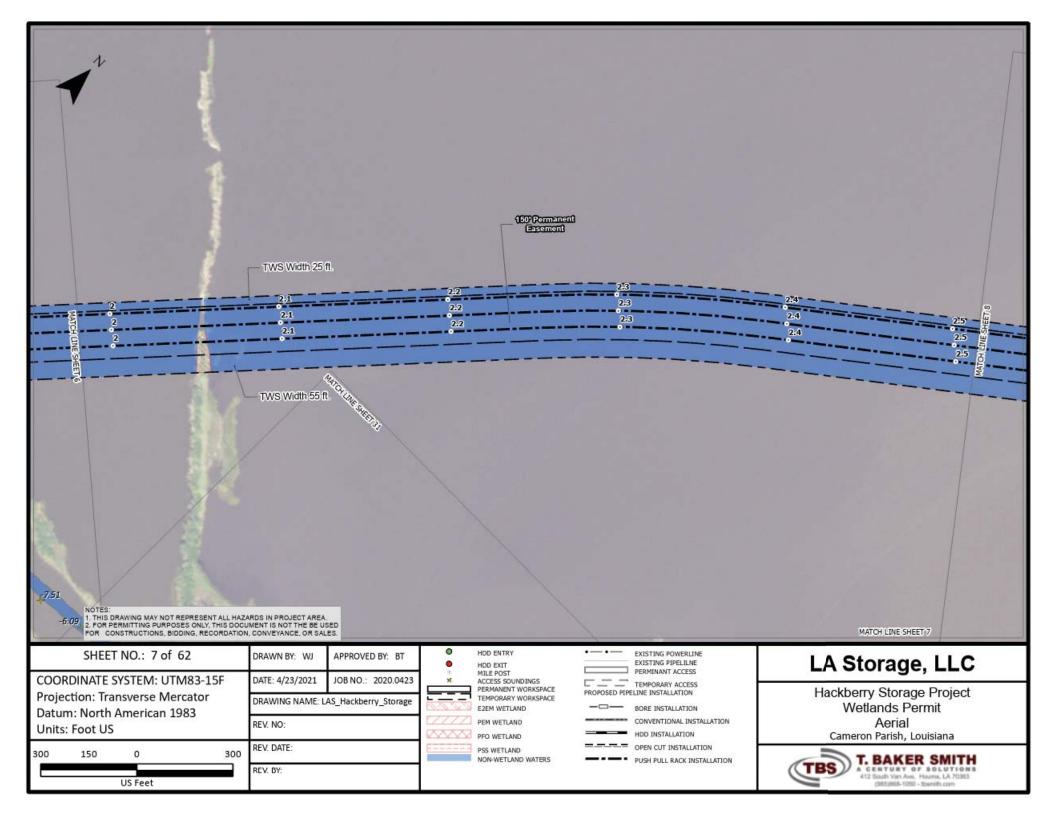


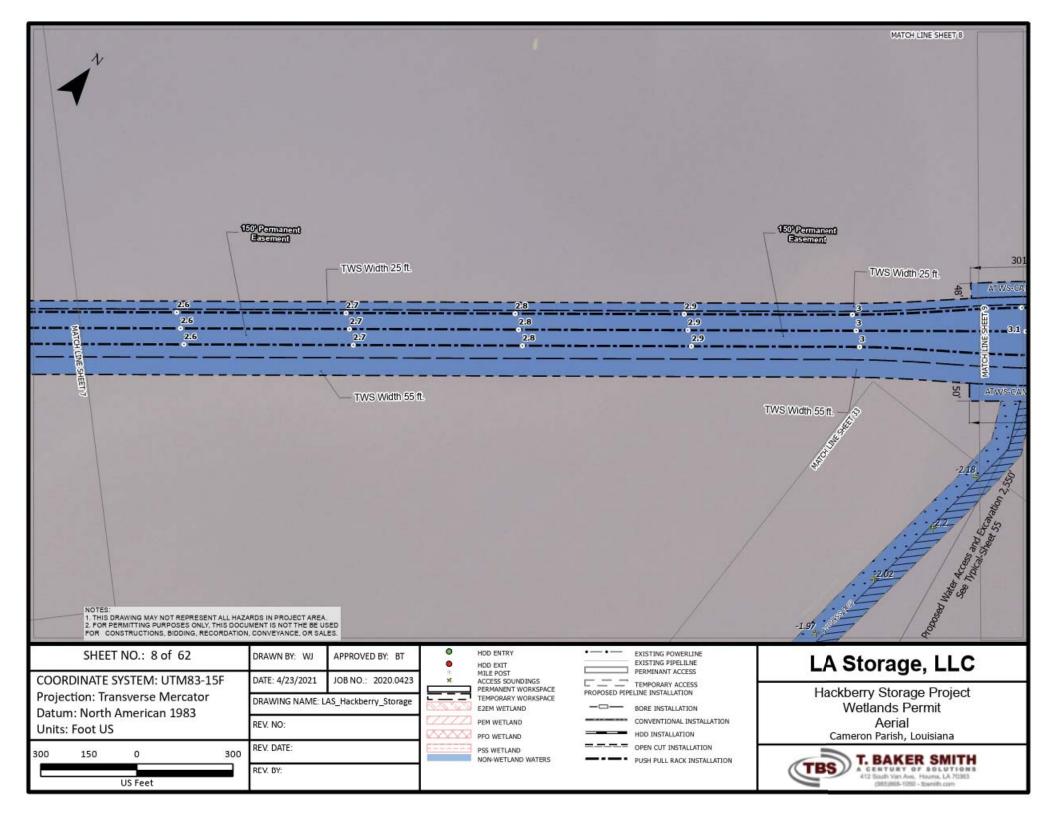


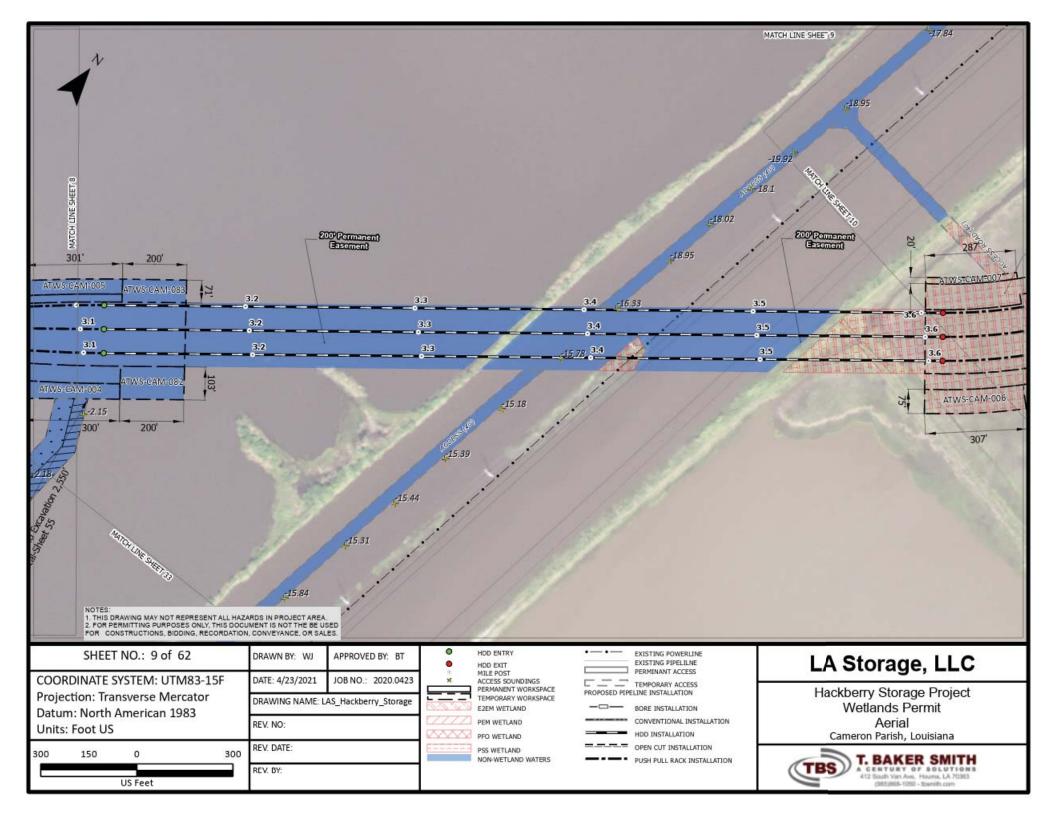


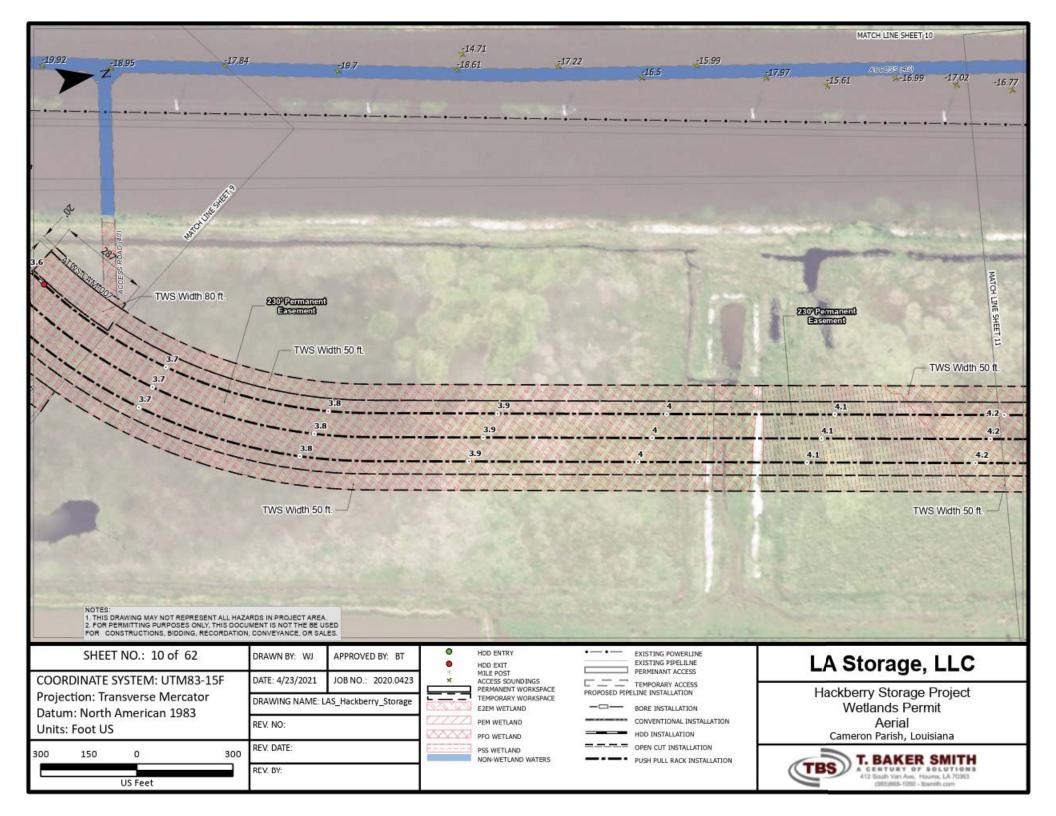


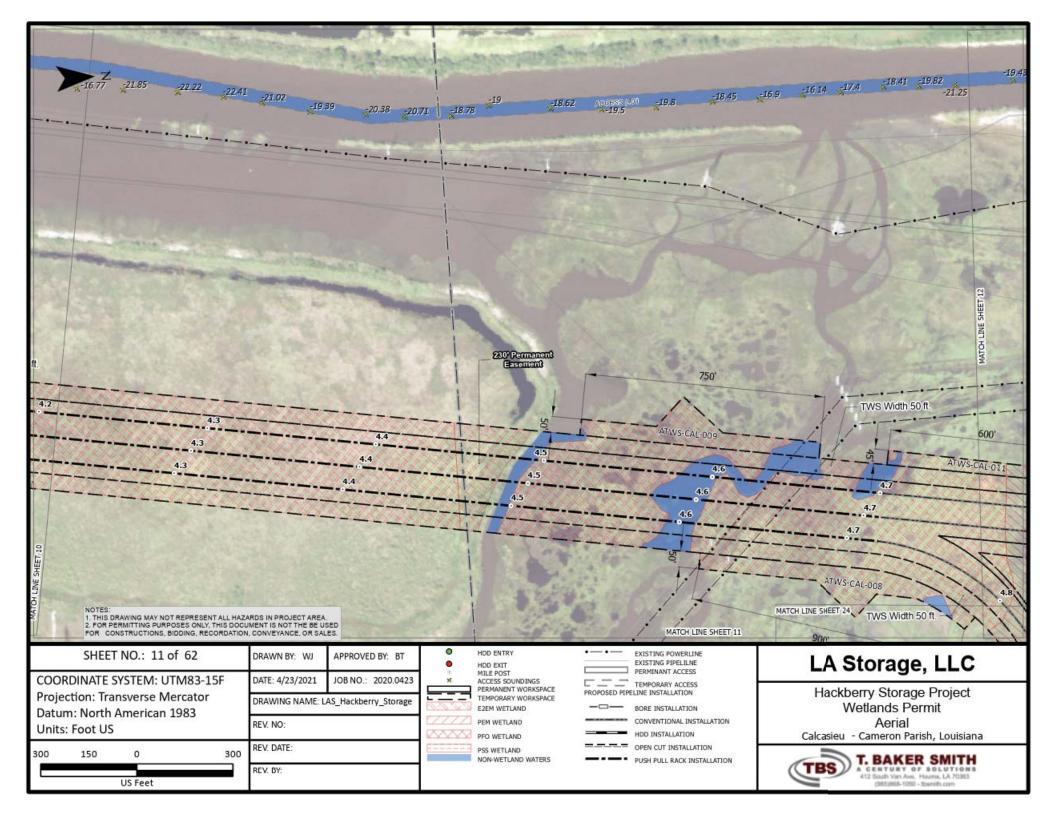


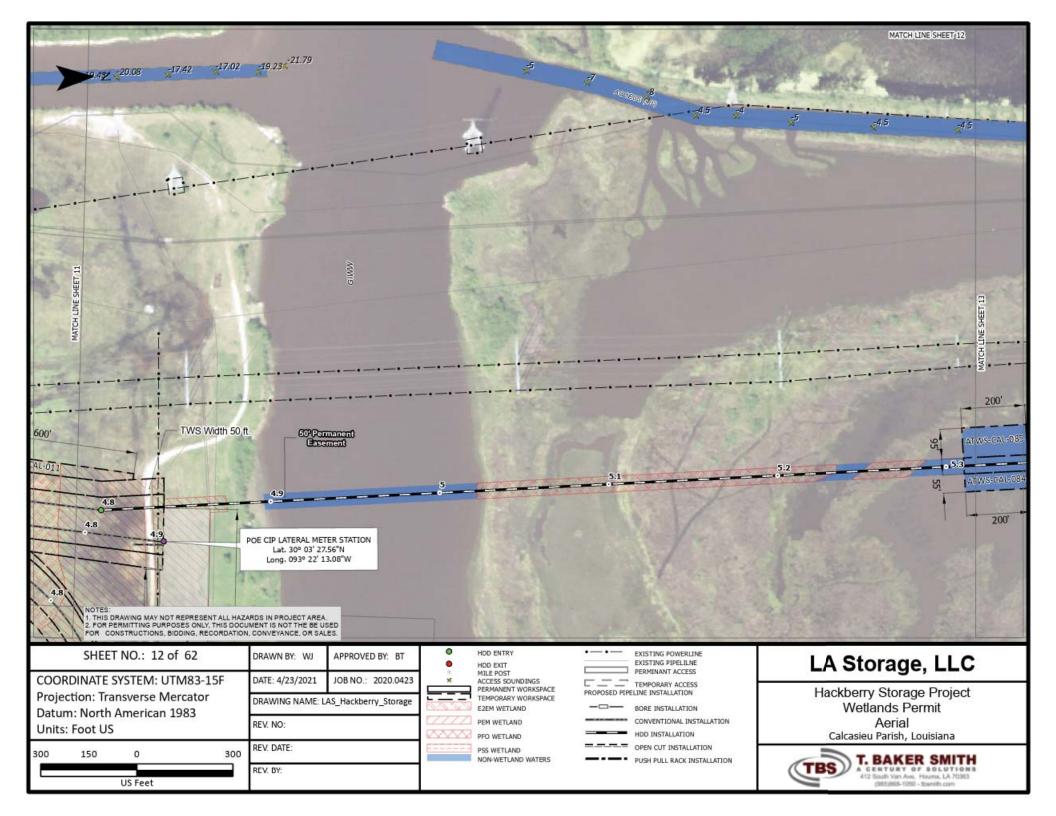


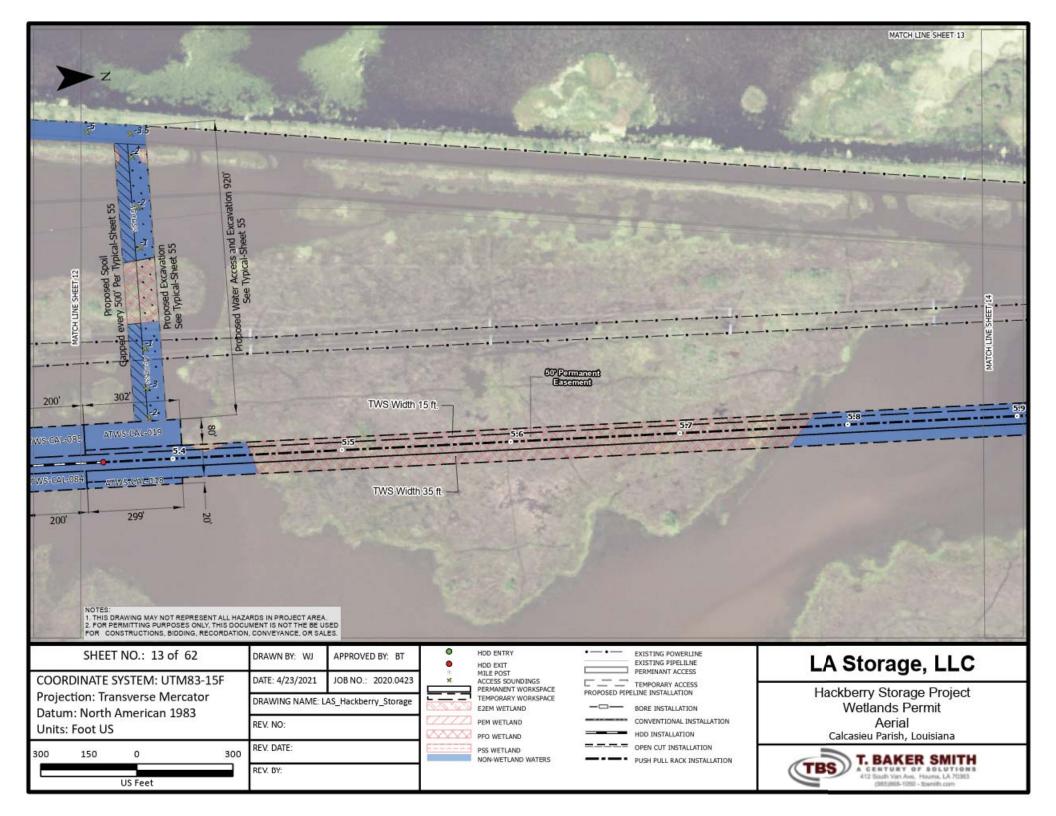


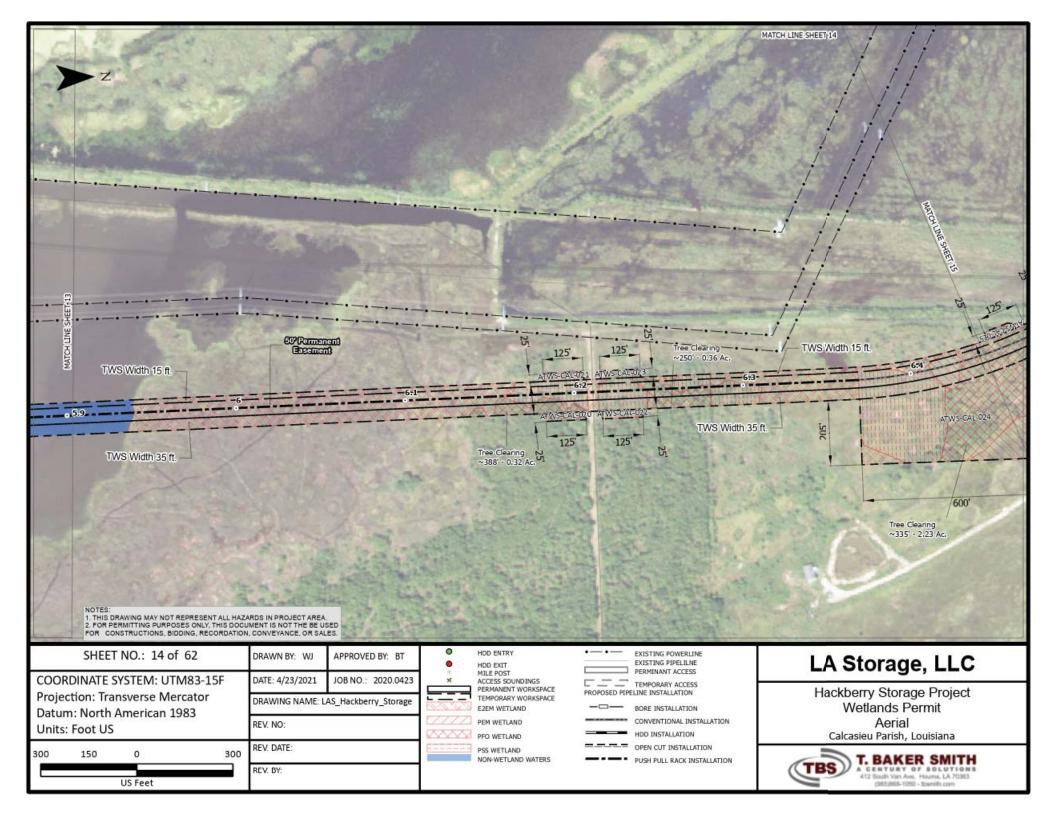


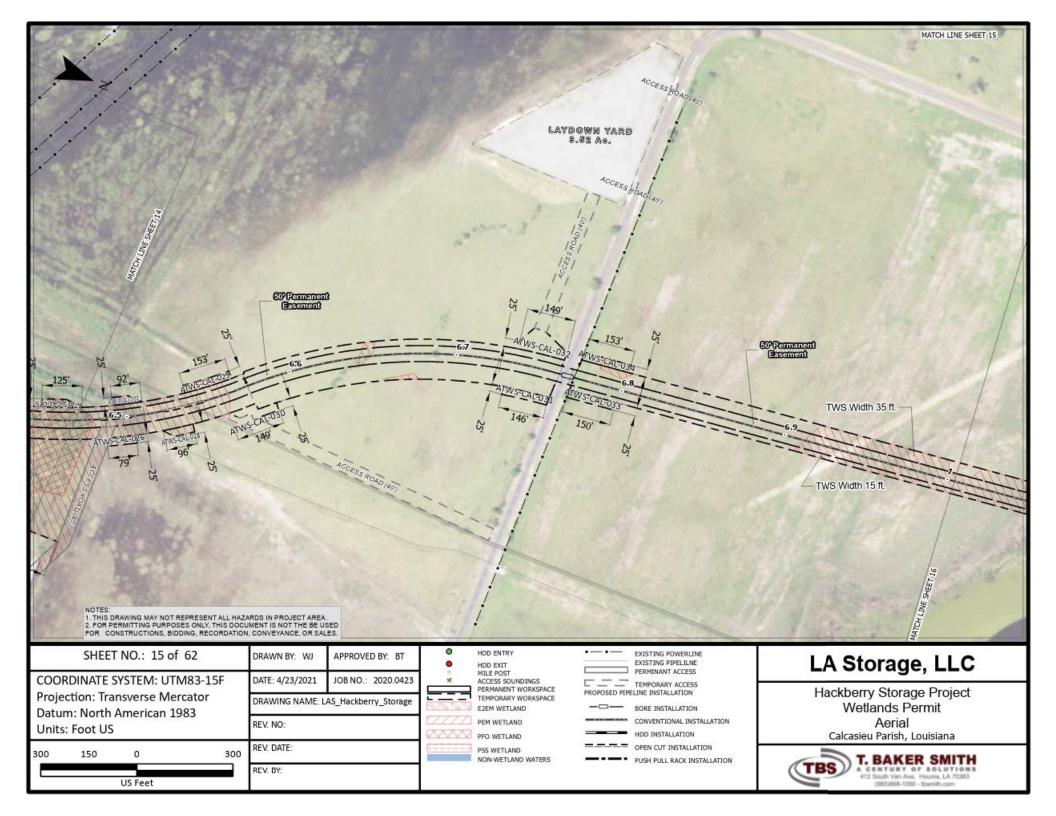


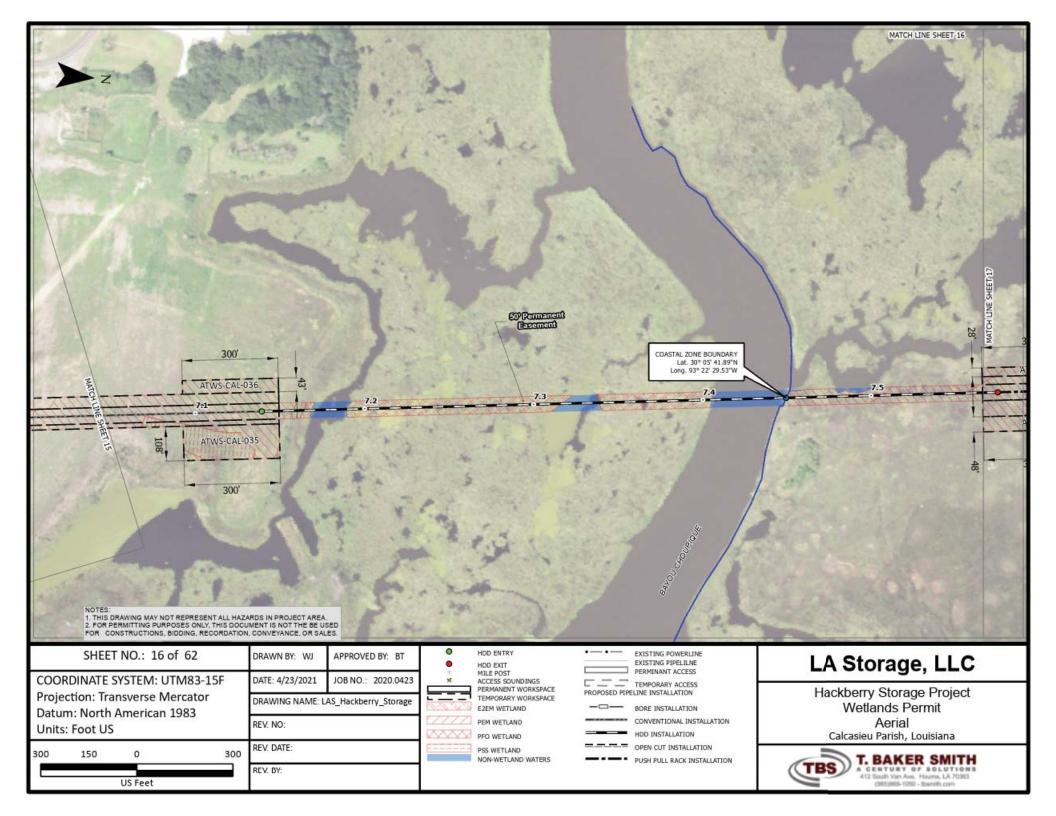


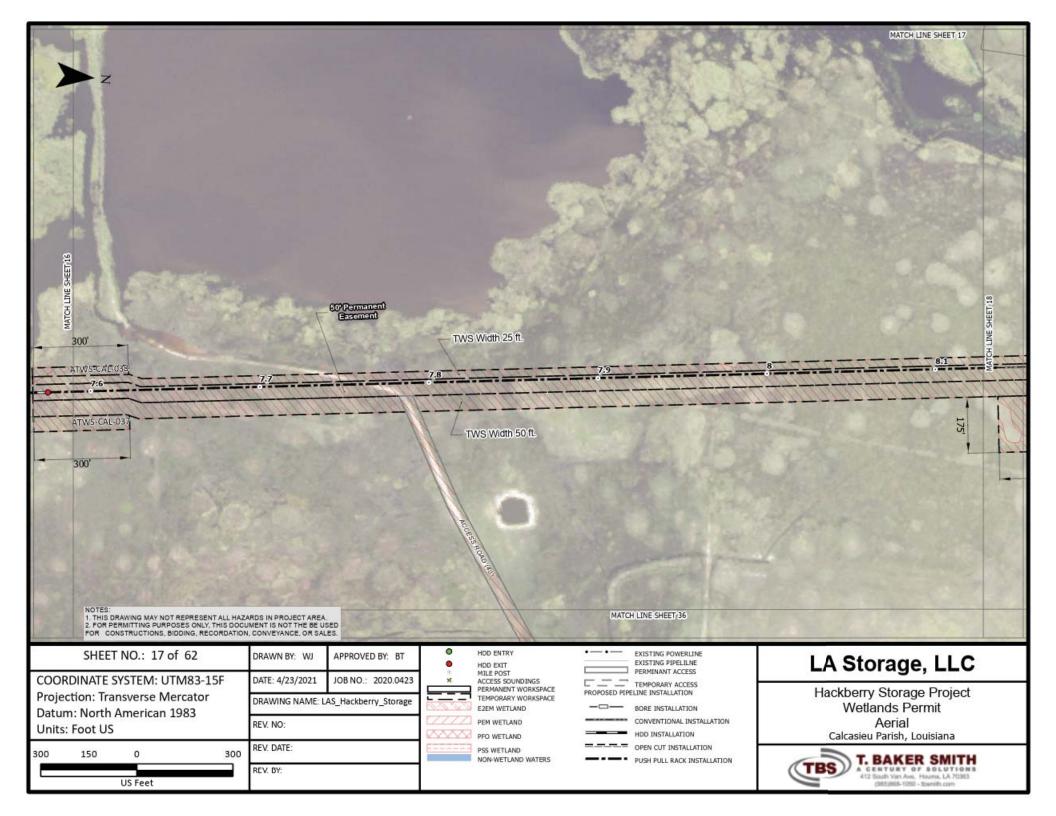


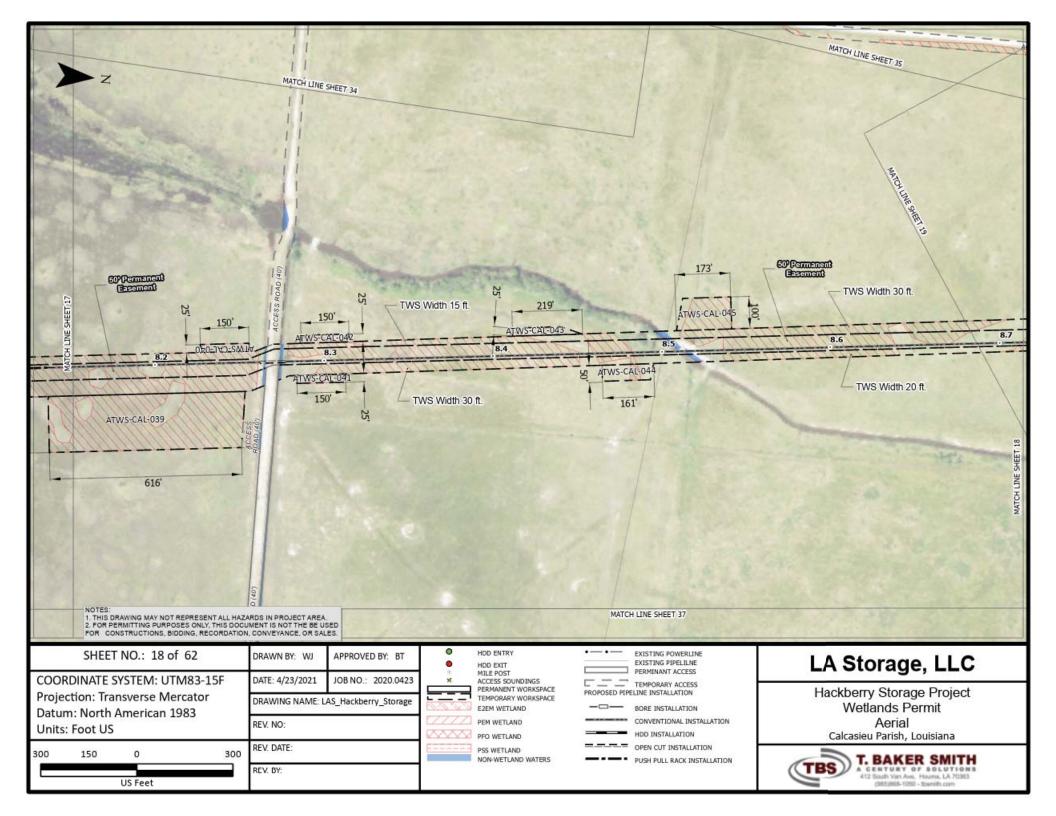


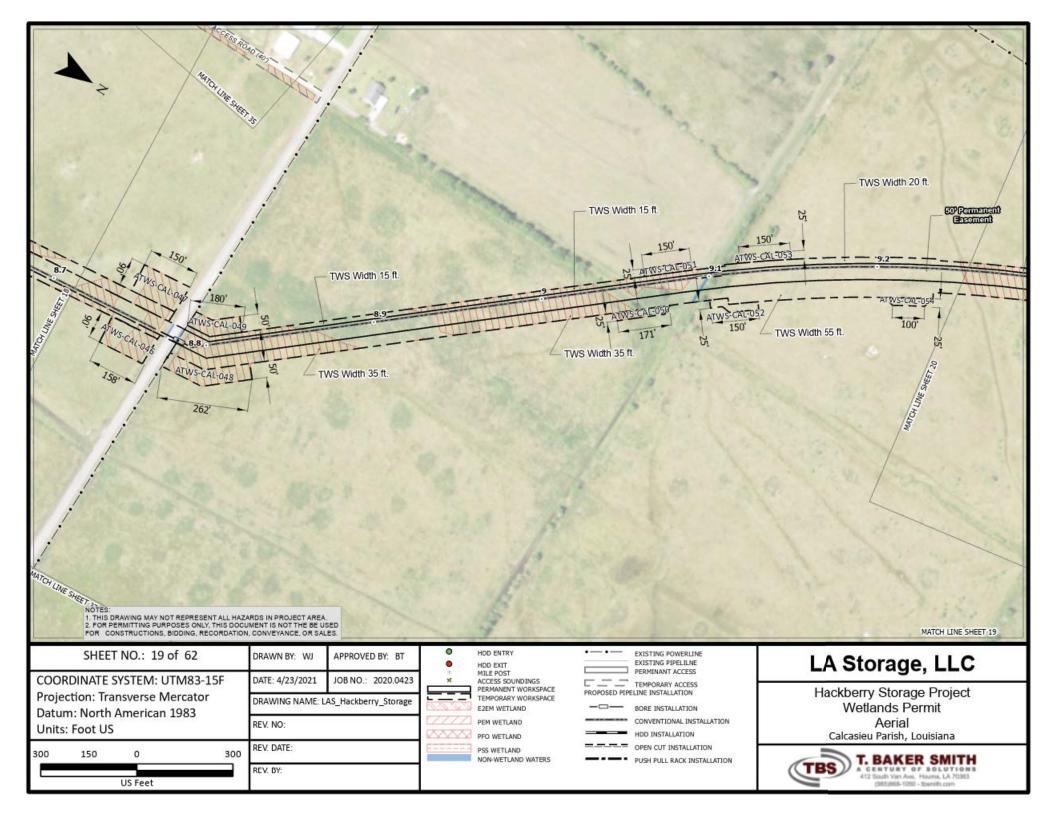


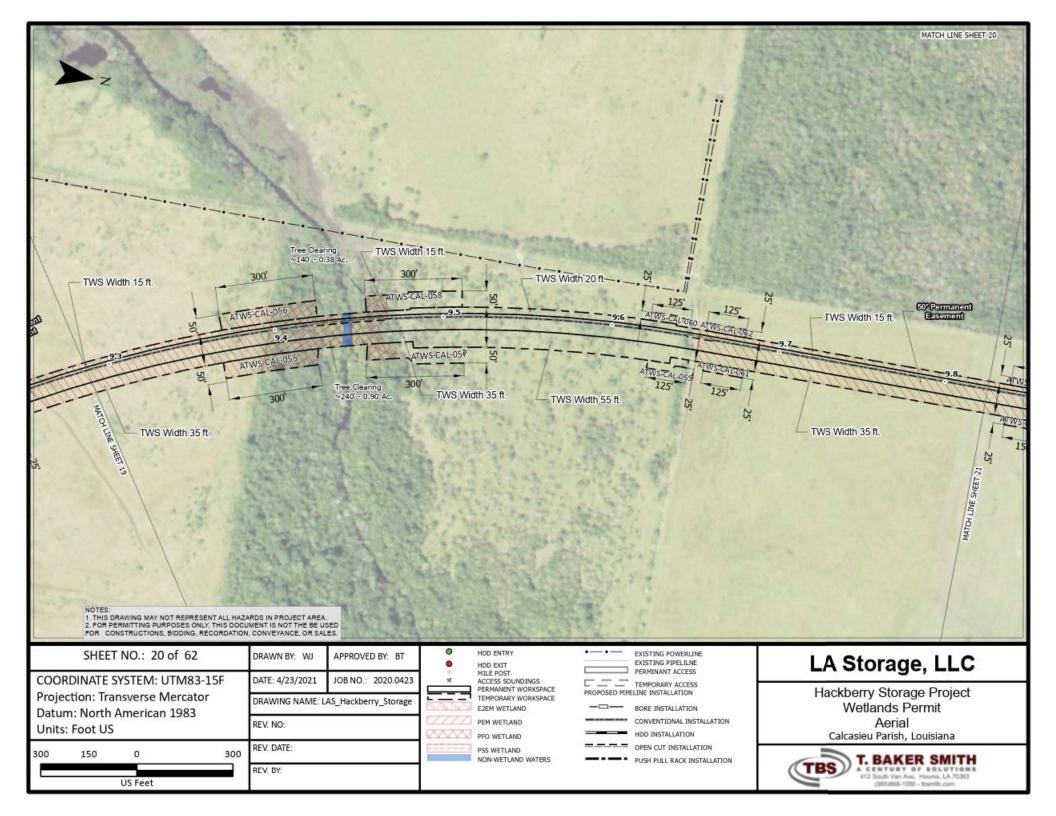


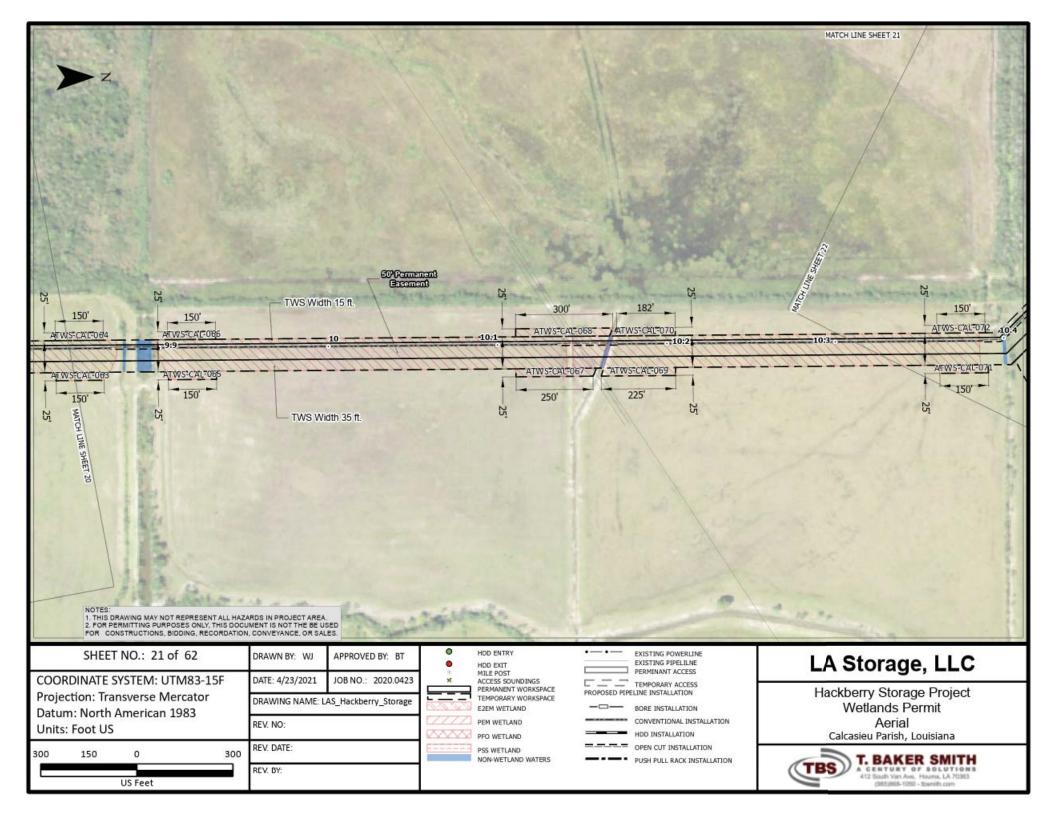


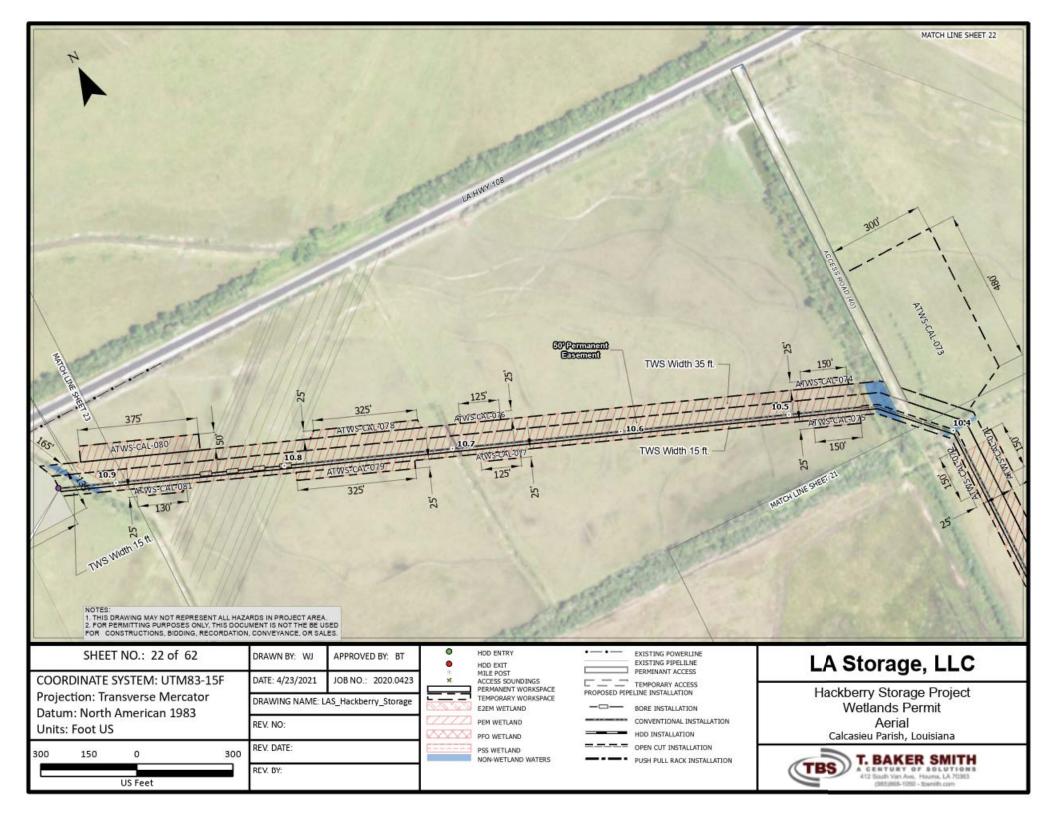


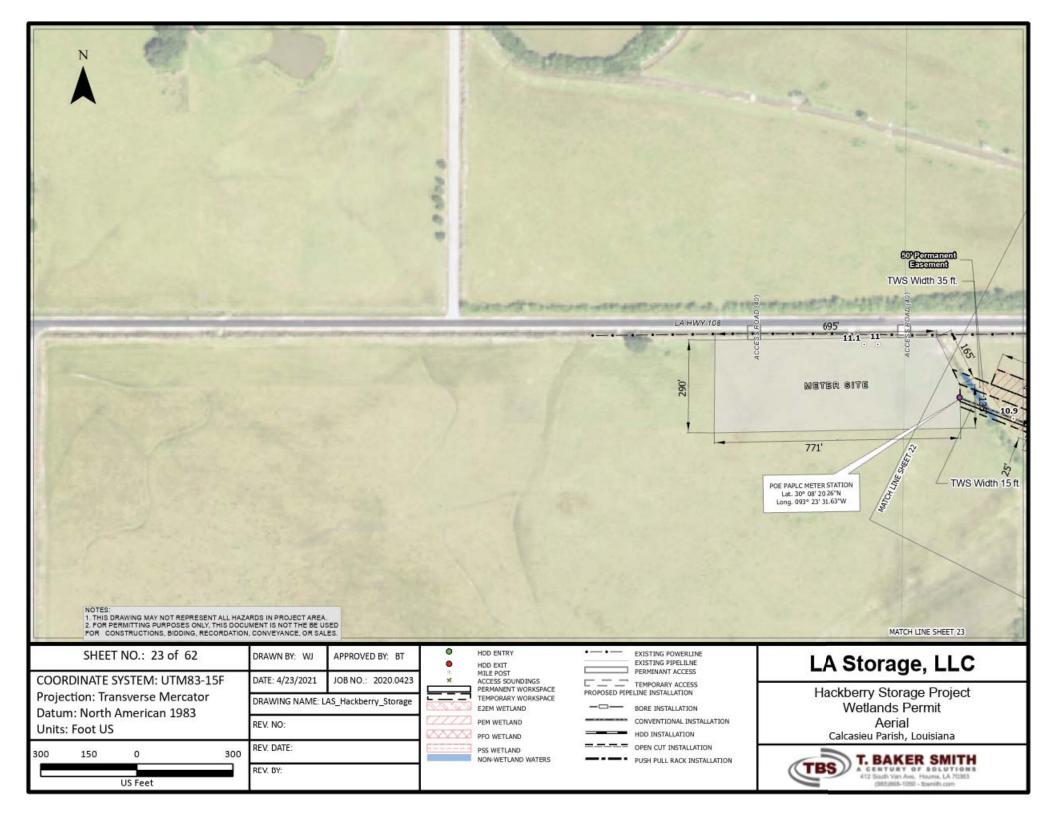


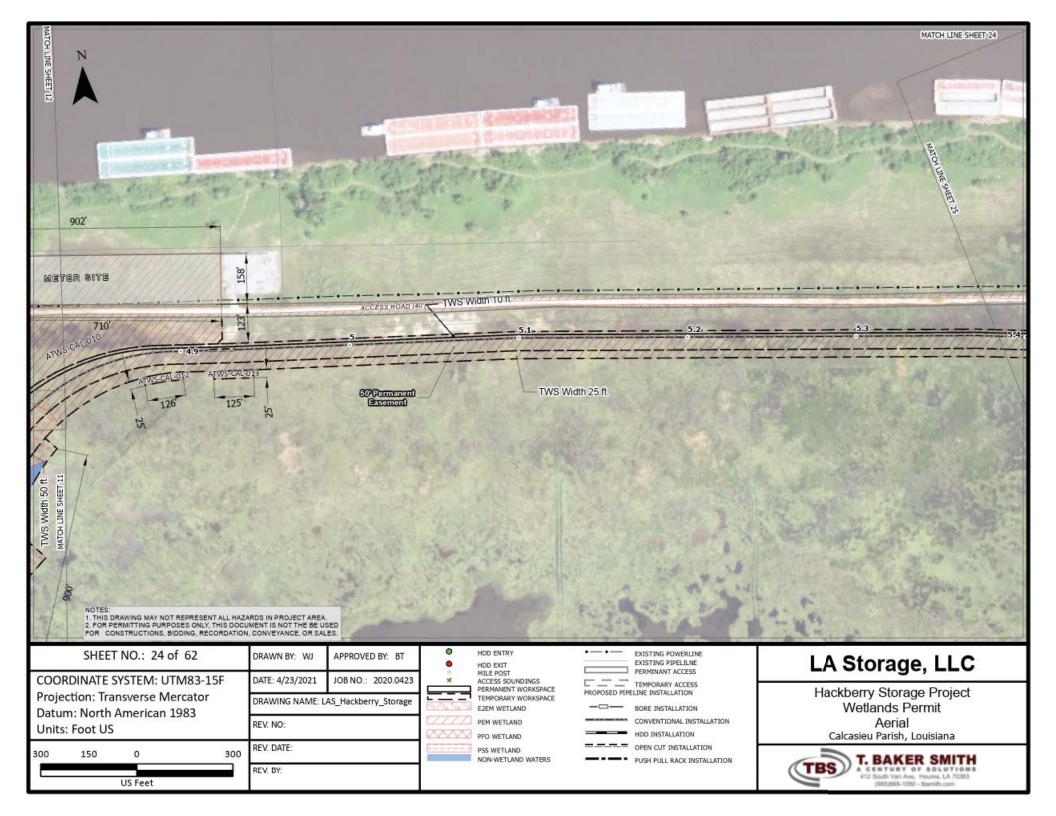


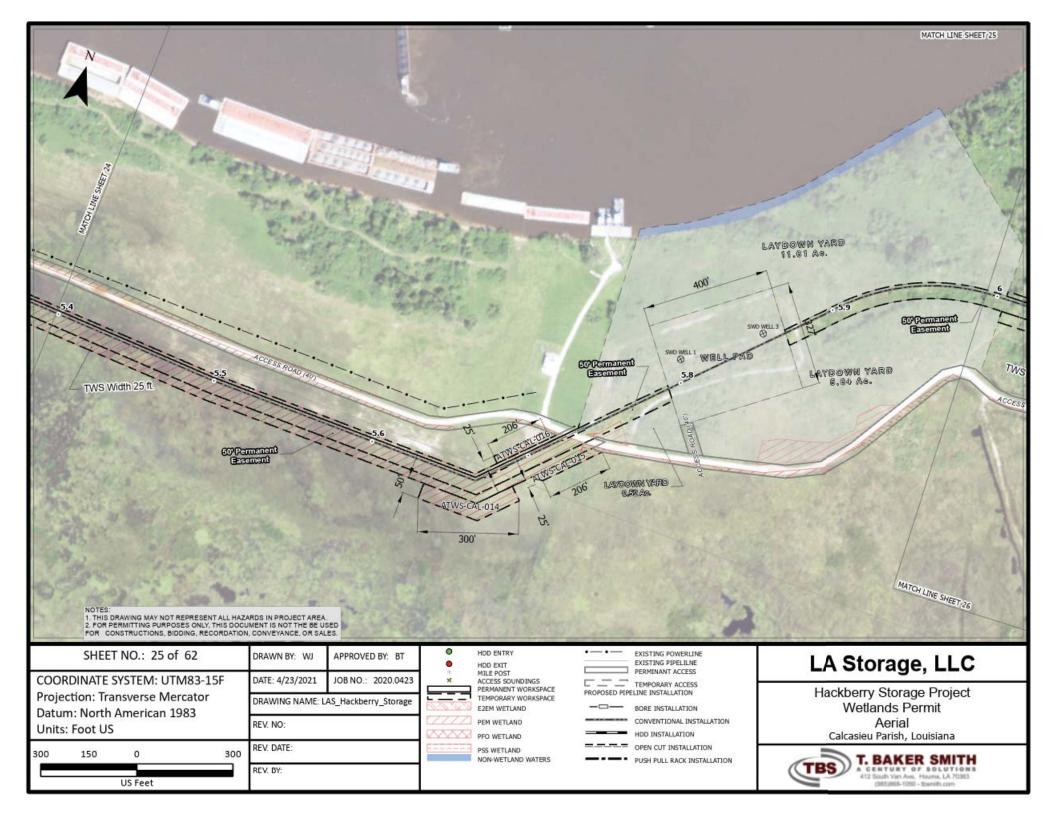


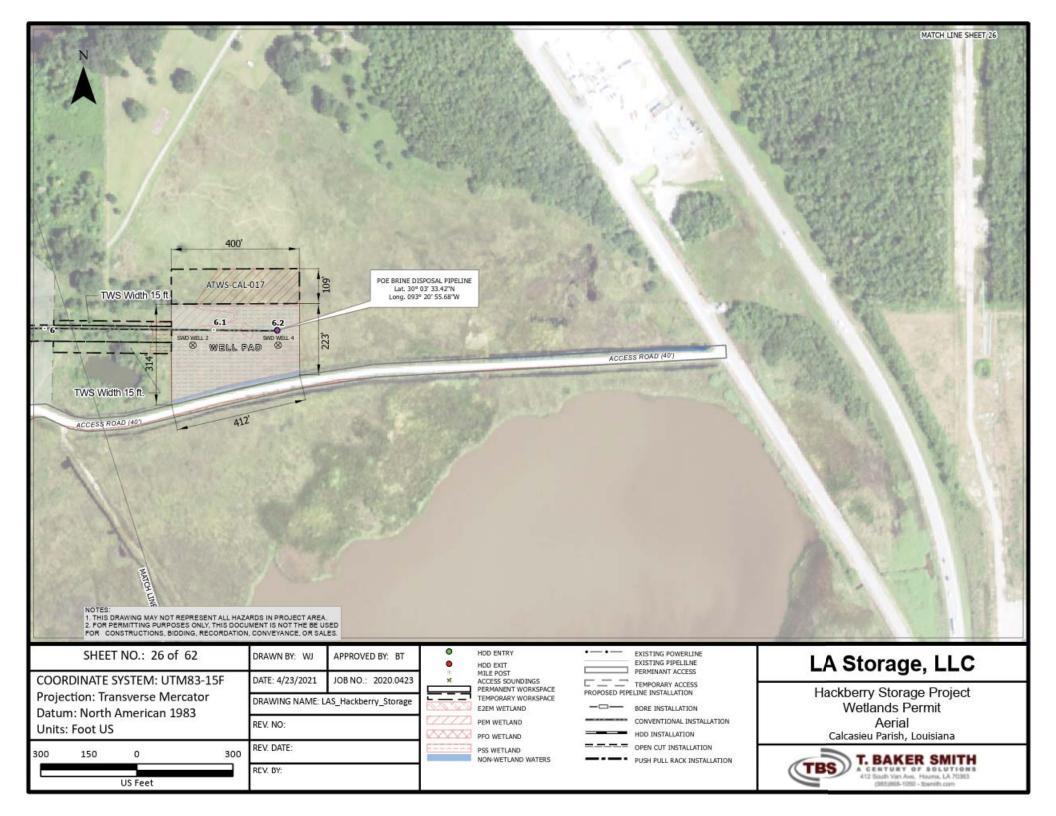


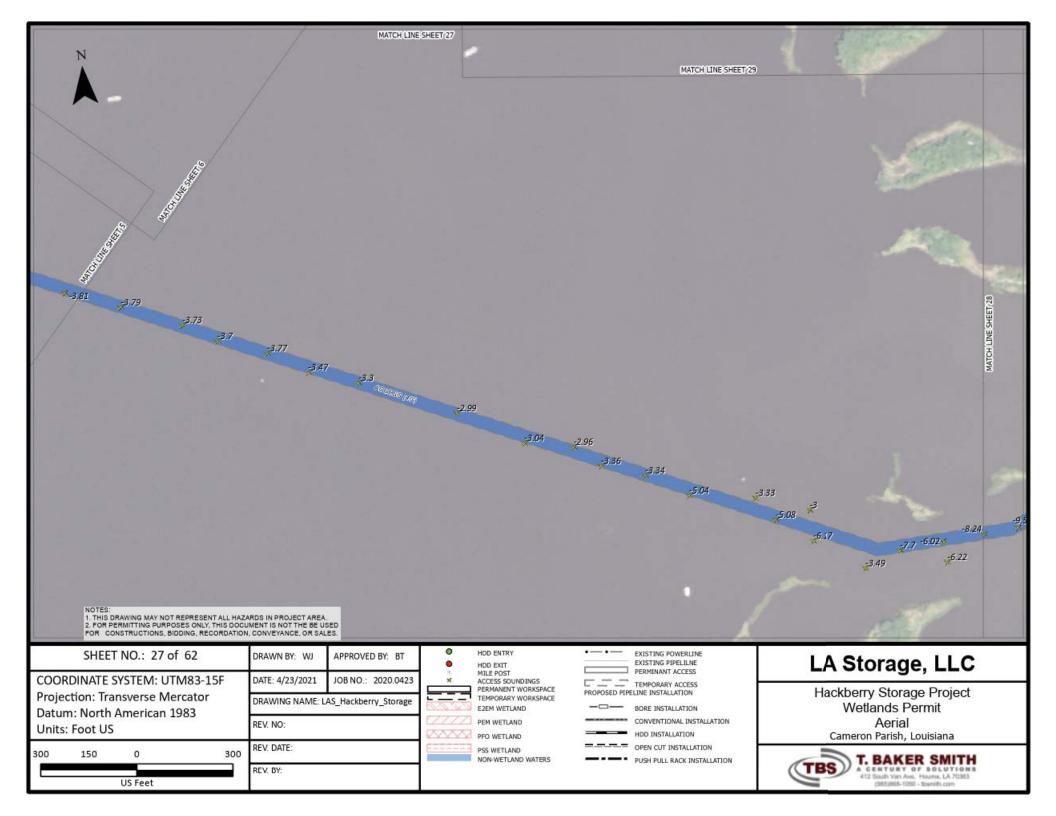


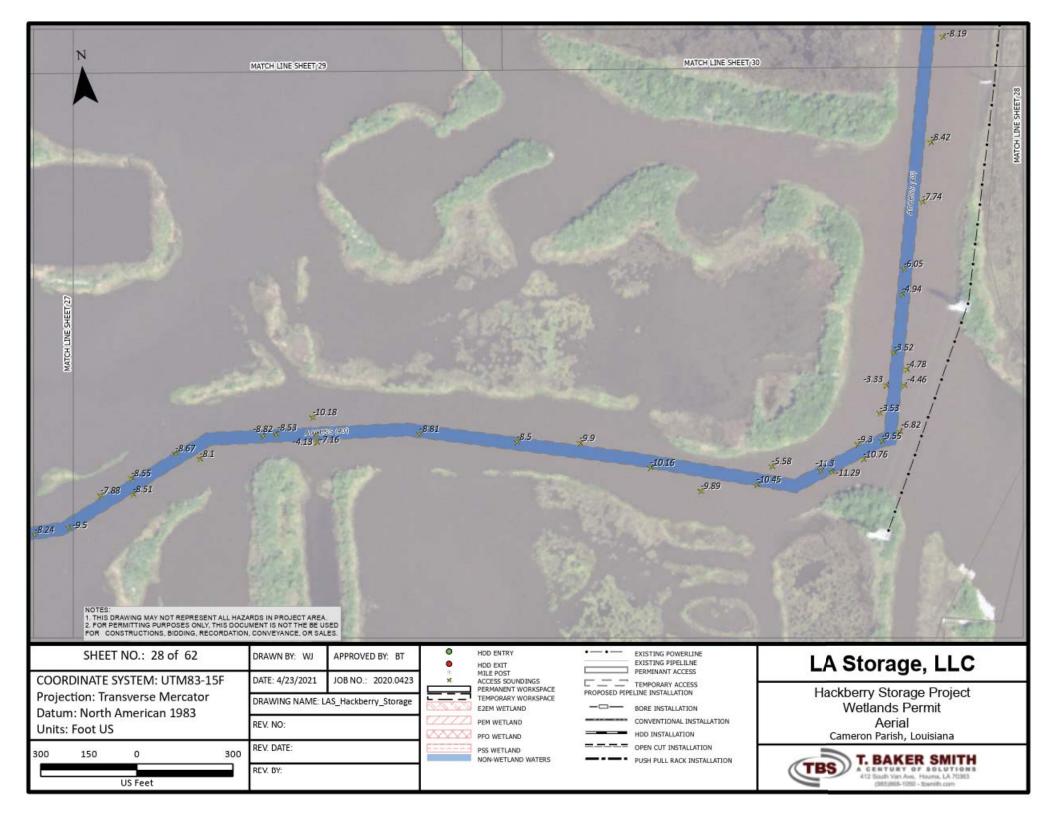


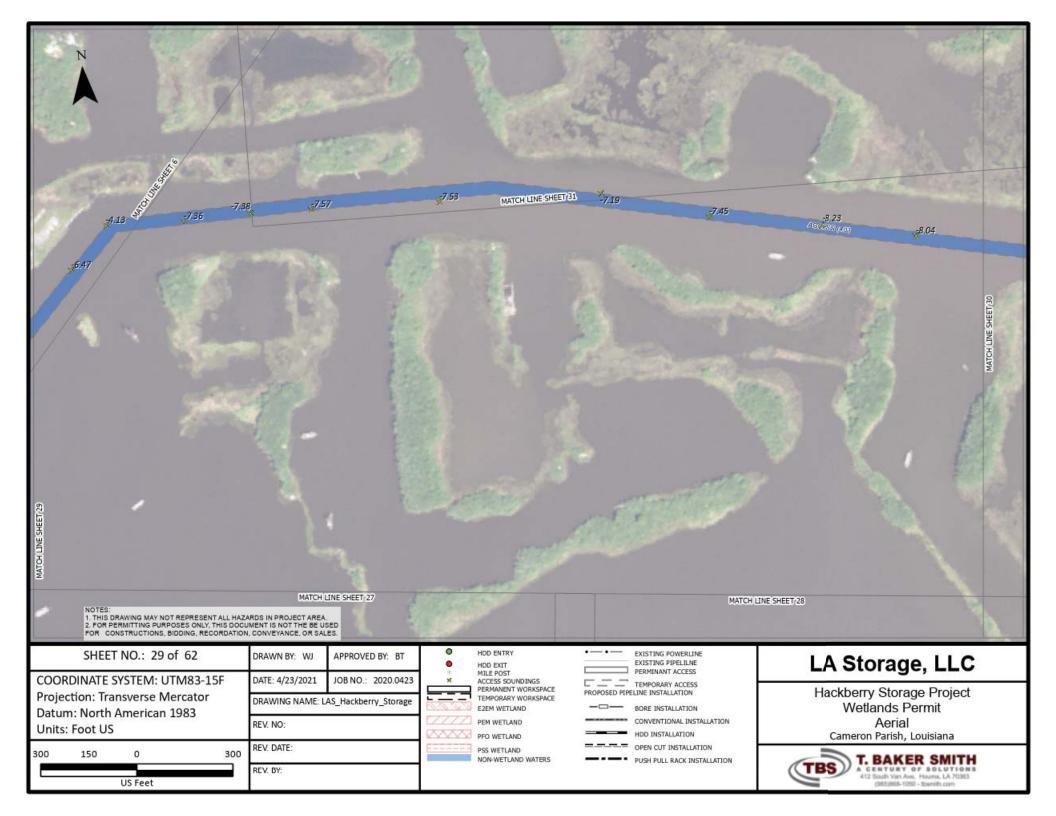


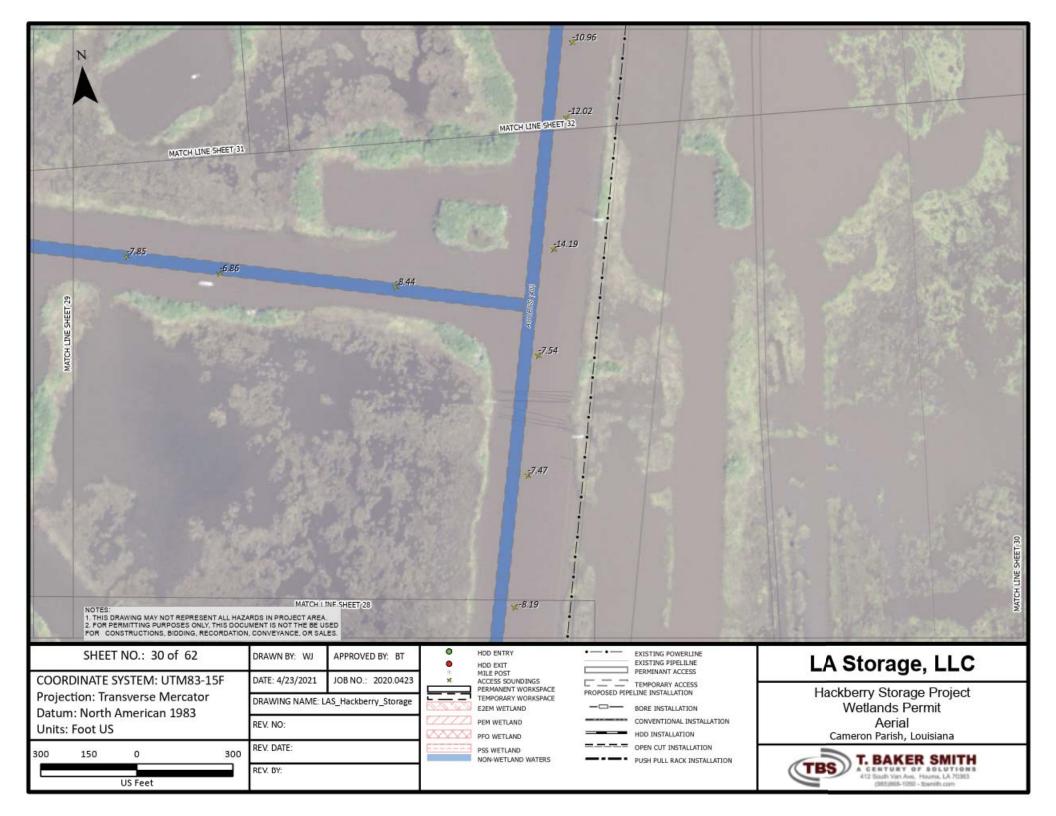


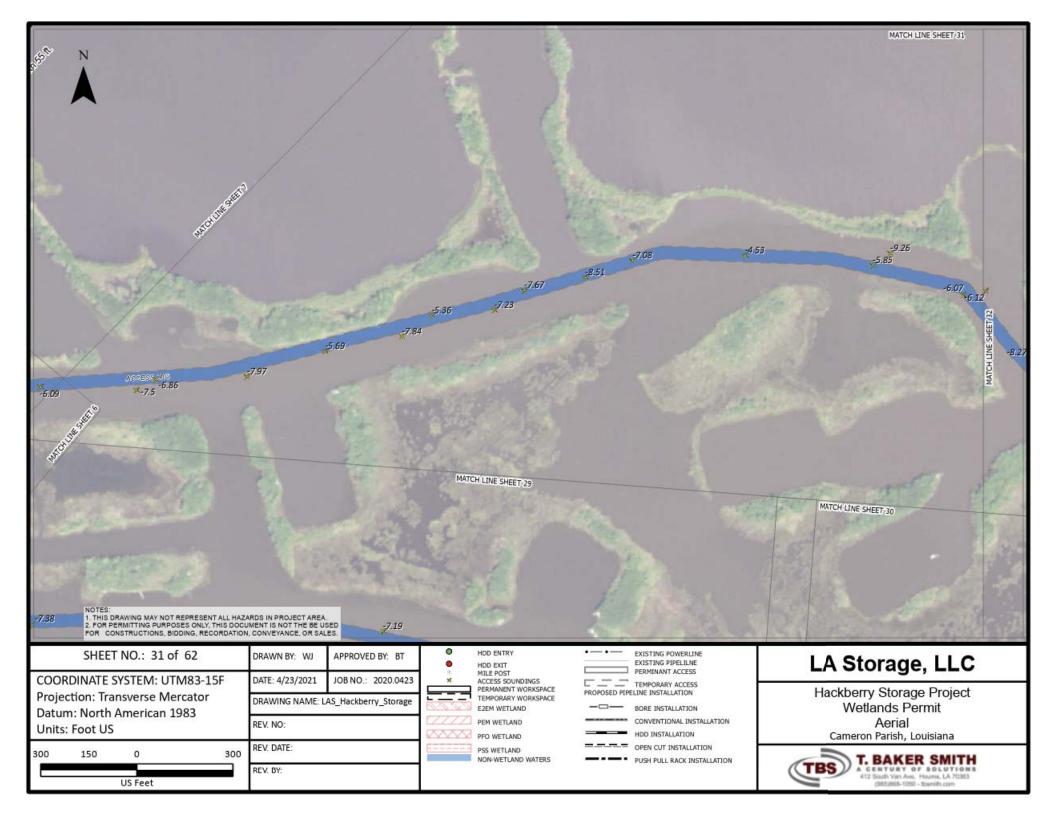


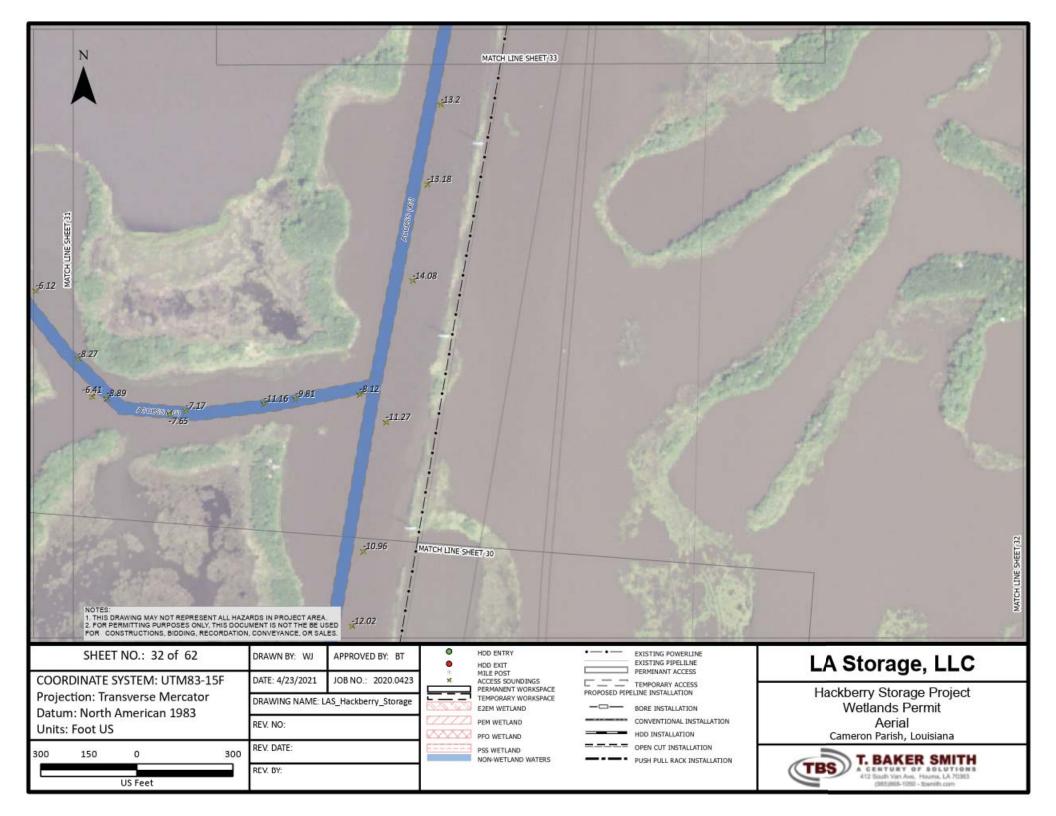


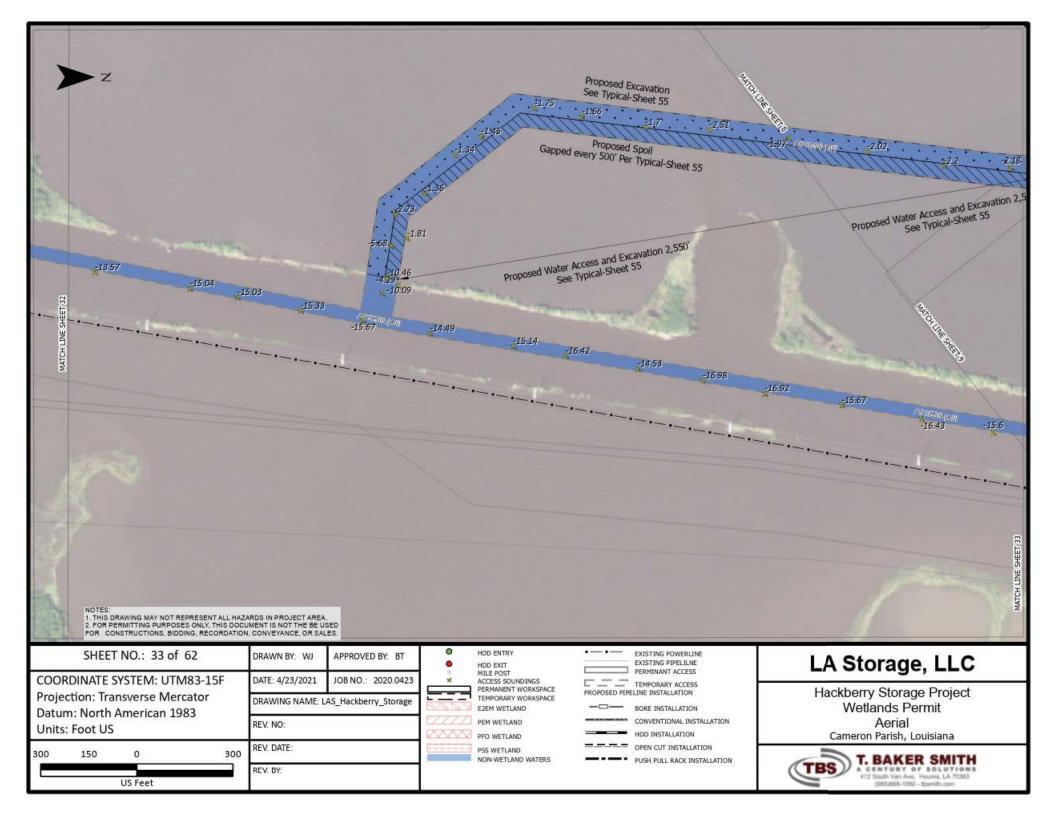


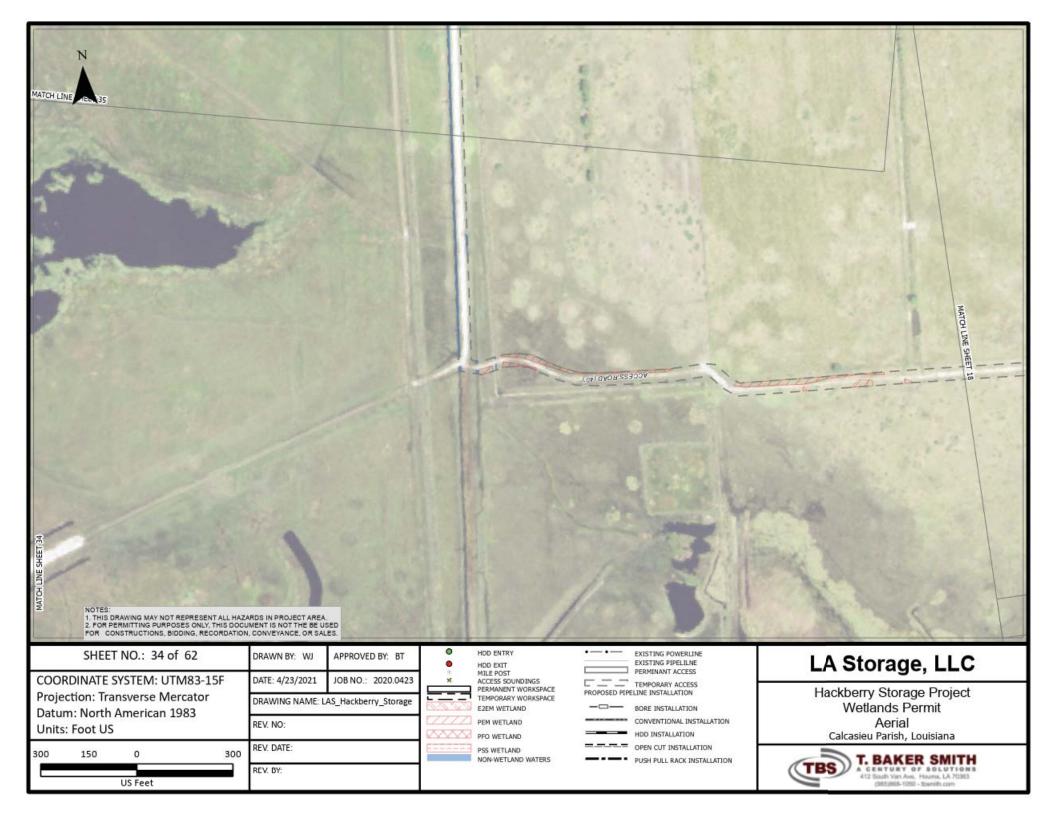


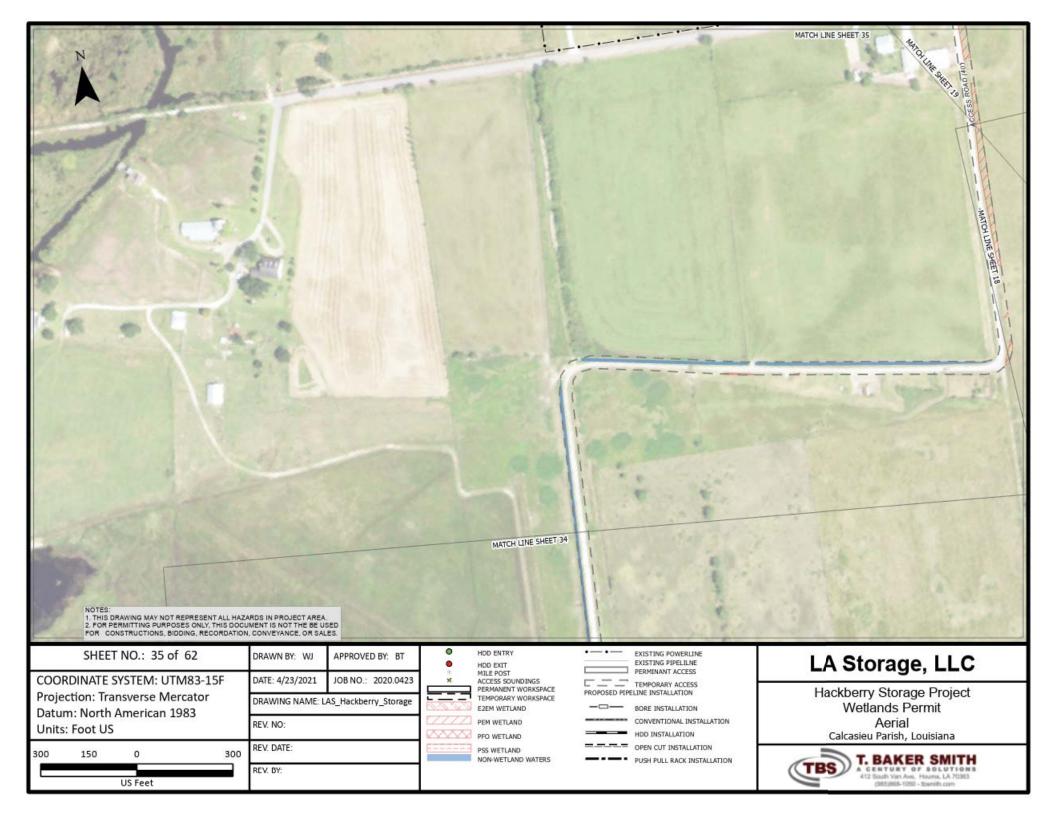

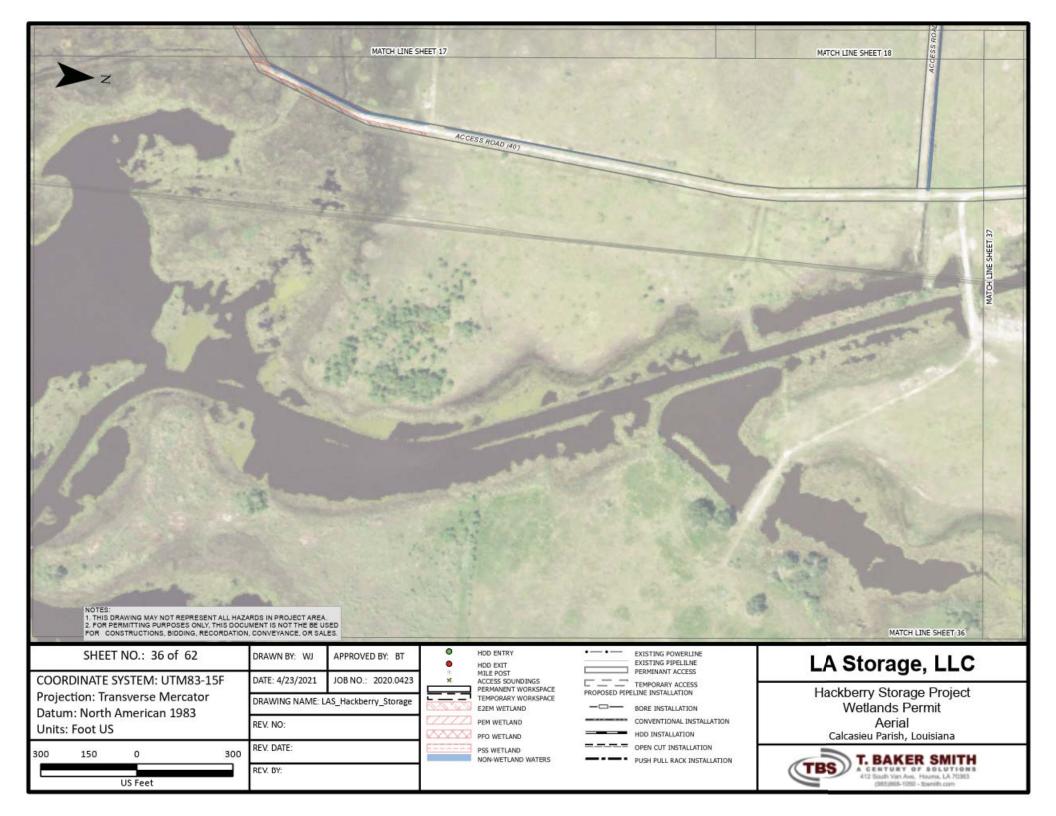

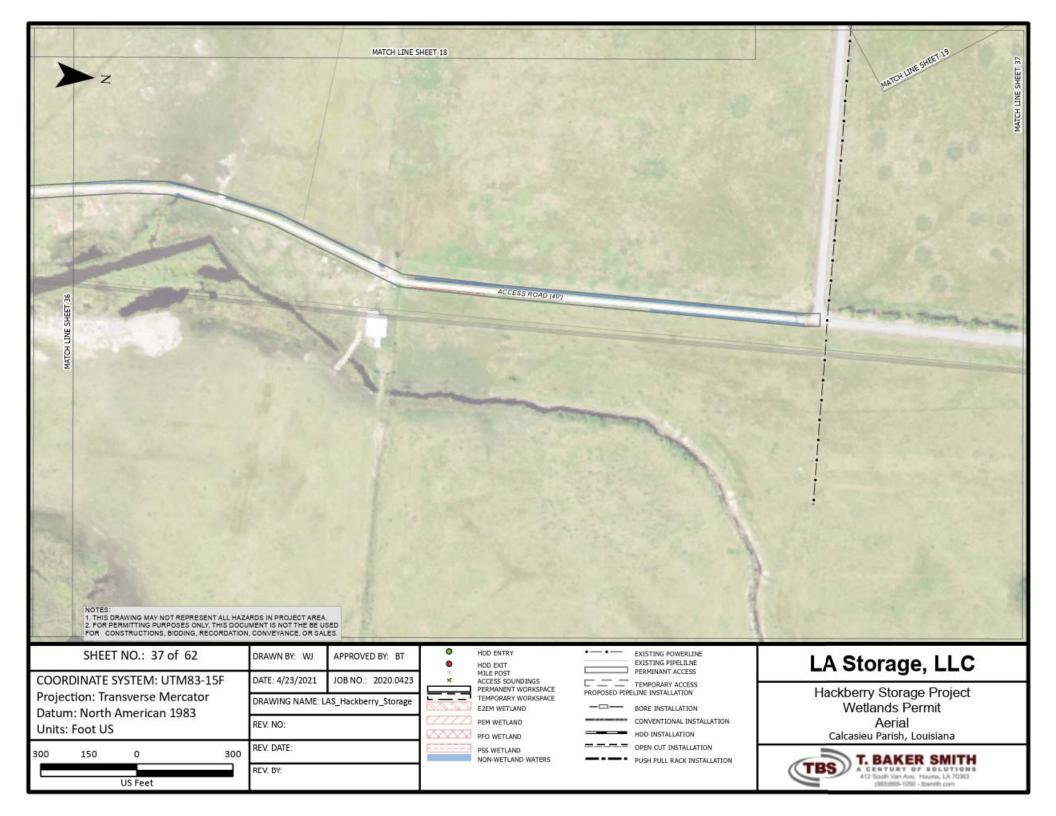

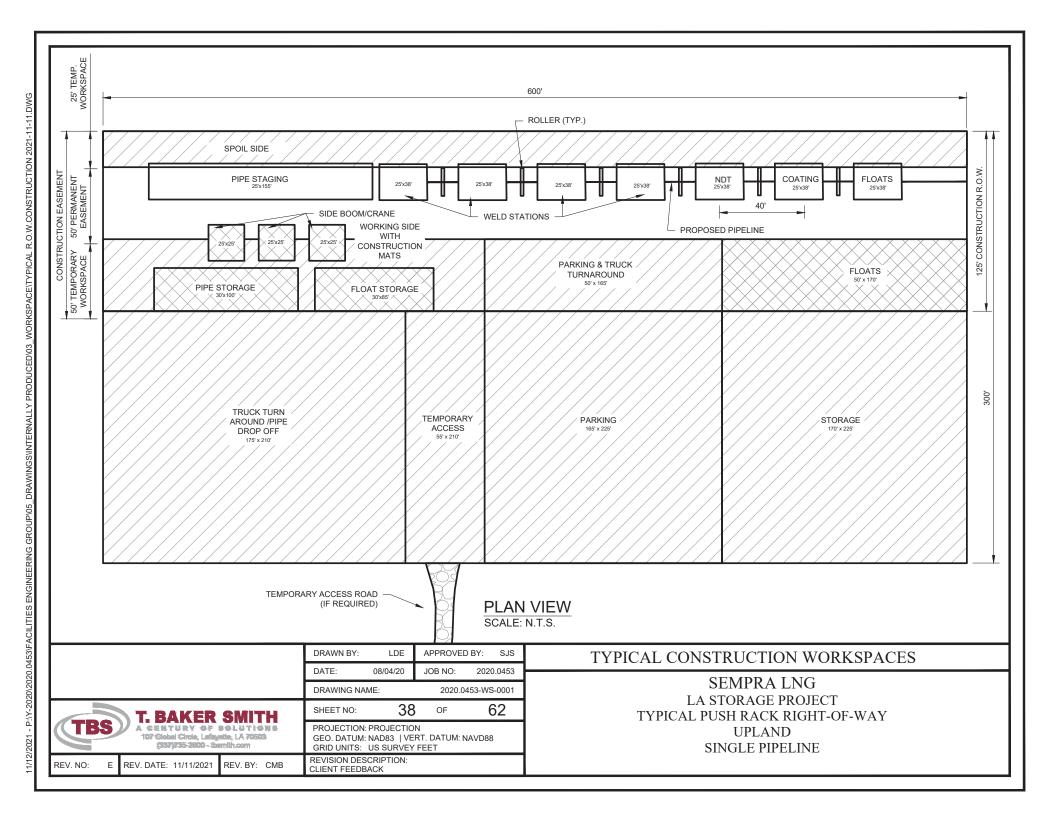

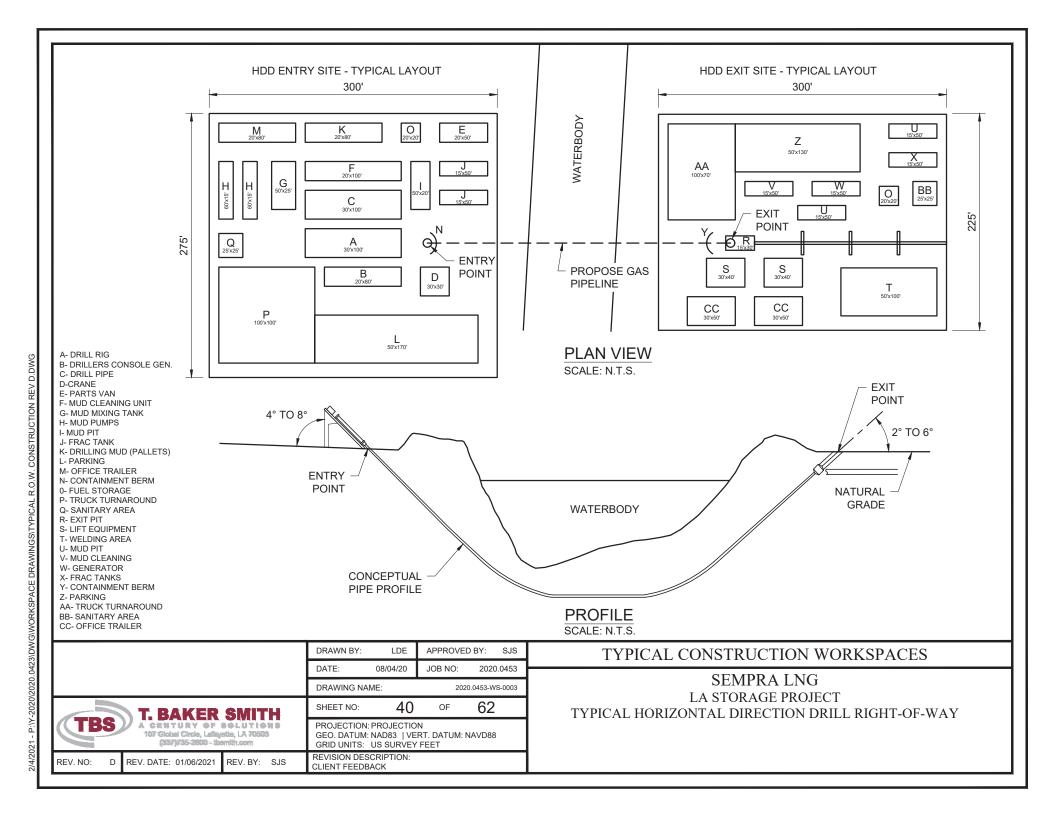


TYPICAL HDD NOTES (CONT. FROM PAGE 40)

NOTES:

- ONLY BENTONITE BASED DRILLING MUD MAY BE USED. USE OF ADDITIVES TO THE DRILLING MUD IS PROHIBITED WITHOUT PRIOR APPROVAL OF THE COMPANY.
- 2. INSTALL SUITABLE DRILLING MUD TANKS OR SUMPS TO PREVENT CONTAMINATION OF WATERCOURSE.
- 3. INSTALL BERMS DOWN SLOPE FROM THE DRILL ENTRY AND ANTICIPATED EXIT POINTS TO CONTAIN ANY RELEASE OF DRILLING MUD.
- DISPOSE OF DRILLING MUD IN ACCORDANCE WITH THE APPROPRIATE REGULATORY AUTHORITY REQUIREMENTS AND IN A COMPANY APPROVED LOCATION.
- 5. DISTANCE BACK FROM EDGE OF WATERBODY VARIES WITH BENDING RADIUS OF PIPE.
- 6. REQUIRED DEPTH TO BE DETERMINED AFTER SITE SPECIFIC GEOTECHNICAL INVESTIGATION.
- 7. AT LOCATION WHERE THE EXIT IS A WETLAND, A BERM SHALL BE USED TO PREVENT CONTAMINATION.


	DRAWN BY: LDE APPROVED BY: SJS	TYPICAL CONSTRUCTION WORKSPACES
	DATE: 09/04/20 JOB NO: 2020.0453 DRAWING NAME: 2020.0453-WS-0003_	SEMPRA LNG
T. BAKER SMITH	SHEET NO: 41 OF 62	LA STORAGE PROJECT TYPICAL HORIZONTAL DIRECTION DRILL RIGHT-OF-WAY
A CENTURY OF SOLUTIONS 107 Global Circle, Lafayette, LA 70503 (337)735-2600 - themith.com	PROJECTION: PROJECTION GEO. DATUM: NAD83 VERT. DATUM: NAVD88 GRID UNITS: US SURVEY FEET	
REV. NO: D REV. DATE: 01/06/2021 REV. BY: SJS	REVISION DESCRIPTION: CLIENT FEEDBACK	

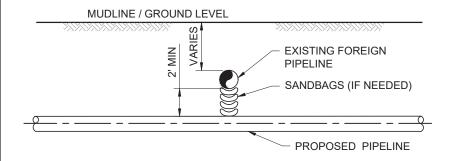

TYPICAL FOREIGN PIPELINE CROSSING DETAIL SCALE: N.T.S.

NOTES:

- FOREIGN PIPELINE LOCATIONS AND DEPTHS TO BE DETERMINED BY ELECTRONIC MEANS IN ADVANCE OF PIPELINE CONSTRUCTION AND CONFIRMED BY OWNER APPROVED EXCAVATION METHOD.
- OWNER OF FOREIGN PIPELINES SHALL BE NOTIFIED 48 HOURS IN ADVANCE OF EXCAVATION OF CROSSING.
- C.P. TEST STATION TO BE INSTALLED WHERE PRACTICAL AT THE NEAREST FENCE, HEDGE ROW OR FIELD EDGE. AND READILY ACCESSIBLE.
- 4. PROPOSED PIPELINE MAY ONLY CROSS ABOVE THE FOREIGN PIPELINES WHERE REQUESTED BY OR APPROVED BY FOREIGN PIPELINE OWNER IN WRITING.
- 5. NO VERTICAL OR HORIZONTAL BENDS WILL BE USED WITHIN FOREIGN PIPELINE R.O.W.
- 6. PRIOR TO EXCAVATION, STATES "ONE CALL" SYSTEM WILL BE UTILIZED.
- 7. PIPELINE SHALL BE INSTALLED IN COMPLIANCE WITH 49 CFR, PART 192 TRANSPORTATION OF NATURAL AND OTHER GAS BY PIPELINE.

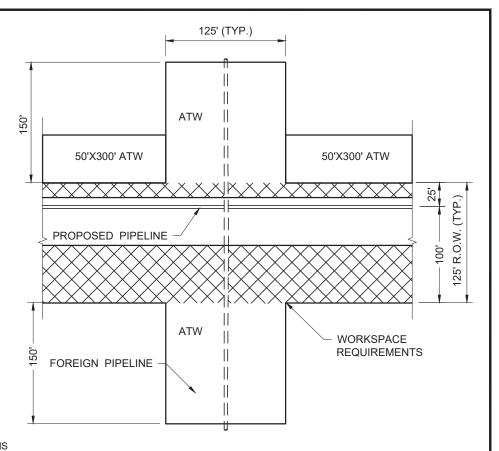


TYPICAL FOREIGN PIPELINE CROSSING PLAN SCALE: N.T.S.

	DRAWN BY: LDE APPROVED BY:	SJS
	DATE: 08/04/20 JOB NO: 2020.0	0453
	DRAWING NAME: 2020.0453-WS	-0004
T. BAKER SMITH	SHEET NO: 42 OF 62	
TBS A CENTURY OF SOLUTIONS 107 Global Circle, Laftquette, LA 70503 (337)735-2000 - themith.com	PROJECTION: PROJECTION GEO. DATUM: NAD83 VERT. DATUM: NAVD88 GRID UNITS: US SURVEY FEET	
REV. NO: D REV. DATE: 01/06/2021 REV. BY: SJS	REVISION DESCRIPTION: CLIENT FEEDBACK	

TYPICAL CONSTRUCTION WORKSPACES

SEMPRA LNG LA STORAGE PROJECT TYPICAL FOREIGN PIPELINE CROSSING IN THE OPEN WATER OR MARSH

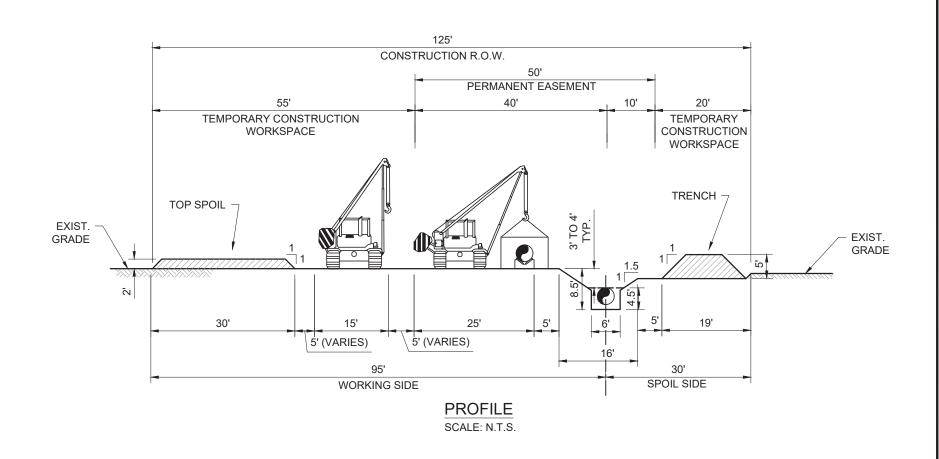


- CLEARANCES DESIGNED FOR SIDE BOOM PIPELAYER.
- 2. PIPE DEPTHS REFERENCED ON ALIGNMENT SHEETS.
- THIS CONSTRUCTION METHOD APPLIES TO FORWARD AND REVERSE PIPELINE LAY.
- . FOREIGN PIPELINE LOCATIONS AND DEPTHS TO BE DETERMINED IN ADVANCE OF PIPELINE CONSTRUCTION.
- FULL RIGHT-OF-WAY TOPSOILING WILL BE CONDUCTED PER LANDOWNER REQUEST AND IN COMPLIANCE WITH THE FFRC UPLAND MAINTENANCE PLAN.
- TRENCH DIMENSIONS ARE ASSUMED BASED ON OSHA TYPE C SOIL SLOPE REQUIREMENTS.
- 7. TOPSOIL SHALL BE SEGREGATED ON WORKING SIDE IN AGRICULTURAL AREAS.

	DRAWN BY:	LDE	APPROVE	BY: SJS	3
	DATE:	08/04/20	JOB NO:	2020.0453	3
	DRAWING NAME:		2020.0453-WS-000		5
T. BAKER SMITH	SHEET NO:	43	OF	62	
A CENTURY OF SOLUTIONS 107 Global Circle, Lafayette, LA 70503 (337)735-2800 - Ibernith.com	PROJECTION GEO. DATUM: GRID UNITS:	NAD83 VE	RT. DATUM: N	NAVD88	
REV. NO: D REV. DATE: 01/06/2021 REV. BY: SJS	REVISION DES				\Box

TYPICAL CONSTRUCTION WORKSPACES

SEMPRA LNG
LA STORAGE PROJECT
TYPICAL CONVENTIONAL CONSTRUCTION RIGHT-OF-WAY
TRADITIONAL UPLAND
SINGLE 42" NATURAL GAS PIPELINE

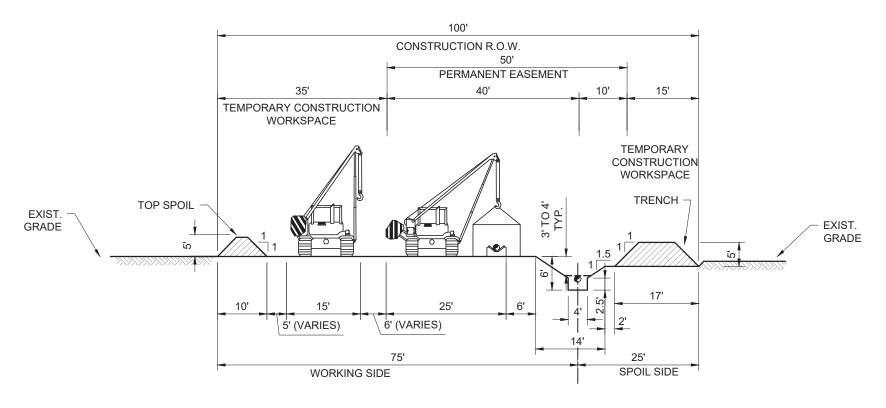

PROFILE SCALE: N.T.S.


NOTES:

- I. CLEARANCES DESIGNED FOR SIDE BOOM PIPELAYER.
- 2. PIPE DEPTHS REFERENCED ON ALIGNMENT SHEETS.
- 3. THIS CONSTRUCTION METHOD APPLIES TO FORWARD AND REVERSE PIPELINE LAY.
- 4. FOREIGN PIPELINE LOCATIONS AND DEPTHS TO BE DETERMINED IN ADVANCE OF PIPELINE CONSTRUCTION.
- FULL RIGHT-OF-WAY TOPSOILING WILL BE CONDUCTED PER LANDOWNER REQUEST AND IN COMPLIANCE WITH THE FFRC UPLAND MAINTENANCE PLAN.
- TRENCH DIMENSIONS ARE ASSUMED BASED ON OSHA TYPE C SOIL SLOPE REQUIREMENTS.
- 7. TOPSOIL SHALL BE SEGREGATED ON WORKING SIDE IN AGRICULTURAL AREAS.

		DRAWN BY:	LDE	APPROVE	BY: SJ	S		
		DATE:	08/04/20	JOB NO:	2020.045	3		
			DRAWING NAME:		2020.0453-WS-0006		6	
	T. BAKER	SMIT	Ħ	SHEET NO:	44	OF	62	\Box
TBS A CENTURY OF SOLUTIONS 107 Global Circle, Lafayeda, LA 70503 (337)735-2000 - themith.com		N 8	PROJECTION GEO. DATUM: GRID UNITS:	NAD83 VE	RT. DATUM: N	NAVD88		
REV. NO: D	REV. DATE: 01/06/2021 REV. BY: SJS REVISION DESCRIPTION: CLIENT FEEDBACK							

TYPICAL CONSTRUCTION WORKSPACES

SEMPRA LNG
LA STORAGE PROJECT
TYPICAL CONVENTIONAL CONSTRUCTION RIGHT-OF-WAY
TRADITIONAL UPLAND
SINGLE 16" BRINE PIPELINE

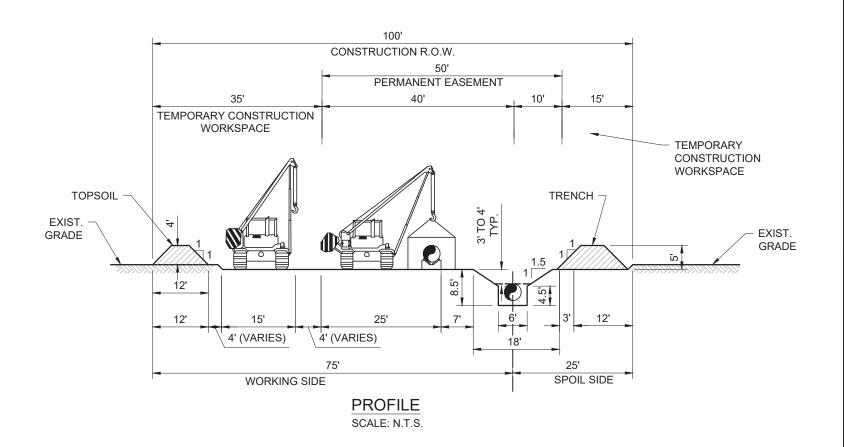


- CLEARANCES DESIGNED FOR SIDE BOOM PIPELAYER.
- 2. PIPE DEPTHS REFERENCED ON ALIGNMENT SHEETS.
- 3. THIS CONSTRUCTION METHOD APPLIES TO FORWARD AND REVERSE PIPELINE LAY.
- FOREIGN PIPELINE LOCATIONS AND DEPTHS TO BE DETERMINED IN ADVANCE OF PIPELINE CONSTRUCTION.
- FULL RIGHT-OF-WAY TOPSOILING WILL BE CONDUCTED PER LANDOWNER REQUEST AND IN COMPLIANCE WITH THE FFRC UPLAND MAINTENANCE PLAN.
- 6. TRENCH DIMENSIONS ARE ASSUMED BASED ON OSHA TYPE C SOIL SLOPE REQUIREMENTS.
- TOPSOIL SHALL BE SEGREGATED ON WORKING SIDE IN AGRICULTURAL AREAS.
- 8. MATS CAN BE USED AS AN ALTERNATIVE TO FULL RIGHT OF WAY TOPSOILING.

	DRAWN BY:	LDE	APPROVED	BY:	SJS
	DATE:	08/04/20	JOB NO:	2020.0	0453
	DRAWING NA	ME:	2020.0	453-WS-0	8000
T. BAKER SMITH	SHEET NO:	45	OF	62	
TBS A CENTURY OF SOLUTIONS 107 Global Circle, Lafayette, LA 70503 (337)735-2800themith.com	PROJECTION: GEO. DATUM: GRID UNITS:	NAD83 VE	RT. DATUM: N	NAVD88	
REV. NO: D REV. DATE: 01/06/2021 REV. BY: SJS	REVISION DES				

TYPICAL CONSTRUCTION WORKSPACES

SEMPRA LNG
LA STORAGE PROJECT
TYPICAL CONVENTIONAL CONSTRUCTION RIGHT-OF-WAY
NON-SATURATED WETLAND
SINGLE 42" NATURAL GAS PIPELINE

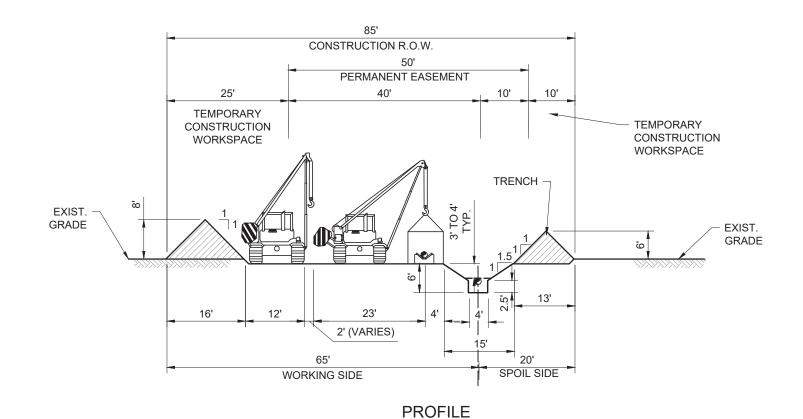

SCALE: N.T.S.


NOTES:

- CLEARANCES DESIGNED FOR SIDE BOOM PIPELAYER.
- PIPE DEPTHS REFERENCED ON ALIGNMENT SHEETS.
- 3. THIS CONSTRUCTION METHOD APPLIES TO FORWARD AND REVERSE PIPELINE LAY.
- 4. FOREIGN PIPELINE LOCATIONS AND DEPTHS TO BE DETERMINED IN ADVANCE OF PIPELINE CONSTRUCTION.
- FULL RIGHT-OF-WAY TOPSOILING WILL BE CONDUCTED PER LANDOWNER REQUEST AND IN COMPLIANCE WITH THE FFRC UPLAND MAINTENANCE PLAN.
- TRENCH DIMENSIONS ARE ASSUMED BASED ON OSHA TYPE C SOIL SLOPE REQUIREMENTS.
- 7. TOPSOIL SHALL BE SEGREGATED ON WORKING SIDE IN AGRICULTURAL AREAS.
- . MATS CAN BE USED AS AN ALTERNATIVE TO FULL RIGHT OF WAY TOPSOILING.

	DRAWN BY:	LDE	APPROVE	D BY: SJS	I
	DATE:	08/04/20	JOB NO:	2020.0453	긮
	DRAWING NA	ME:	2020.0	0453-WS-0009	
T. BAKER SMITH	SHEET NO:	46	OF	62	
TBS A CENTURY OF SOLUTIONS 107 Global Circle, Lafayetic, LA 70503 (337)735-2800bemüh.com	PROJECTION GEO. DATUM: GRID UNITS:	NAD83 VE	RT. DATUM: I	NAVD88	
REV. NO: D REV. DATE: 01/06/2021 REV. BY: SJS	REVISION DES				
					_

TYPICAL CONSTRUCTION WORKSPACES

SEMPRA LNG
LA STORAGE PROJECT
TYPICAL CONVENTIONAL CONSTRUCTION RIGHT-OF-WAY
NON-SATURATED WETLAND
SINGLE 16" BRINE PIPELINE

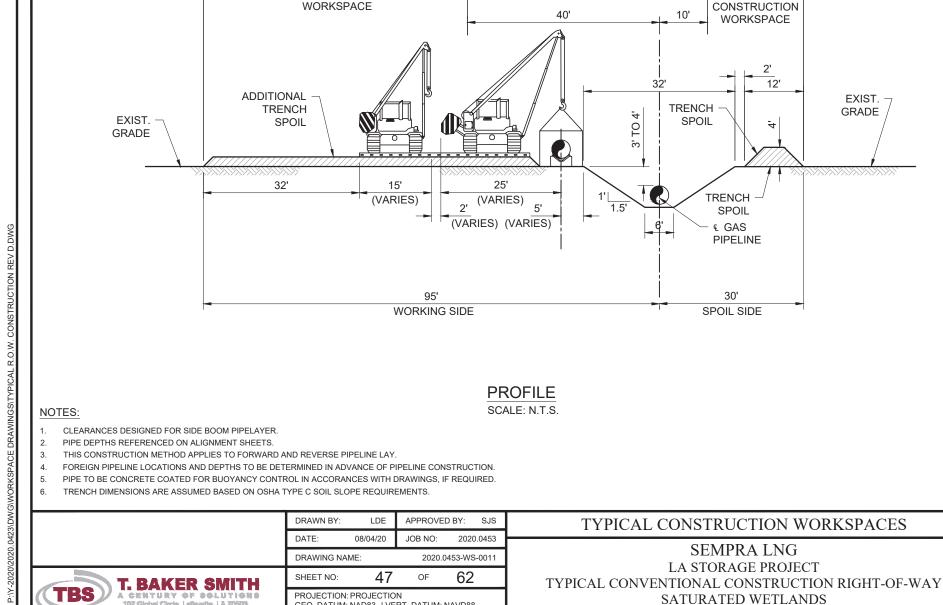

PROJECTION: PROJECTION

REVISION DESCRIPTION:

CLIENT FEEDBACK

GRID UNITS: US SURVEY FEET

GEO. DATUM: NAD83 | VERT. DATUM: NAVD88

55'

TEMPORARY CONSTRUCTION

125' CONSTRUCTION R.O.W.

50'

PERMANENT EASEMENT

20' (MAX)

TEMPORARY

CONSTRUCTION

WORKSPACE

12'

4

TRENCH

SPOIL

PIPELINE

€ GAS

30'

SPOIL SIDE

SATURATED WETLANDS

SINGLE 42" NATURAL GAS PIPELINE

EXIST.

GRADE

REV. NO:

107 Global Circle, Lafayette, LA 70503


REV. BY: SJS

(337)735-2800 - themith.com

REV. DATE: 01/06/2021

D




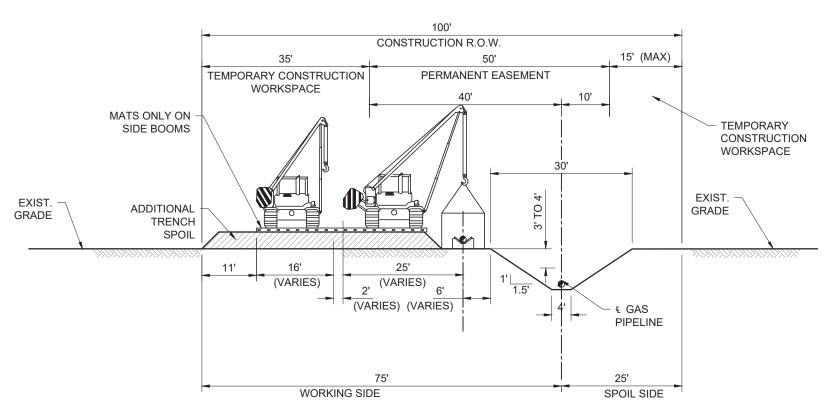

PROFILE SCALE: N.T.S.

- CLEARANCES DESIGNED FOR SIDE BOOM PIPELAYER.
- 2. PIPE DEPTHS REFERENCED ON ALIGNMENT SHEETS.
- 3. THIS CONSTRUCTION METHOD APPLIES TO FORWARD AND REVERSE PIPELINE LAY.
- 4. FOREIGN PIPELINE LOCATIONS AND DEPTHS TO BE DETERMINED IN ADVANCE OF PIPELINE CONSTRUCTION.
- PIPE TO BE CONCRETE COATED FOR BUOYANCY CONTROL IN ACCORANCES WITH DRAWINGS, IF REQUIRED.
- TRENCH DIMENSIONS ARE ASSUMED BASED ON OSHA TYPE C SOIL SLOPE REQUIREMENTS.

	DRAWN BY: LDE APPROVED BY: SJS	TYPICAL CONSTRUCTION WORKSPACES
	DATE: 08/04/20 JOB NO: 2020.0453	SEMPRA LNG
	DRAWING NAME: 2020.0453-WS-0012	TYPICAL CONVENTIONAL CONSTRUCTION RIGHT-OF-WAY
T. BAKER SMITH	SHEET NO: 48 OF 62	SATURATED WETLAND
TBS A CENTURY OF SOLUTIONS 107 Global Circle, Lafayette, LA 70503 (337)735-2000 - themith.com	PROJECTION: PROJECTION GEO. DATUM: NAD83 VERT. DATUM: NAVD88 GRID UNITS: US SURVEY FEET	SINGLE 16" BRINE PIPELINE
REV. NO: D REV. DATE: 01/06/2021 REV. BY: SJS	REVISION DESCRIPTION: CLIENT FEEDBACK	

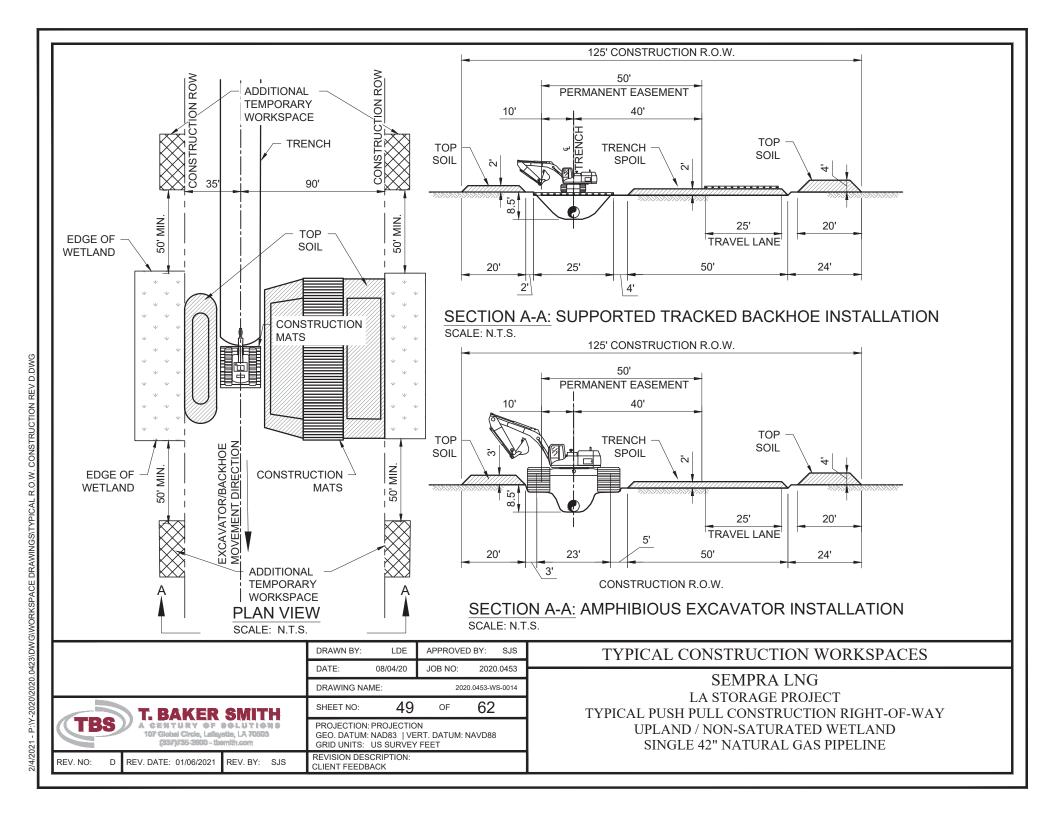


- 1. FLAG WETLAND BOUNDARIES (PRIOR TO CLEANING) AND VEGETATIVE BUFFER ZONE.
- NO REFUELING OF MOBILE EQUIPMENT IS ALLOWED WITHIN 100 FEET OF WETLAND OR WITHIN 500 FEET OF
 THE WETLAND ON BLM LANDS. PLACE "NO FUELING" SIGN POSTS 100 FEET BACK FROM WETLAND
 BOUNDARY, OR 500 FEET FROM THE WETLAND ON BLM LANDS. REFUEL STATIONARY EQUIPMENT AS PER THE
 PROJECT'S SPILL PREVENTION PROCEDURES.
- INSTALL TEMPORARY SLOPE BREAKER UPSLOPE WITHIN 100 FEET OF WETLAND BOUNARY AS DIRECTED BY COMPANY.
- . RESTRICT ROOT GRUBBING TO ONLY THE AREA OVER THE DITCHLINE.
- 5. TOPSOIL STRIPPING SHALL NOT BE REQUIRED IN SATURATED SOIL CONDITIONS.
- 6. UTILIZE AMPHIBIOUS EXCAVATORS (PONTOON MOUNTED BACKHOES) OR TRACKED BACKHOES SUPPORTED BY FABRICATED TIMBER MATS OR FLOATS TO EXCAVATE TRENCH. IF FABRICATED TIMBER MATS ARE USED FOR STABILIZATION, THE BACKHOE SHALL GRADUALLY MOVE ACROSS THE WETLAND/N.F. WATER BODY BY MOVING THE MAT FROM IMMEDIATELY BEHIND TO IMMEDIATELY IN FRONT OF THE BACKHOE'S PATH.
- 7. AVOID ADJACTENT WETLANDS. INSTALL SEDIMENT BARRIERS AT EDGE OR R.O.W., IF PRACTICAL.
- 8. FABRICATE PIPE IN STAGING AREA IN THE EXTRA WORK SPACE AS INDICATED ON THE CONSTRUCTION DRAWINGS.
- 9. LEAVE HARD PLUGS AT THE EDGE OF THE WETLAND UNTIL JUST PRIOR TO PIPE PLACEMENT.
- FLOAT PIPE IN PLACE, LOWER-IN INSTALL TRENCH PLUGS AT WETLAND EDGES WHERE REQUIRED AND BACKFILL IMMEDIATELY.
- 11. REMOVE TIMBER MATS OR PREFABRICATED MATS OF NON-NATIVE MATERIAL FROM WETLANDS UPON COMPLETION
- 12. RESTORE GRADE TO NEAR PRE-CONSTRUCTION TOPOGRAPHY AND INSTALL PERMANENT EROSION CONTROL.
- 13. PIPE TO BE CONCRETE COATED FOR BUOYANCY CONTROL IF NECESSARY.
- 14. TRENCH WIDTH VARIES DUE TO SOIL SLUFFING/SILTING. TRENCH DIMENSIONS ARE ASSUMED BASED ON OSHA TYPE C SOIL SLOPE REQUIREMENTS.
- 15. UPLAND AND NON-SATURATED WETLANDS SHALL MAINTAIN SEGREGATION BETWEEN OF TOP SOIL AND TRENCH SOIL. SEGREGATION OF SOILS DOES NOT APPLY TO SATURATED WETLANDS.

	DRAWN BY: LDE APPROVED BY: SJS
	DATE: 08/04/20 JOB NO: 2020.0453
	DRAWING NAME: 2020.0453-WS-0014_
T. BAKER SMITH	SHEET NO: 50 OF 62
TBS A CENTURY OF SOLUTIONS 107 Global Circle, Lafayette, LA 70503 (337)735-2600-tbemth.com	PROJECTION: PROJECTION GEO. DATUM: NAD83 VERT. DATUM: NAVD88 GRID UNITS: US SURVEY FEET
V. NO: D REV. DATE: 01/06/2021 REV. BY: SJS	REVISION DESCRIPTION: CLIENT FEEDBACK

TYPICAL CONSTRUCTION WORKSPACES

SEMPRA LNG
LA STORAGE PROJECT
TYPICAL PUSH PULL CONSTRUCTION RIGHT-OF-WAY
UPLAND / NON-SATURATED WETLAND
SINGLE 42" NATURAL GAS PIPELINE

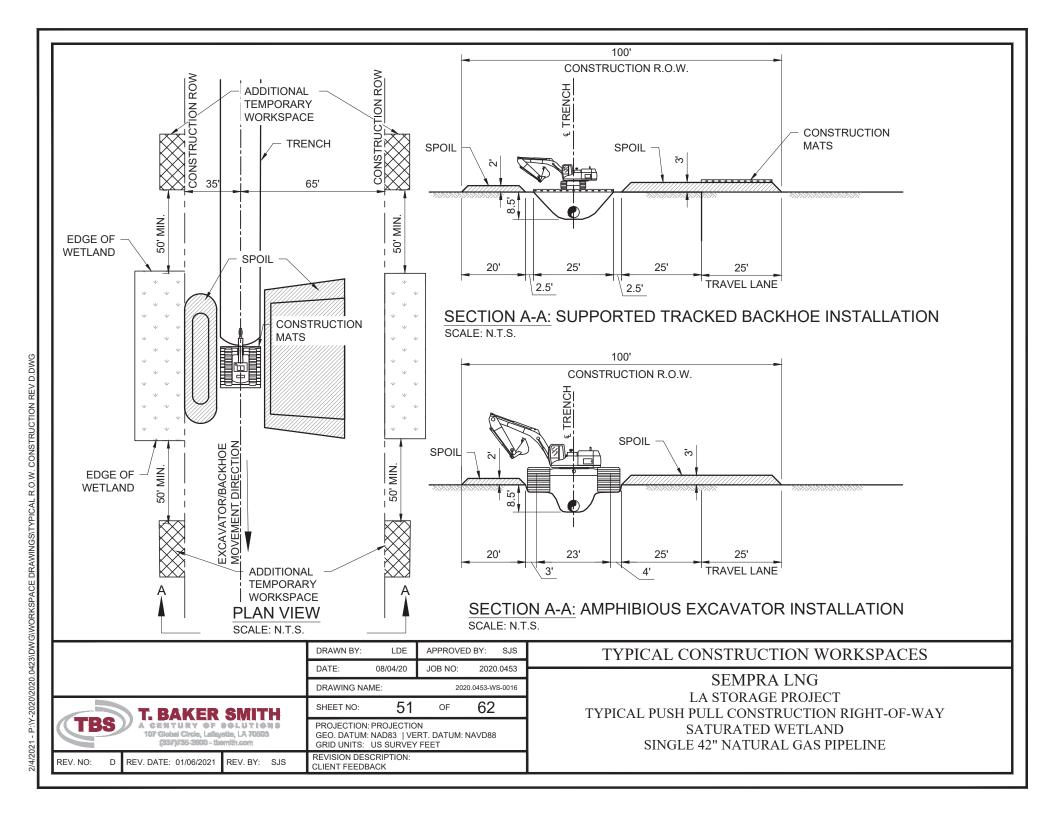


- 1. FLAG WETLAND BOUNDARIES (PRIOR TO CLEANING) AND VEGETATIVE BUFFER ZONE.
- NO REFUELING OF MOBILE EQUIPMENT IS ALLOWED WITHIN 100 FEET OF WETLAND OR WITHIN 500 FEET OF
 THE WETLAND ON BLM LANDS. PLACE "NO FUELING" SIGN POSTS 100 FEET BACK FROM WETLAND
 BOUNDARY, OR 500 FEET FROM THE WETLAND ON BLM LANDS. REFUEL STATIONARY EQUIPMENT AS PER THE
 PROJECT'S SPILL PREVENTION PROCEDURES.
- INSTALL TEMPORARY SLOPE BREAKER UPSLOPE WITHIN 100 FEET OF WETLAND BOUNARY AS DIRECTED BY COMPANY.
- RESTRICT ROOT GRUBBING TO ONLY THE AREA OVER THE DITCHLINE.
- 5. TOPSOIL STRIPPING SHALL NOT BE REQUIRED IN SATURATED SOIL CONDITIONS.
- 6. UTILIZE AMPHIBIOUS EXCAVATORS (PONTOON MOUNTED BACKHOES) OR TRACKED BACKHOES SUPPORTED BY FABRICATED TIMBER MATS OR FLOATS TO EXCAVATE TRENCH. IF FABRICATED TIMBER MATS ARE USED FOR STABILIZATION, THE BACKHOE SHALL GRADUALLY MOVE ACROSS THE WETLAND/N.F. WATER BODY BY MOVING THE MAT FROM IMMEDIATELY BEHIND TO IMMEDIATELY IN FRONT OF THE BACKHOE'S PATH.
- AVOID ADJACTENT WETLANDS, INSTALL SEDIMENT BARRIERS AT EDGE OR R.O.W., IF PRACTICAL.
- FABRICATE PIPE IN STAGING AREA IN THE EXTRA WORK SPACE AS INDICATED ON THE CONSTRUCTION DRAWINGS.
- 9. LEAVE HARD PLUGS AT THE EDGE OF THE WETLAND UNTIL JUST PRIOR TO PIPE PLACEMENT.
- FLOAT PIPE IN PLACE, LOWER-IN INSTALL TRENCH PLUGS AT WETLAND EDGES WHERE REQUIRED AND BACKFILL IMMEDIATELY.
- 11. REMOVE TIMBER MATS OR PREFABRICATED MATS OF NON-NATIVE MATERIAL FROM WETLANDS UPON COMPLETION
- 12. RESTORE GRADE TO NEAR PRE-CONSTRUCTION TOPOGRAPHY AND INSTALL PERMANENT EROSION CONTROL.
- 13. PIPE TO BE CONCRETE COATED FOR BUOYANCY CONTROL IF NECESSARY.
- 14. TRENCH WIDTH VARIES DUE TO SOIL SLUFFING/SILTING. TRENCH DIMENSIONS ARE ASSUMED BASED ON OSHA TYPE C SOIL SLOPE REQUIREMENTS.
- 15. UPLAND AND NON-SATURATED WETLANDS SHALL MAINTAIN SEGREGATION BETWEEN TOP SOIL AND TRENCH SOIL. SEGREGATION OF SOILS DOES NOT APPLY TO SATURATED WETLANDS.

	DRAWN BY: LDE APPROVED BY: SJS
	DATE: 08/04/20 JOB NO: 2020.0453
	DRAWING NAME: 2020.0453-WS-0016_
T. BAKER SMITH	SHEET NO: 52 OF 62
TBS A CENTURY OF SOLUTIONS 107 Global Circle, Lafayotic, LA 70503 (337)735-2000-themith.com	PROJECTION: PROJECTION GEO. DATUM: NAD83 VERT. DATUM: NAVD88 GRID UNITS: US SURVEY FEET
7. NO: D REV. DATE: 01/06/2021 REV. BY: SJS	REVISION DESCRIPTION: CLIENT FEEDBACK

TYPICAL CONSTRUCTION WORKSPACES

SEMPRA LNG
LA STORAGE PROJECT
TYPICAL PUSH PULL CONSTRUCTION RIGHT-OF-WAY
SATURATED WETLAND
SINGLE 42" NATURAL GAS PIPELINE


- FLAG WETLAND BOUNDARIES (PRIOR TO CLEANING) AND VEGETATIVE BUFFER ZONE.
- NO REFUELING OF MOBILE EQUIPMENT IS ALLOWED WITHIN 100 FEET OF WETLAND OR WITHIN 500 FEET OF THE WETLAND ON BLM LANDS. PLACE "NO FUELING" SIGN POSTS 100 FEET BACK FROM WETLAND BOUNDARY, OR 500 FEET FROM THE WETLAND ON BLM LANDS. REFUEL STATIONARY EQUIPMENT AS PER THE PROJECT'S SPILL PREVENTION PROCEDURES.
- INSTALL TEMPORARY SLOPE BREAKER UPSLOPE WITHIN 100 FEET OF WETLAND BOUNARY AS DIRECTED BY COMPANY.
- RESTRICT ROOT GRUBBING TO ONLY THE AREA OVER THE DITCHLINE.
- TOPSOIL STRIPPING SHALL NOT BE REQUIRED IN SATURATED SOIL CONDITIONS.
- 6. UTILIZE AMPHIBIOUS EXCAVATORS (PONTOON MOUNTED BACKHOES) OR TRACKED BACKHOES SUPPORTED BY FABRICATED TIMBER MATS OR FLOATS TO EXCAVATE TRENCH. IF FABRICATED TIMBER MATS ARE USED FOR STABILIZATION, THE BACKHOE SHALL GRADUALLY MOVE ACROSS THE WETLAND/N.F. WATER BODY BY MOVING THE MAT FROM IMMEDIATELY BEHIND TO IMMEDIATELY IN FRONT OF THE BACKHOE'S PATH.
- AVOID ADJACTENT WETLANDS. INSTALL SEDIMENT BARRIERS AT EDGE OR R.O.W., IF PRACTICAL.
- FABRICATE PIPE IN STAGING AREA IN THE EXTRA WORK SPACE AS INDICATED ON THE CONSTRUCTION DRAWINGS.
- LEAVE HARD PLUGS AT THE EDGE OF THE WETLAND UNTIL JUST PRIOR TO PIPE PLACEMENT.
- FLOAT PIPE IN PLACE, LOWER-IN INSTALL TRENCH PLUGS AT WETLAND EDGES WHERE REQUIRED AND BACKFILL IMMEDIATELY.
- REMOVE TIMBER MATS OR PREFABRICATED MATS OF NON-NATIVE MATERIAL FROM WETLANDS UPON COMPLETION.
- RESTORE GRADE TO NEAR PRE-CONSTRUCTION TOPOGRAPHY AND INSTALL PERMANENT EROSION CONTROL.
- PIPE TO BE CONCRETE COATED FOR BUOYANCY CONTROL IF NECESSARY
- 14. TRENCH WIDTH VARIES DUE TO SOIL SLUFFING/SILTING. TRENCH DIMENSIONS ARE ASSUMED BASED ON OSHA TYPE C SOIL SLOPE REQUIREMENTS.
- UPLAND AND NON-SATURATED WETLANDS SHALL MAINTAIN SEGREGATION BETWEEN TOP SOIL AND TRENCH SOIL. SEGREGATION OF SOILS DOES NOT APPLY TO SATURATED WETLANDS.
- 16. 75-FOOT CENTERLINE SPACING WILL BE REQUIRED IN AREAS WHERE THE ROUTE IS LOCATED WITHIN A HISTORICAL DREDGED MATERIAL PLACEMENT AREA DUE TO VARIABLE SOIL TYPES OF DREDGED MATERIALS PLACED OVER THE YEARS. THE ADDITIONAL SPACING WILL ACCOUNT FOR UNKNOWN LATERAL RESISTANCE AND BEARING STRENGTH SETTLEMENT PROPERTIES OF THE SOIL TYPES

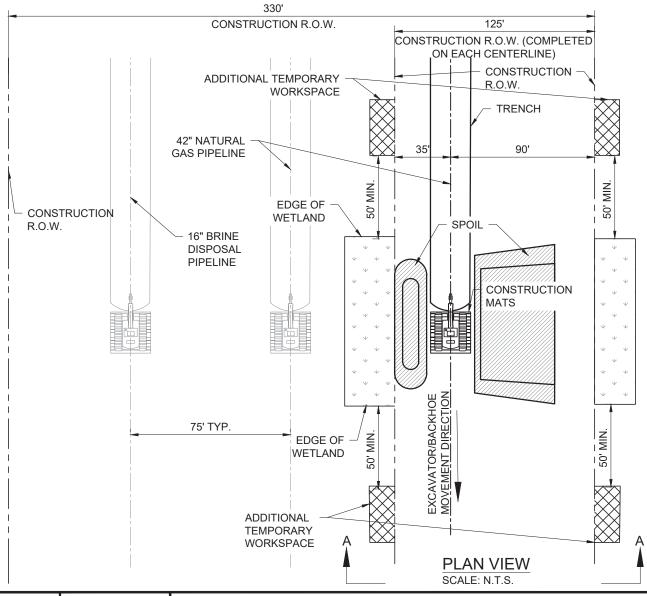


DRAWN BY: LDE APPROVED BY: SJS DATE: 08/04/20 JOB NO: 2020.0453 DRAWING NAME: 2020.0453-WS-0018 53 62 SHEET NO: PROJECTION: PROJECTION 107 Global Circle, Lafavette, LA 70503 GEO. DATUM: NAD83 | VERT. DATUM: NAVD88 (337)735-2800 - themith.com GRID UNITS: US SURVEY FEET REVISION DESCRIPTION: REV. DATE: 01/06/2021 REV. NO: D REV. BY: CLIENT FEEDBACK

TYPICAL CONSTRUCTION WORKSPACES

SEMPRA LNG
LA STORAGE PROJECT
TYPICAL PUSH PULL CONSTRUCTION RIGHT-OF-WAY
SATURATED WETLAND
TWO 42" NATURAL GAS PIPELINE AND ONE 16" BRINE PIPELINE
75' SPACING

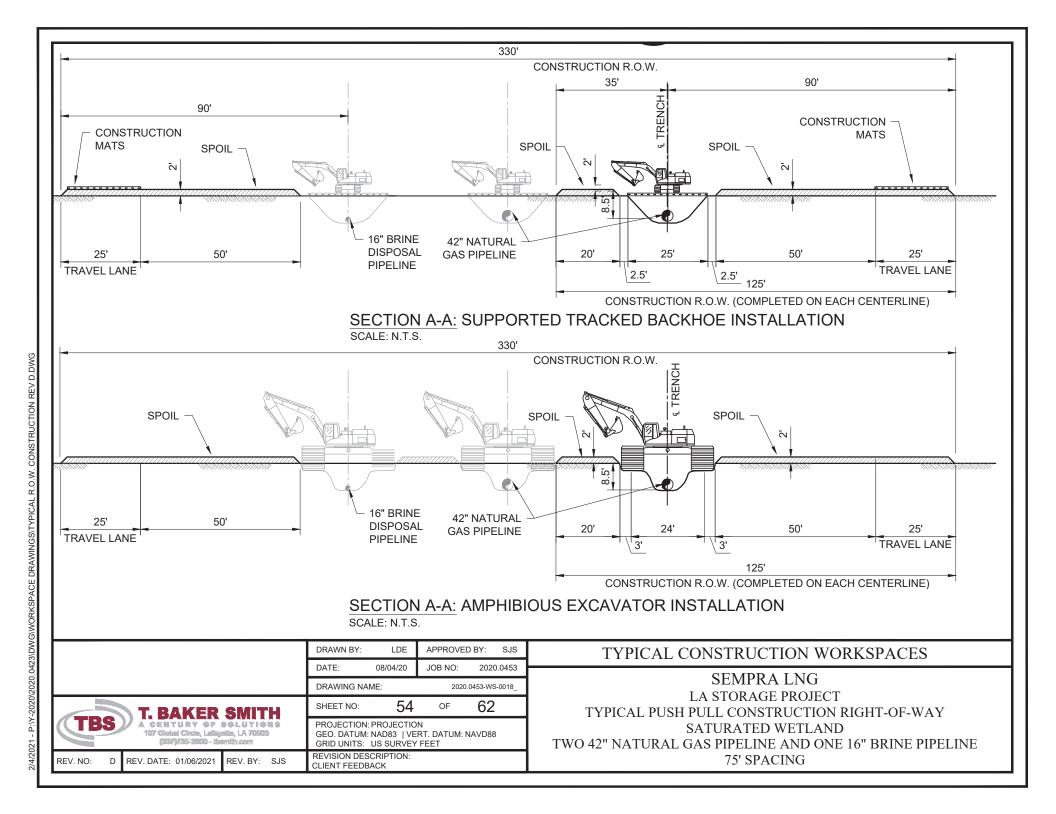

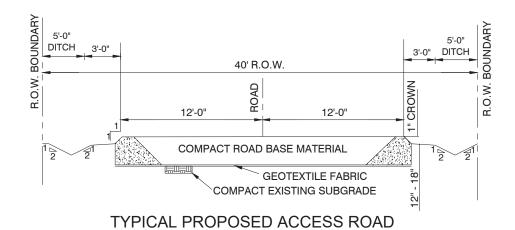



SCALE: N.T.S.

- NOTES:
 1.) THIS PLAT IS TO BE USED EXCLUSIVELY FOR PERMITTING PURPOSES ONLY.
 2.) MATS WILL BE TEMPORARILY PLACED ALONG THE ACCESS ROAD AS NEEDED.

	DRAWN BY: LDE APPROVED BY: SJS	ACCESS ROAD
	DATE: 10/01/20 JOB NO: 2020.0453 DRAWING NAME: 2020.0453-WS-0037	SEMPRA LNG
T. BAKER SMITH	SHEET NO: 56 OF 62	LA STORAGE PROJECT ACCESS ROAD TYPICAL
TBS A CENTURY OF SOLUTIONS 107 Global Circle, Laffayetin, LA 70503 (337)735-2000 - themith.com	PROJECTION: PROJECTION GEO. DATUM: NAD83 VERT. DATUM: NAVD88 GRID UNITS: US SURVEY FEET	
	REVISION DESCRIPTION: CLIENT FEEDBACK	

- FLAG WETLAND BOUNDARIES (PRIOR TO CLEANING) AND VEGETATIVE BUFFER ZONE.
- NO REFUELING OF MOBILE EQUIPMENT IS ALLOWED WITHIN 100 FEET OF WETLAND OR WITHIN 500 FEET OF THE WETLAND ON BLM LANDS. PLACE "NO FUELING" SIGN POSTS 100 FEET BACK FROM WETLAND BOUNDARY, OR 500 FEET FROM THE WETLAND ON BLM LANDS. REFUEL STATIONARY EQUIPMENT AS PER THE PROJECT'S SPILL PREVENTION PROCEDURES.
- INSTALL TEMPORARY SLOPE BREAKER UPSLOPE WITHIN 100 FEET OF WETLAND BOUNARY AS DIRECTED BY COMPANY.
- 4. RESTRICT ROOT GRUBBING TO ONLY THE AREA OVER THE DITCHLINE.
- TOPSOIL STRIPPING SHALL NOT BE REQUIRED IN SATURATED SOIL CONDITIONS.
- 6. UTILIZE AMPHIBIOUS EXCAVATORS (PONTOON MOUNTED BACKHOES) OR TRACKED BACKHOES SUPPORTED BY FABRICATED TIMBER MATS OR FLOATS TO EXCAVATE TRENCH. IF FABRICATED TIMBER MATS ARE USED FOR STABILIZATION, THE BACKHOE SHALL GRADUALLY MOVE ACROSS THE WETLAND/N.F. WATER BODY BY MOVING THE MAT FROM IMMEDIATELY BEHIND TO IMMEDIATELY IN FRONT OF THE BACKHOE'S PATH.
- AVOID ADJACTENT WETLANDS. INSTALL SEDIMENT BARRIERS AT EDGE OR R.O.W., IF PRACTICAL.
- 8. FABRICATE PIPE IN STAGING AREA IN THE EXTRA WORK SPACE AS INDICATED ON THE CONSTRUCTION DRAWINGS.
- LEAVE HARD PLUGS AT THE EDGE OF THE WETLAND UNTIL JUST PRIOR TO PIPE PLACEMENT.
- FLOAT PIPE IN PLACE, LOWER-IN INSTALL TRENCH PLUGS AT WETLAND EDGES WHERE REQUIRED AND BACKFILL IMMEDIATELY.
- REMOVE TIMBER MATS OR PREFABRICATED MATS OF NON-NATIVE MATERIAL FROM WETLANDS UPON COMPLETION.
- RESTORE GRADE TO NEAR PRE-CONSTRUCTION TOPOGRAPHY AND INSTALL PERMANENT EROSION CONTROL.
- 13. PIPE TO BE CONCRETE COATED FOR BUOYANCY CONTROL IF NECESSARY
- 14. TRENCH WIDTH VARIES DUE TO SOIL SLUFFING/SILTING. TRENCH DIMENSIONS ARE ASSUMED BASED ON OSHA TYPE C SOIL SLOPE REQUIREMENTS.
- DEPENDING ON WATER DEPTH, AN AMPHIBIOUS TRACK MOUNT EXCAVATOR OR BARGE MOUNT EXCAVATOR WILL BE USED.

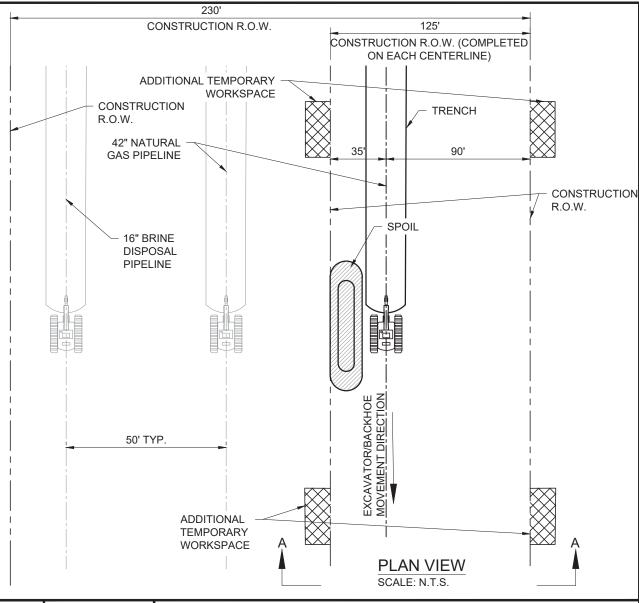

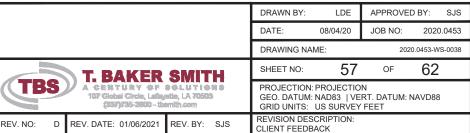

TYPICAL CONSTRUCTION WORKSPACES


SEMPRA LNG
LA STORAGE PROJECT
TYPICAL PUSH PULL CONSTRUCTION RIGHT-OF-WAY
OPEN WATER
TWO 42" NATURAL GAS PIPELINE AND ONE 16" BRINE PIPELINE
50' SPACING


 $\underset{\mathsf{SCALE: N.T.S.}}{\underline{\mathsf{SECTION}}} \ \mathsf{A-A:} \ \mathsf{AMPHIBIOUS} \ \mathsf{EXCAVATOR} \ \mathsf{INSTALLATION}$


	DRAWN BY:	LDE	APPROVE	DBY: S	SJS
	DATE:	08/04/20	JOB NO:	2020.0	153
	DRAWING NAI	ME:	2020	.0453-WS-00	38_
T. BAKER SMITH	SHEET NO:	58	OF	62	
TBS A CENTURY OF SOLUTIONS 107 Global Circle, Lafayette, LA 70503 (337)735-2000 - themith.com	PROJECTION: GEO. DATUM: GRID UNITS:	NAD83 VE	RT. DATUM: I	NAVD88	
REV. NO: E REV. DATE: 11/11/2021 REV. BY: CMB	REVISION DES				

TYPICAL CONSTRUCTION WORKSPACES

SEMPRA LNG
LA STORAGE PROJECT
TYPICAL PUSH PULL CONSTRUCTION RIGHT-OF-WAY
OPEN WATER
TWO 42" NATURAL GAS PIPELINE AND ONE 16" BRINE PIPELINE
50' SPACING

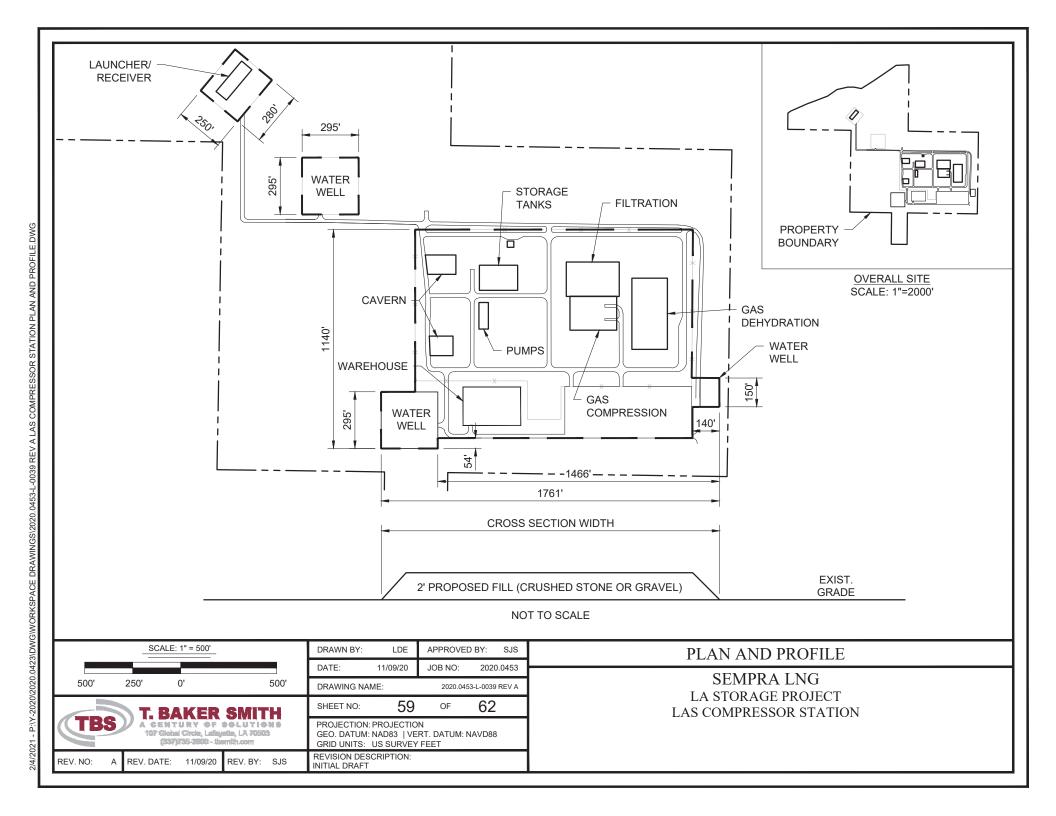

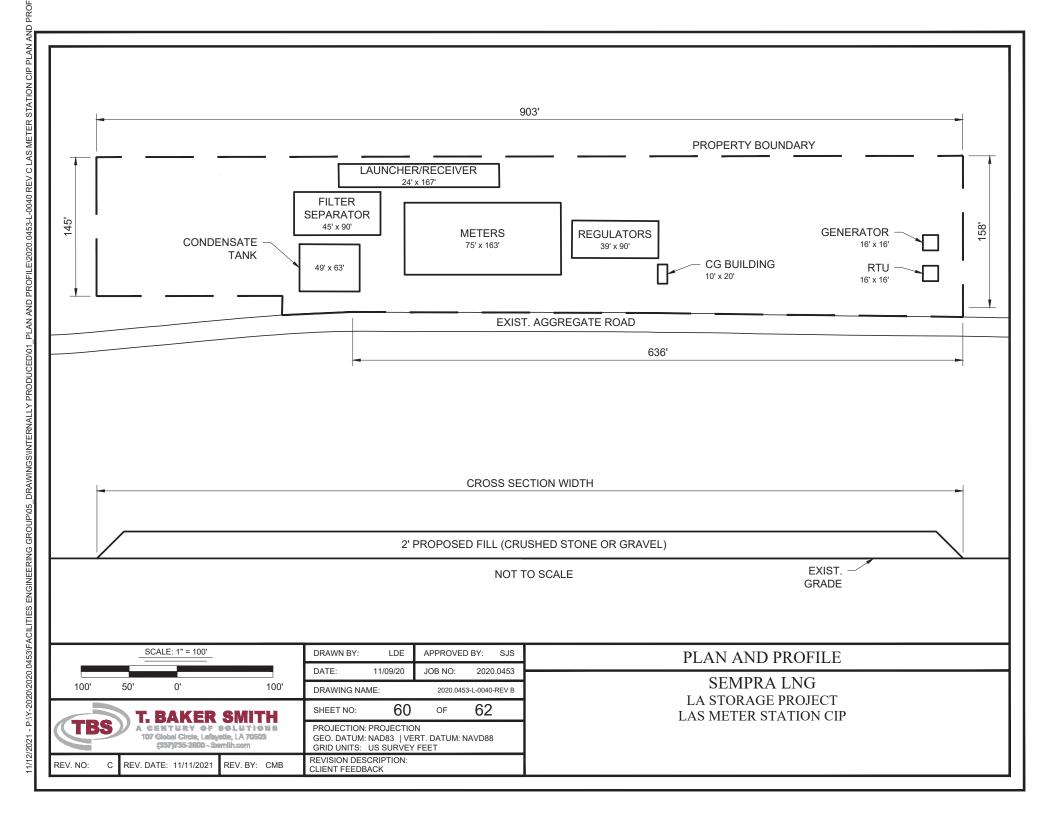

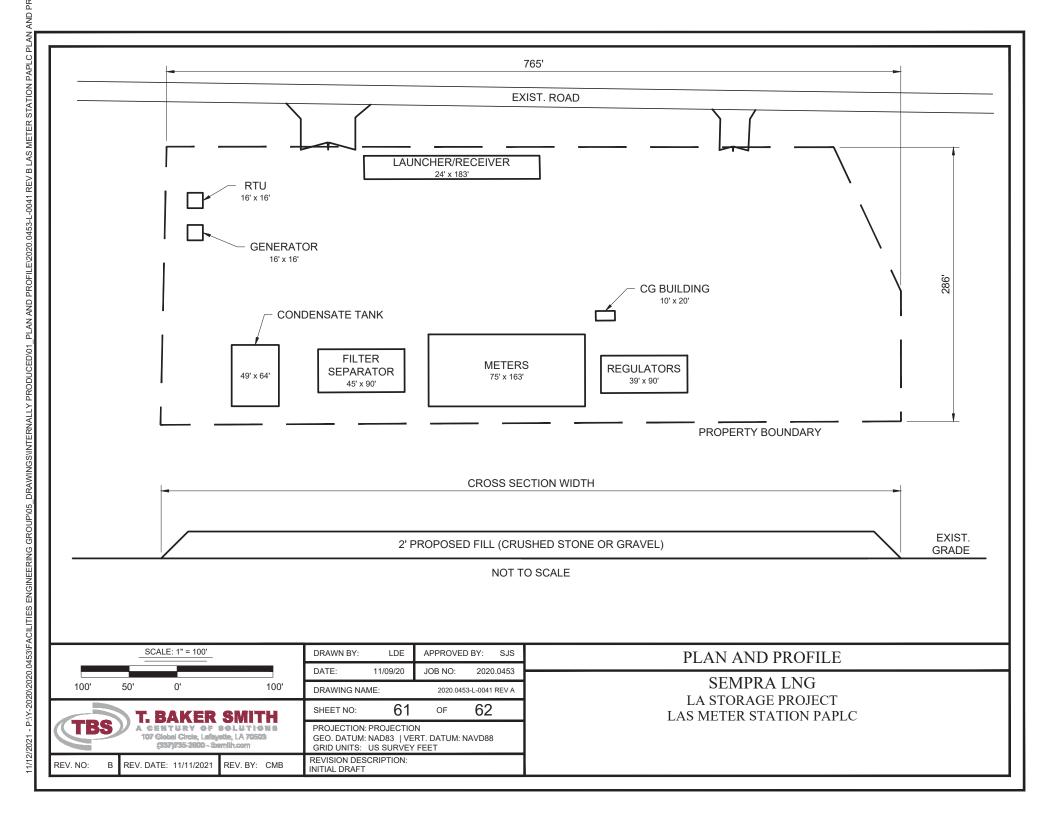

Acres of Wetlands within OCM Jurisdiction Affected by the **Hackberry Storage Project** Impact Type (Acres) **Total Acreage Total Impacted** Requiring Mitigation Acreage **Previously Mitigated** Temporary Permanent Conversion USACE New Orleans (Inside LA Coastal Zone) Wet Pasture 25.32 7.09 0.00 1.07 6.02 32.41 Fresh Marsh 0.00 0.03 0.00 0.00 0.03 0.03 Intermediate Marsh 52.61 0.61 0.00 0.00 0.61 53.22 Brackish Marsh 3.68 0.00 0.00 0.00 0.00 3.68 Scrub/Shrub Wetlands 7.68 0.00 1.10 0.00 1.10 8.78 Bottomland Hardwood Forest 0.00 0.00 0.00 0.00 0.00 0.00 89.29 1.10 1.07 7.76 98.12

Note: As requested by OCM, the Chinese tallow dominated wetlands near Axel Nelson Road (CAL-WL-042, CAL-WL-039, CAL-WL-035) are classified as wet pasture in the table above.

Acres of Wetlands under USACE Jurisdiction Affected by the Hackberry Storage Project									
		Impact	Total Acreage	Total Impacted					
	Temporary	Permanent	PFO/PSS Conversion	Previously Mitigated	Requiring Mitigation	Acreage			
USACE New Orleans (Outside LA Coastal Zone)									
Wet Pasture	40.17	1.00	0.00	0.00	1.00	41.17			
Fresh Marsh	0.05	0.00	0.00	0.00	0.00	0.05			
Scrub Shrub Wetlands	0.00	0.00	0.00	0.00	0.00	0.00			
Bottomland Hardwood Wetlands	0.90	0.00	0.38	0.00	1.28	1.28			
USACE New Orleans (Inside LA Coastal Zone)									
Wet Pasture	21.86	7.21	0.00	1.07	6.14	29.07			
Fresh Marsh	0.00	0.03	0.00	0.00	0.03	0.03			
Intermediate Marsh	52.61	0.61	0.00	0.00	0.61	53.22			
Brackish Marsh	3.68	0.00	0.00	0.00	0.00	3.68			
Scrub/Shrub Wetlands	7.18	2.25	0.54	0.00	2.79	9.97			
Bottomland Hardwood Forest	2.89	0.00	1.63	0.00	4.52	4.52			
Total	129.33	11.10	2.55	1.07	16.37	142.98			

Acres of Waters Affected by the Hackberry Storage Project				
	Impact Type (Acres)		Total Impacted	
	Temporary	Permanent	Acreage	
USACE New Orleans (Outside LA Coastal Zone)	1.21	0.78	1.99	
USACE New Orleans (Inside LA Coastal Zone)	164.77	0.22	164.99	
Fotal	165.98	1.00	166.98	

Rev: 03/02/2021

	DRAWN BY: ADM APPROVED BY: ADM		
	DATE: 2/8/2021 JOB NO: 2020.0453		
	DRAWING NAME: 20.0453_IT.DWG		
T. BAKER SMITH	SHEET NO: 62 OF 62		
TBS A CENTURY OF SOLUTIONS 107 Global Circle, Lafayette, LA 70503 (337)735-2800-thernith.com	PROJECTION: N/A GEO. DATUM: N/A VERT. DATUM: N/A GRID UNITS: US SURVEY FEET		
REV. NO: 02 REV. DATE: 3/5/2021 REV. BY: ADM	REVISION DESCRIPTION: UPDATED VALUES		

TABLE

SEMPRA LNG
LA STORAGE PROJECT
WETLAND AND WATERS IMPACTS TABLE