

# JOINT PUBLIC NOTICE

July 6, 2015

United States Army  
Corps of Engineers  
New Orleans District  
Regulatory Branch  
Post Office Box 60267  
New Orleans, Louisiana 70160-0267

(504) 862-1217  
Project Manager  
Kenny Blanke  
[Kenneth.G.Blanke@usace.army.mil](mailto:Kenneth.G.Blanke@usace.army.mil)  
MVN 2011-0949-CQ

State of Louisiana  
Department of Environmental Quality  
Water Quality Certifications Section  
Post Office Box 4313  
Baton Rouge, Louisiana 70821-4313

(225) 219-3225  
Project Manager  
Ms. Elizabeth Hill  
WQC Application Number  
WQC 150625-01

Interested parties are hereby notified that a permit application has been received by the New Orleans District of the U.S. Army Corps of Engineers pursuant to: [X] Section 10 of the Rivers and Harbors Act of March 3, 1899 (30 Stat. 1151; 33 USC 403); and/or [X] Section 404 of the Clean Water Act (86 Stat. 816; 33 USC 1344).

Application has also been made to the Louisiana Department of Environmental Quality, Office of Environmental Services, for a Water Quality Certification (WQC) in accordance with statutory authority contained in LRS30:2074 A(3), and provisions of Section 401 of the Clean Water Act (P.L.95-17).

## **FLOOD PROTECTION BERM TO PROTECT SOUTH VACHERIE IN SAINT JAMES PARISH**

**NAME OF APPLICANT:** St. James Parish Government, c/o T. Baker Smith, LLC, Attn: Michael Trahan, Post Office Box 2266, Houma, Louisiana 70361.

**LOCATION OF WORK:** Located in Sections 13 & 18, Township 13 South, Ranges 17 & 18 East, near South Vacherie, Louisiana, in SAINT JAMES Parish, as shown on the enclosed drawings (Latitude 29.952416 N Longitude -90.6917167 W). This project is located in USGS Hydrologic Unit Code (HUC) 08090301- East Central Louisiana Coastal HUC.

**CHARACTER OF WORK:** Clear, grade, excavate, place and maintain fill material for the construction of an approximate 1.4-mile long flood protection berm to protect South Vacherie from backwater flooding during high water events. Approximately 3.4 acres of the 6.8-acre project area are subject to the Corps of Engineers' jurisdiction. Approximately 3.3 acres of jurisdictional forested wetlands would be directly impacted by fill placement and approximately 0.04 acre of jurisdictional Other Waters of the United States would be directly avoided by the proposed project. Approximately 2,998 cubic yards of earthen fill material would be excavated onsite and approximately 21,350 cubic yards of hauled in earthen fill material are to be utilized during project construction and placed as fill in jurisdictional areas. The application has indicated that gated culverts will be installed along all existing water crossings of the proposed levee footprint. The applicant has claimed that the project has been designed to avoid and minimize impacts as much as possible. The applicant is proposing to compensate for the unavoidable impact by purchasing mitigation credits from an approved mitigation bank.

The comment period for the Department of the Army Permit and the Louisiana

Department of Environmental Quality WQC will close **20 days** from the date of this joint public notice. Written comments, including suggestions for modifications or objections to the proposed work, stating reasons thereof, are being solicited from anyone having interest in this permit and/or this WQC request and must be mailed so as to be received before or by the last day of the comment period. Letters concerning the Corps of Engineers permit application must reference the applicant's name and the Permit Application Number, and be mailed to the Corps of Engineers at the address above, **ATTENTION: REGULATORY BRANCH**. Individuals or parties may request an extension of time in which to comment on the proposed work by writing to the project manager or clicking on the project manager's name on the public notice grid on the web page. Any request must be specific and substantively supportive of the requested extension, and received by this office prior to the end of the initial comment period. The Section Chief will review the request and the requestor will be promptly notified of the decision to grant or deny the request. If granted, the time extension will be continuous to the initial comment period and, inclusive of the initial comment period, will not exceed a total of 30 calendar days. Letters concerning the Water Quality Certification must reference the applicant's name and the WQC Application number and be mailed to the Louisiana Department of Environmental Quality at the address above.

The application for this proposed project is on file with the Louisiana Department of Environmental Quality and may be examined during weekdays between 8:00 a.m. and 4:30 p.m. Copies may be obtained upon payment of costs of reproduction.

### **Corps of Engineers Permit Criteria**

The decision whether to issue a permit will be based on an evaluation of the probable impacts, including cumulative impacts of the proposed activity on the public interest. That decision will reflect the national concern for both protection and utilization of important resources. The benefit which reasonably may be expected to accrue from the proposal must be balanced against its reasonably foreseeable detriments. All factors which may be relevant to the proposal will be considered including the cumulative effects thereof; among those are conservation, economics, aesthetics, general environmental concerns, wetlands, historic properties, fish and wildlife values, flood hazards, floodplain values, land use, navigation, shoreline erosion and accretion, recreation, water supply and conservation, water quality, energy needs, safety, food and fiber production, mineral needs, considerations of property ownership and, in general, the needs and welfare of the people.

The U.S. Army Corps of Engineers is soliciting comments from the public, federal, state, and local agencies and officials, Indian Tribes, and other interested parties in order to consider and evaluate the impacts of this proposed activity. Any comments received will be considered by the U.S. Army Corps of Engineers to determine whether to make, modify, condition, or deny a permit for this proposal. To make this decision, comments are used to assess impacts on endangered species, historic properties, water quality, general environmental effects, and other public interest factors listed above. Comments are used in the preparation of an Environmental Assessment and/or an Environmental Impact Statement pursuant to the National Environmental Policy Act. Comments are also used to determine the need for a public hearing and to determine the overall public interest of the proposed activity.

The New Orleans District is unaware of properties listed on the National Register of Historic Places near the proposed work. The possibility exists that the proposed work may damage or destroy presently unknown archeological, scientific, prehistorical, historical sites, or data. Issuance of this public notice solicits input from the State Archeologist and State Historic Preservation Officer regarding potential impacts to cultural resources.

Our initial finding is that the proposed work would neither affect any species listed as endangered by the U.S. Departments of Interior or Commerce, nor affect any habitat designated as critical to the survival and recovery of any endangered species. Utilizing

Standard Local Operating Procedure for Endangered Species in Louisiana (SLOPES), dated October 22, 2014, between the U.S. Army Corps of Engineers, New Orleans and U.S. Fish and Wildlife Service, Ecological Services Office, the Corps has determined that the proposed activity would have no effect on any listed species.

This notice initiates the Essential Fish Habitat (EFH) consultation requirements of the Magnuson-Stevens Fishery Conservation and Management Act. The applicant's proposal would result in the destruction or alteration of NA acres of EFH utilized by various life stages of red drum and penaeid shrimp. Our initial determination is that the proposed action would not have a substantial adverse impact on EFH or federally managed fisheries in the Gulf of Mexico.

Our final determination relative to project impacts and the need for mitigation measures is subject to review by and coordination with the National Marine Fisheries Service.


If the proposed work involves deposits of dredged or fill material into navigable waters, the evaluation of the probable impacts will include the application of guidelines established by the Administrator of the Environmental Protection Agency. Also, a certification that the proposed activity will not violate applicable water quality standards will be required from the Department of Environmental Quality, Office of Environmental Services, before a permit is issued.


Any person may request, in writing, within the comment period specified in this notice, that a public hearing be held to consider this application. Requests for public hearings shall state, with particularity, the reasons for holding a public hearing.

You are requested to communicate the information contained in this notice to any other parties whom you deem likely to have interest in the matter.

JOHN M. HERMAN  
Chief, Central Evaluation Section  
Regulatory Branch


Enclosure

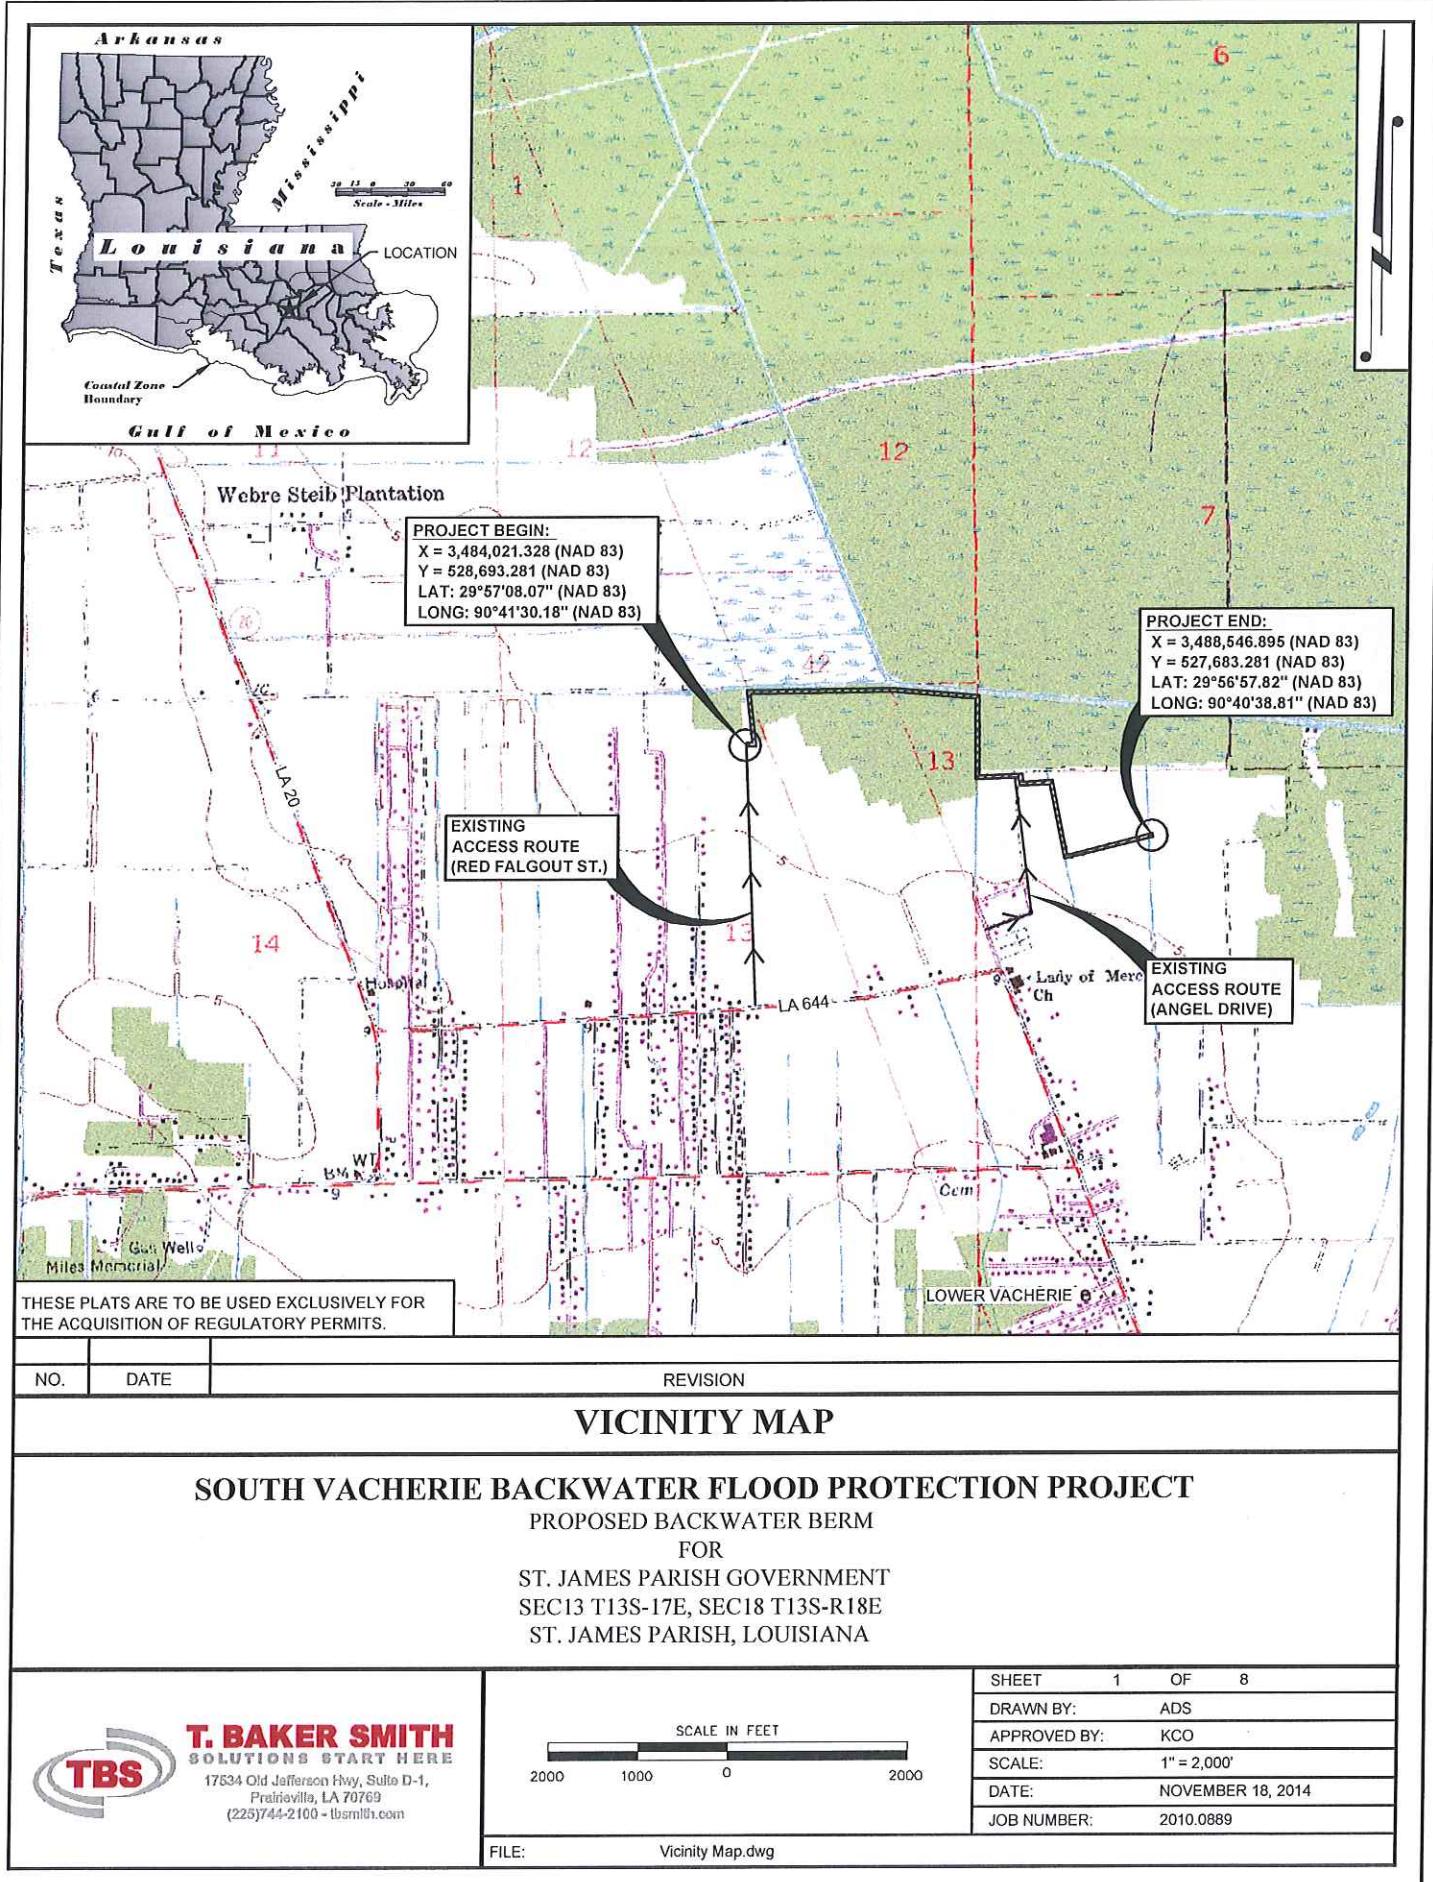

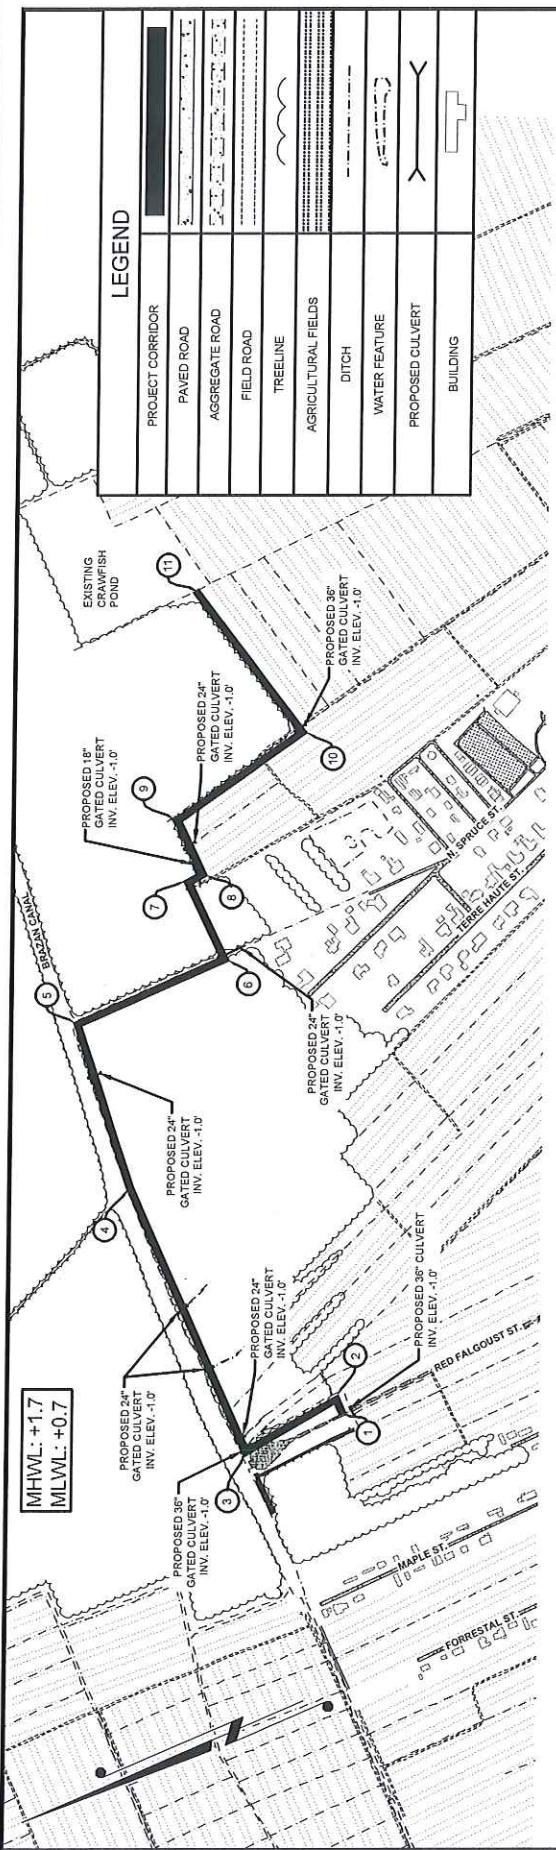

MHLW: +1.7  
MLMV: +0.7

SCALE

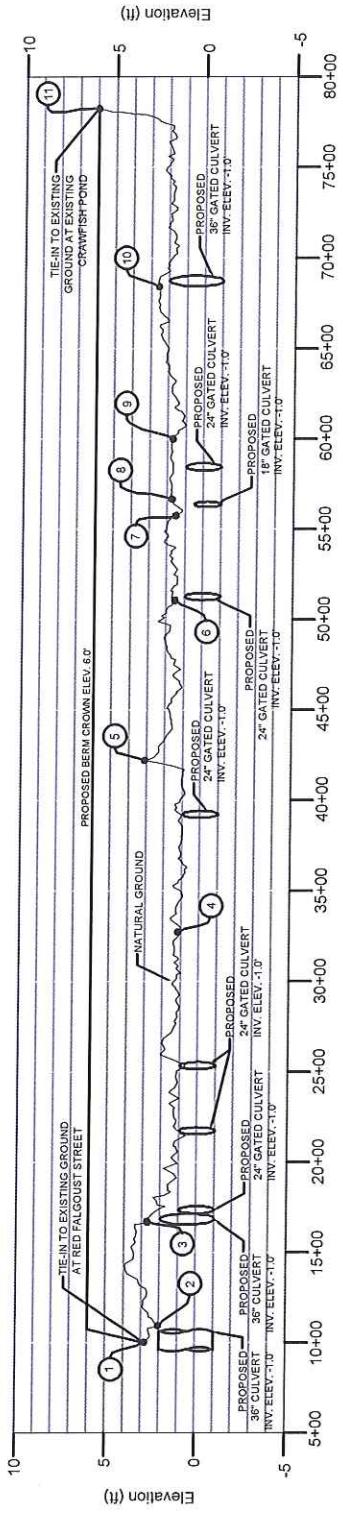

Elevation (ft)

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## **PLAN AND PROFILE**


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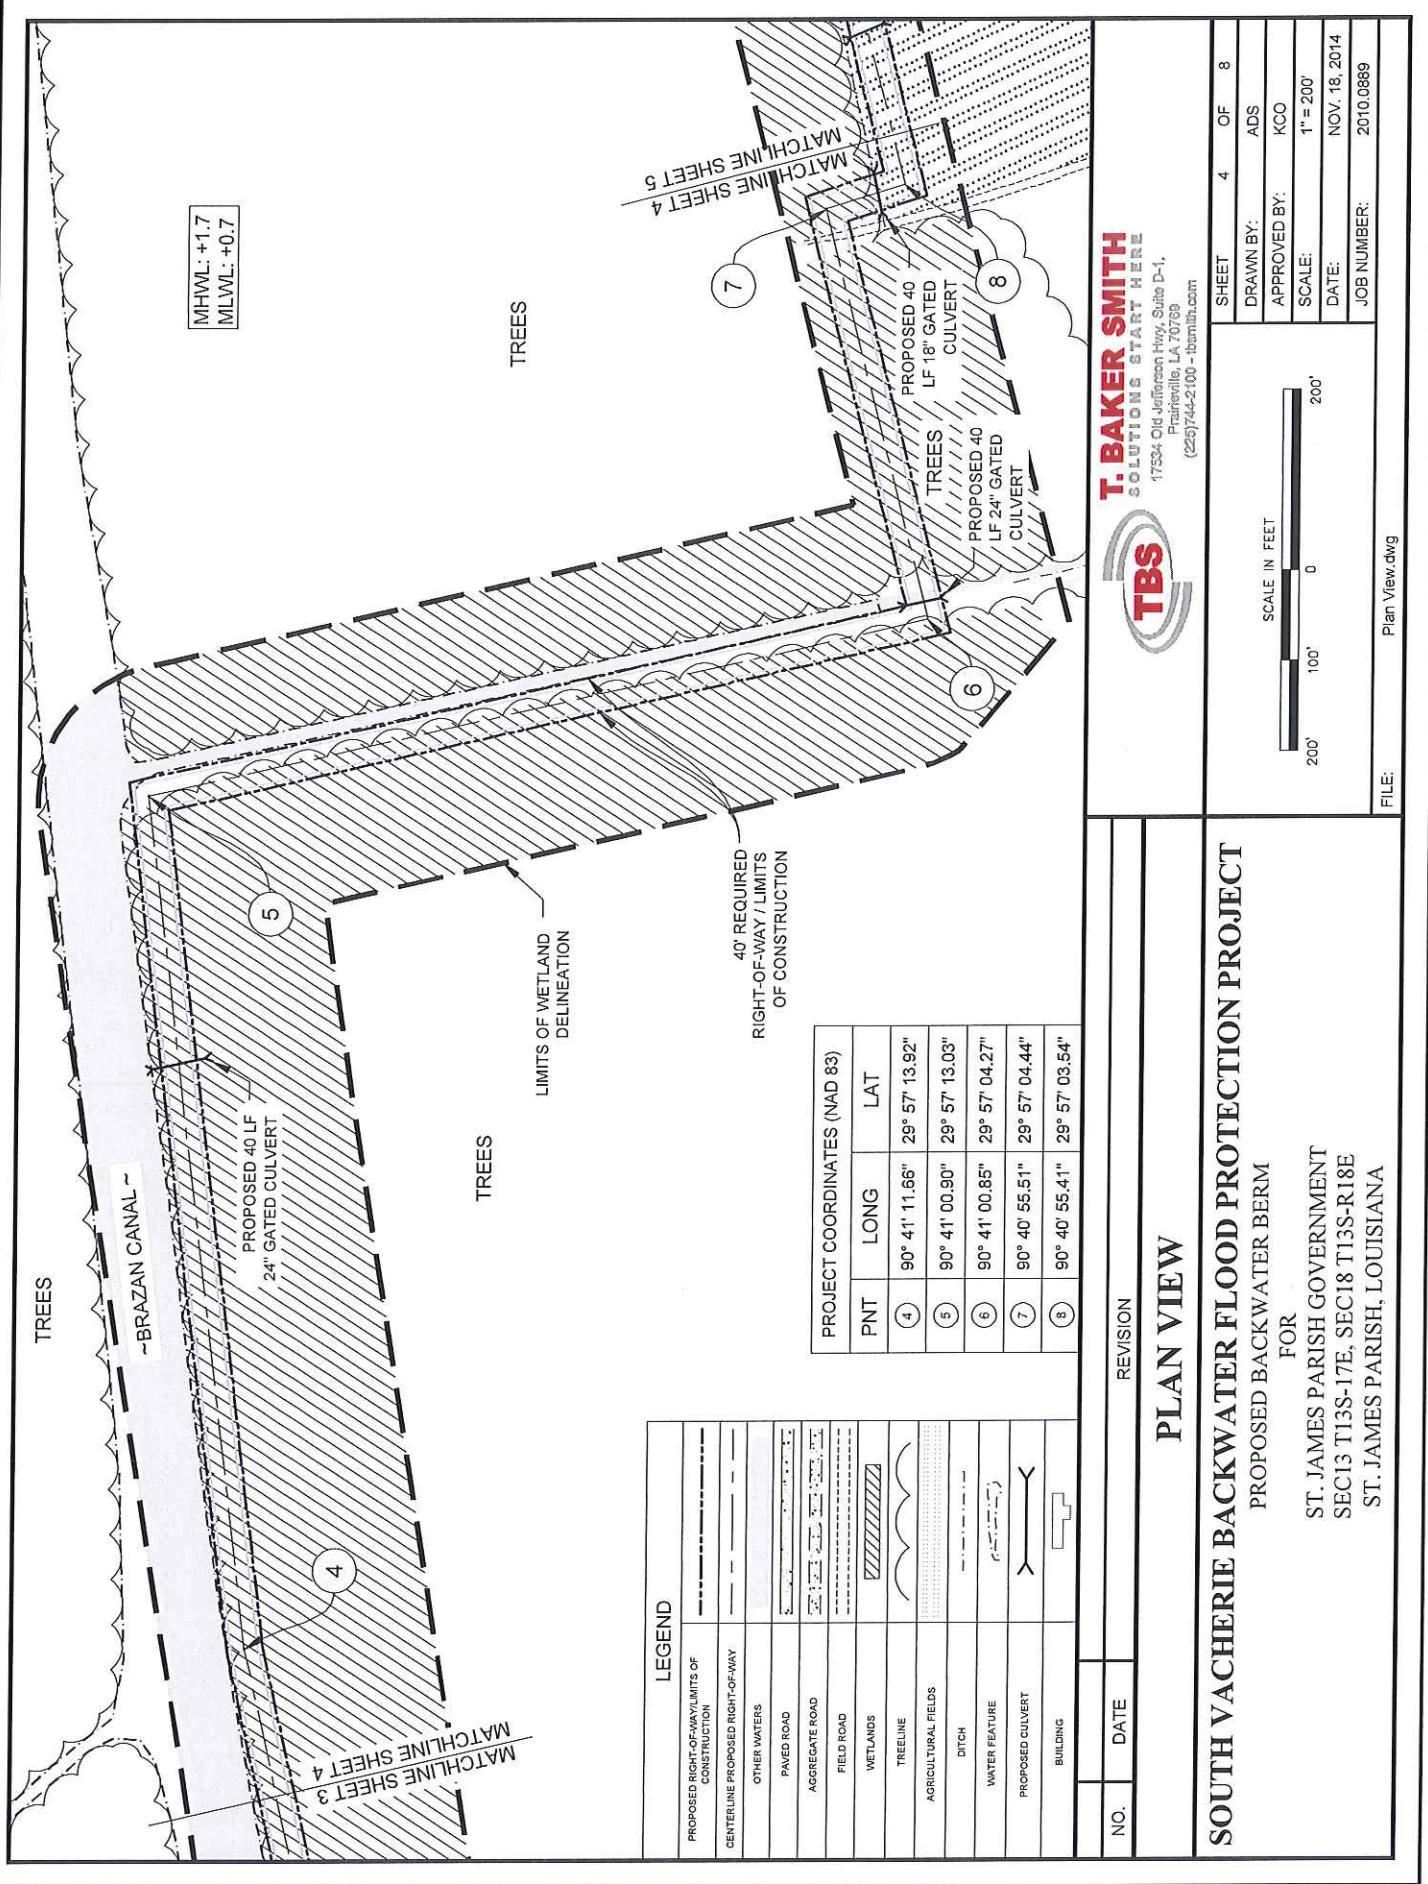
## **SOUTH VACHERIE BACKWATER FLOOD PROTECTION PROJECT**






**T. BAKER SMITH**  
SOLUTIONS START HERE  
11534 Old Jefferson Hwy, Suite D-1,  
Prairieville, LA 70769  
(225)744-2100 - tbsmith.com

NO.	DATE	REVISION
<b>PLAN AND PROFILE</b>		
<b>SOUTH VACHERIE BACKWATER FLOOD PROTECTION PROJECT</b>		
PROPOSED BACKWATER BERM		
FOR		
ST. JAMES PARISH GOVERNMENT SEC13 T13S-17E, SEC18 T13S-R18E ST. JAMES PARISH, LOUISIANA		
 <b>T. BAKER SMITH</b> SOLUTIONS START HERE 17534 Old Jefferson Hwy, Suite D-4, Prairieville, LA 70769 (225)744-2100 - tbsmith.com		
 <b>SCALE IN FEET</b> 500' 250' 0 500'		
SHEET	2	OF 8
DRAWN BY:	ADS	
APPROVED BY:	KCO	
SCALE:	1" = 100'	
DATE:	NOV. 18, 2014	
JOB NUMBER:	2010.0889	
FILE:	Plan and Profile.dwg	



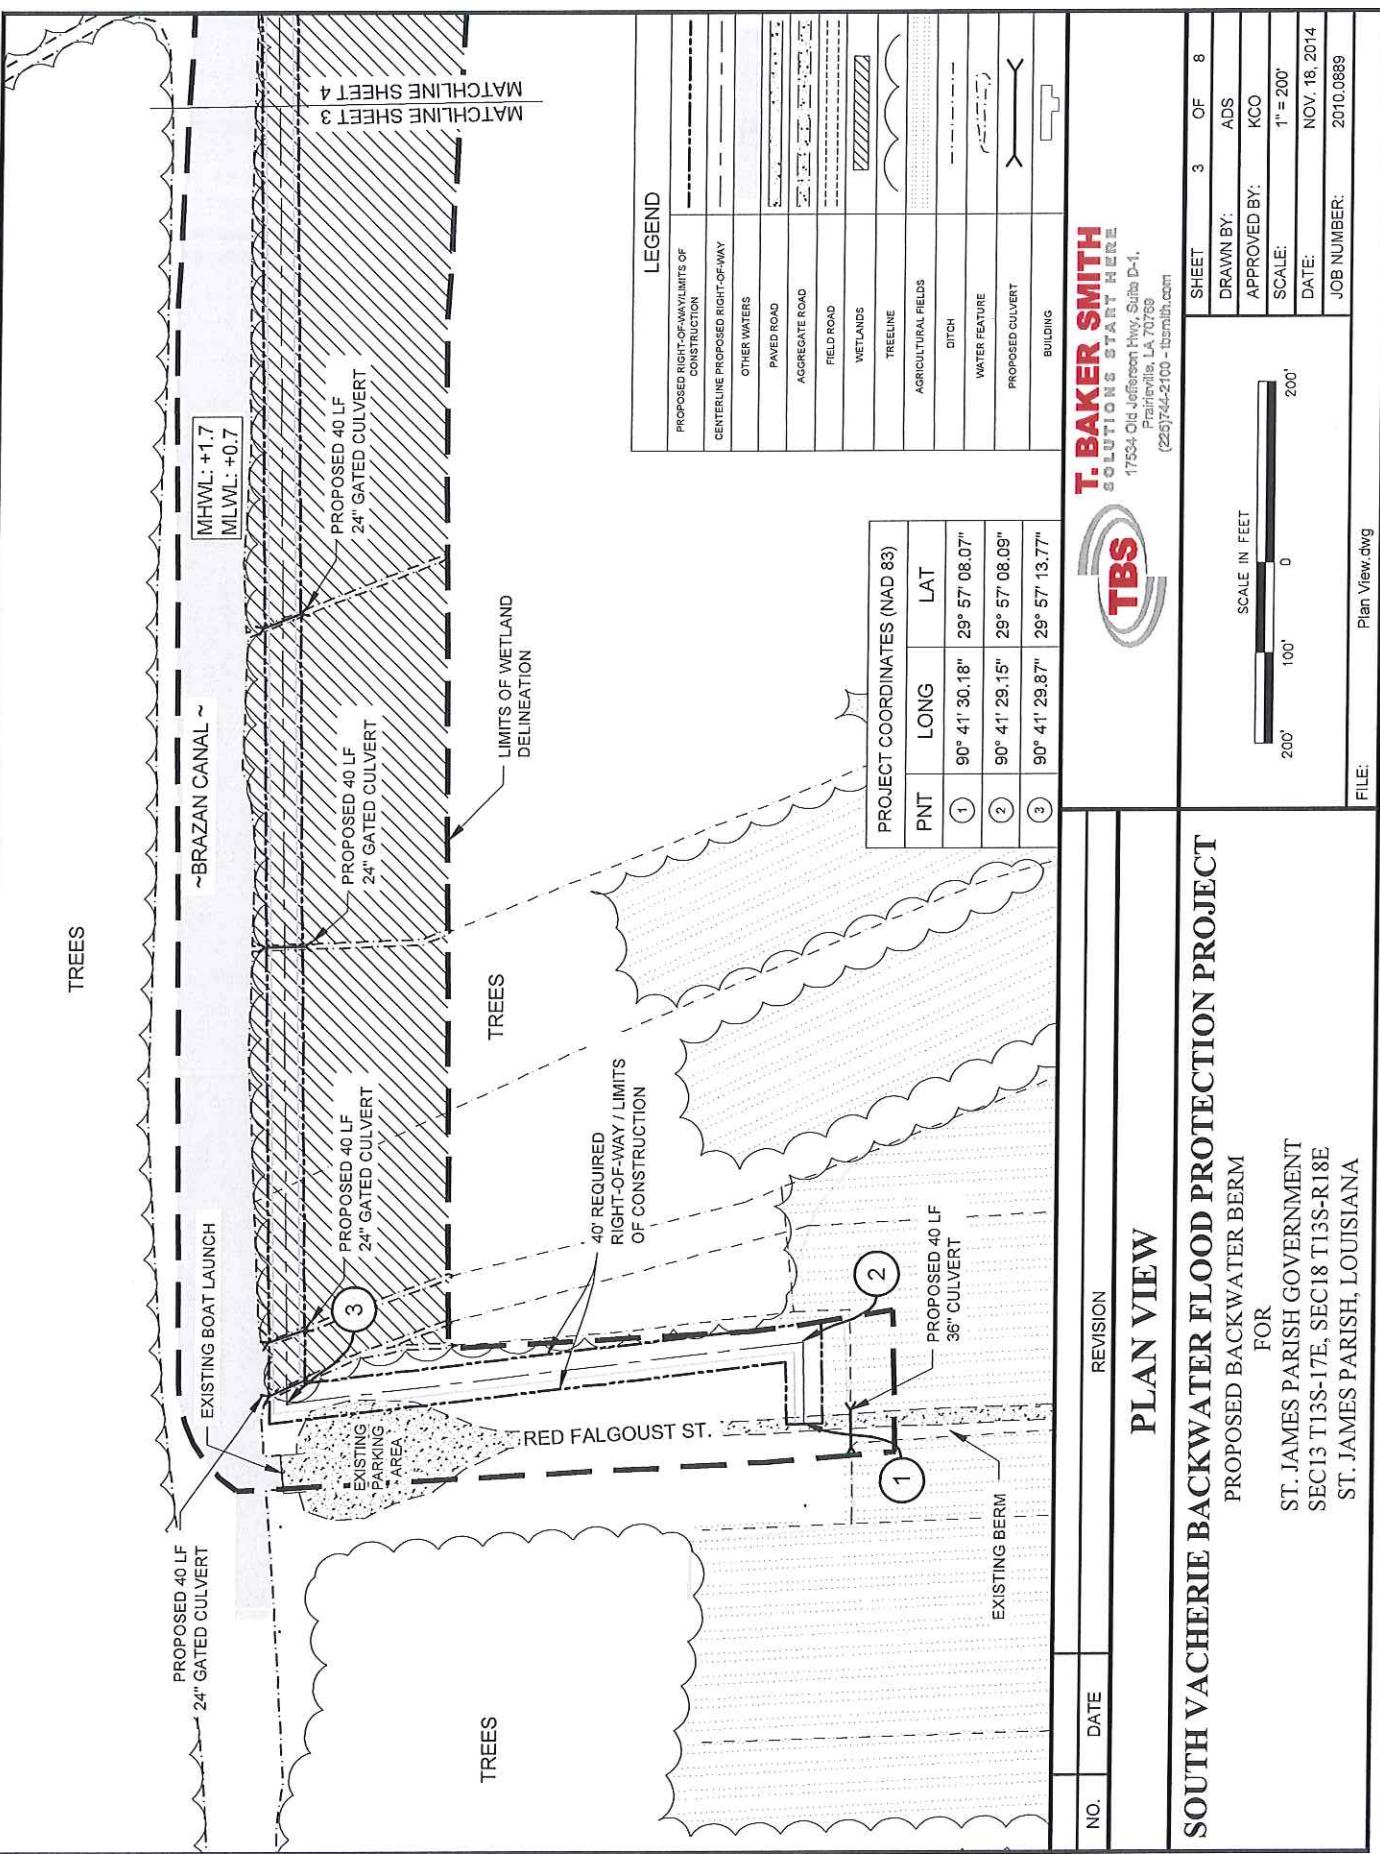

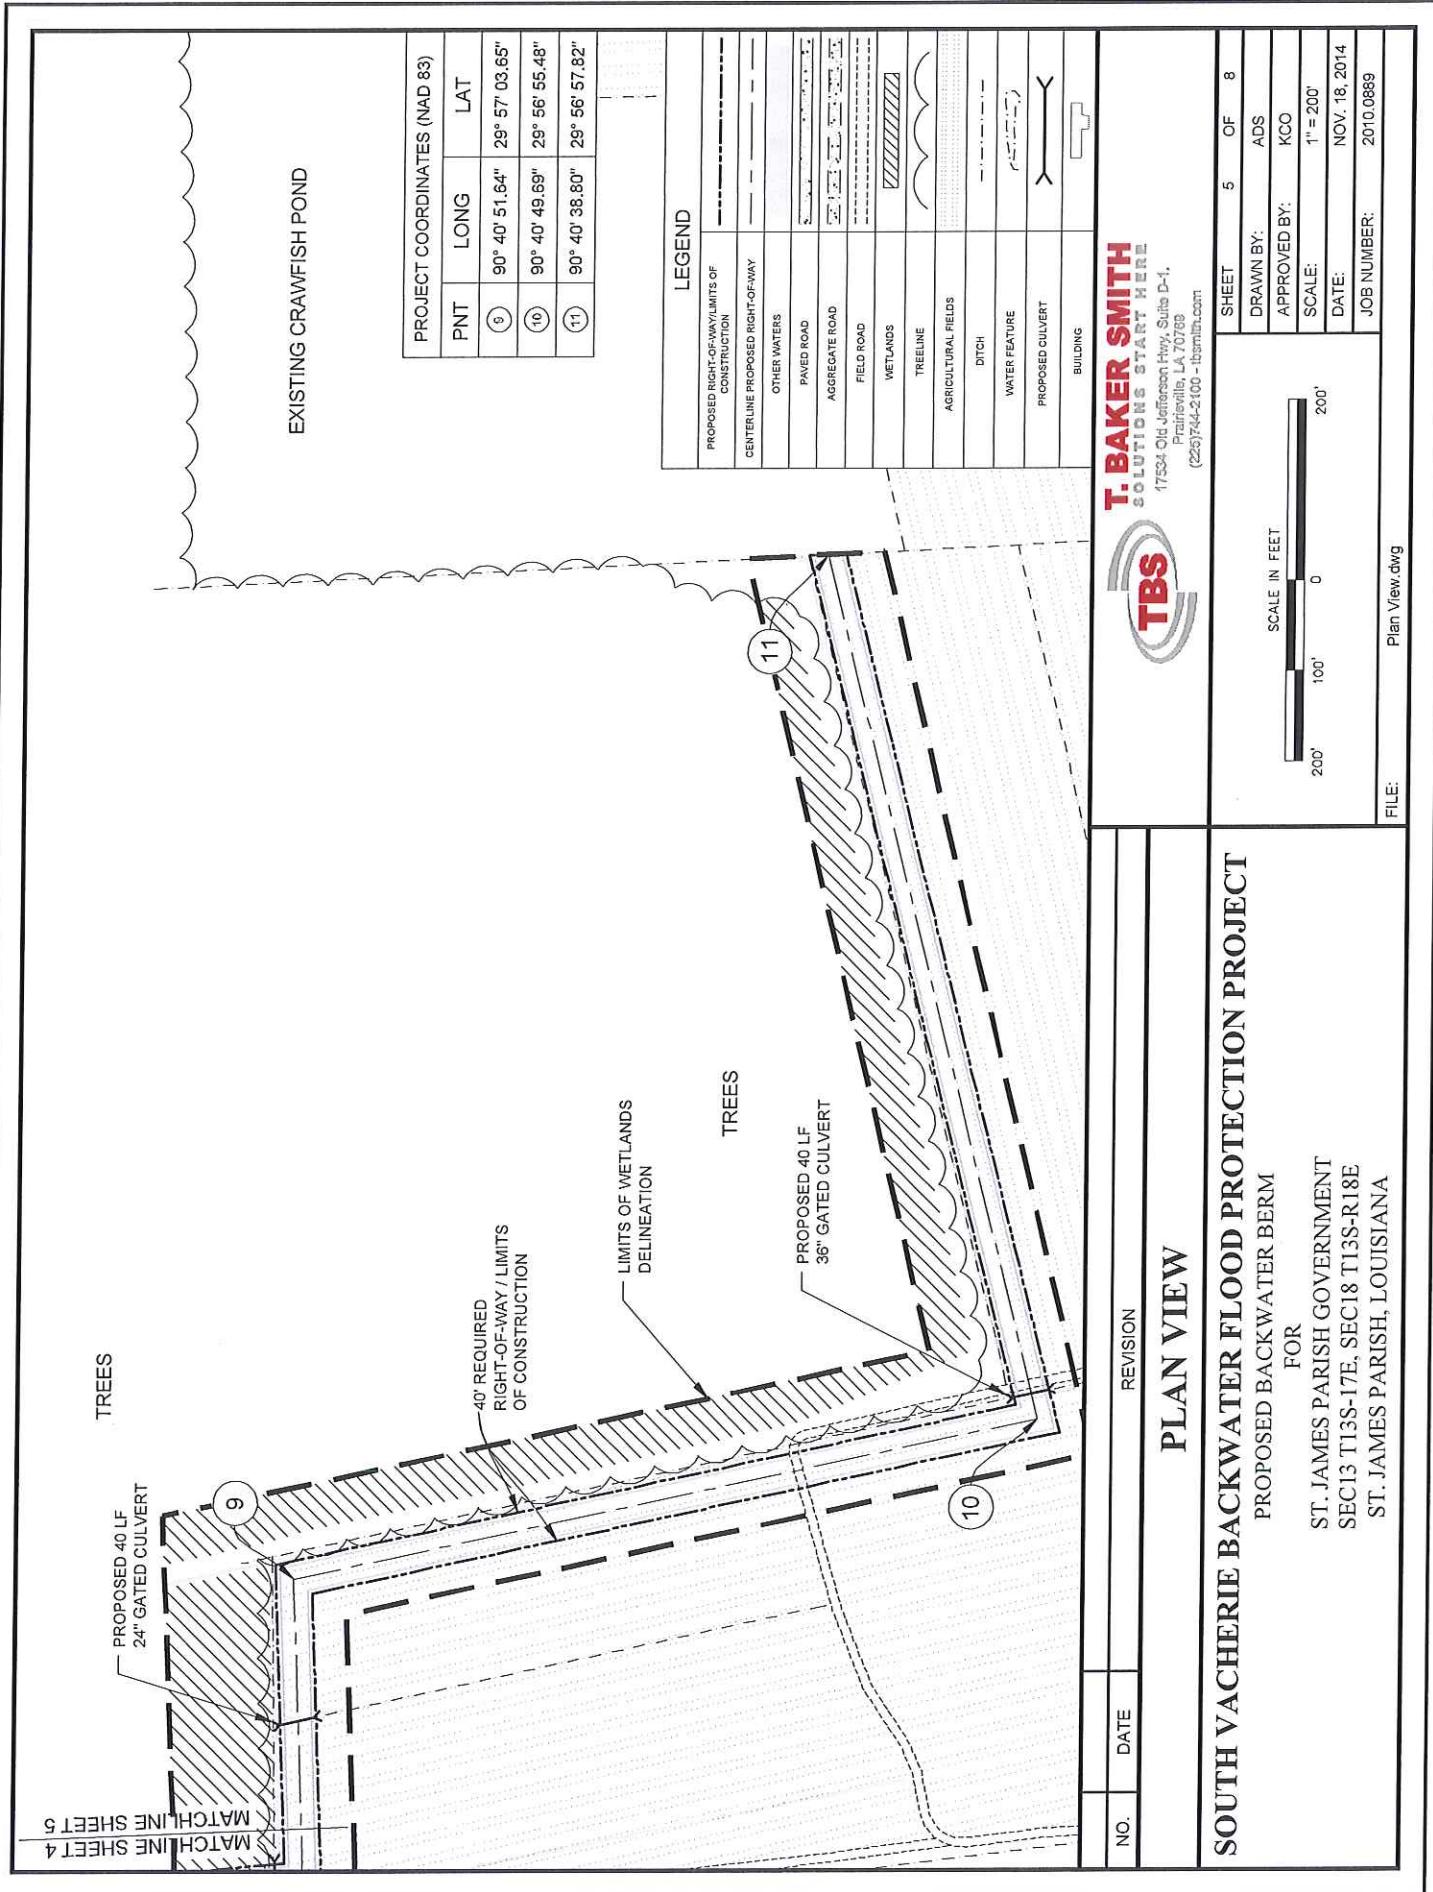


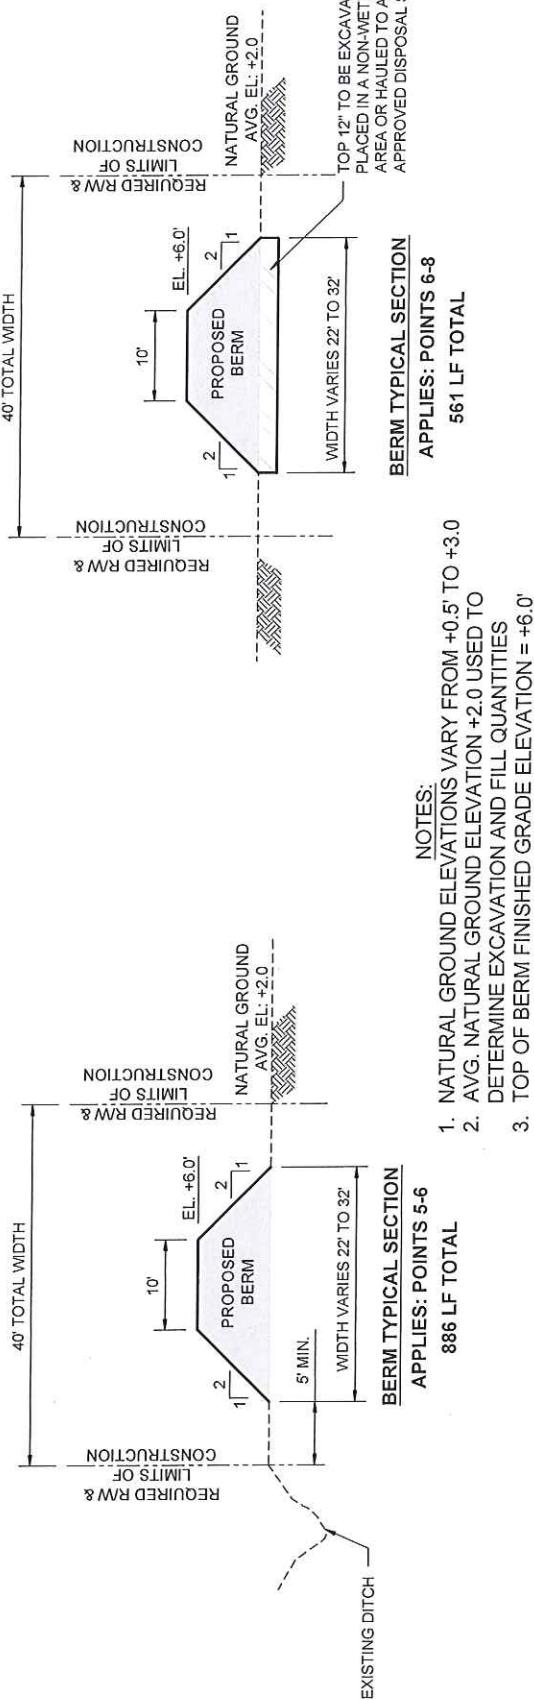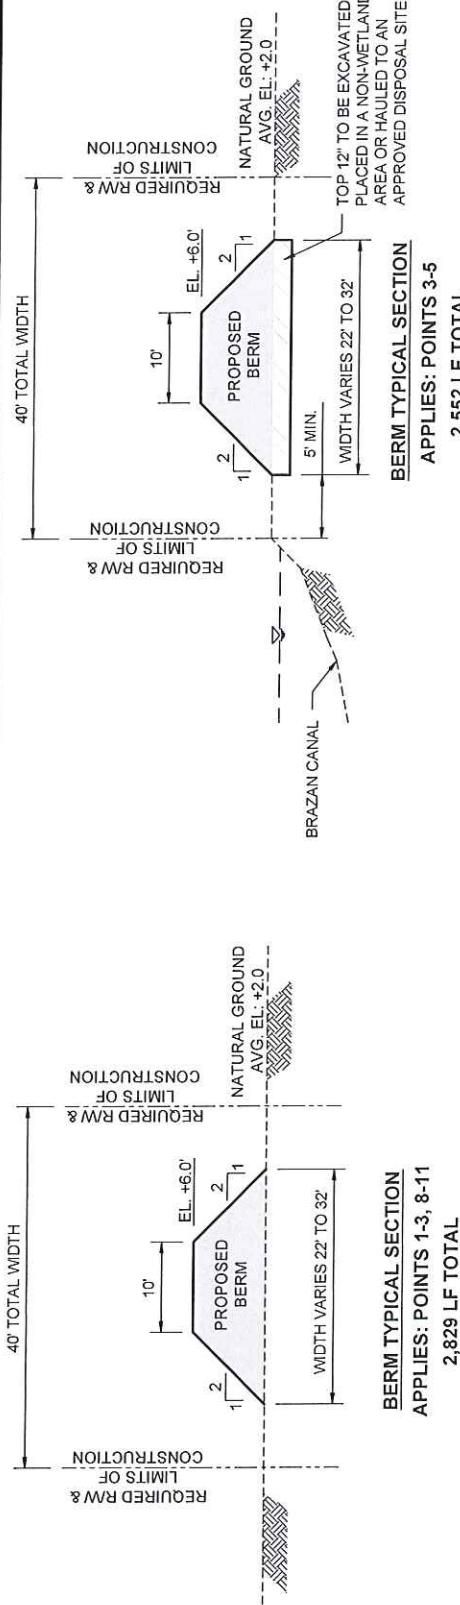

NO.	DATE	REVISION
<b>TYPICAL SECTIONS</b>		

**SOUTH VACHERIE BACKWATER FLOOD PROTECTION PROJECT**  
PROPOSED BACKWATER BERM  
FOR  
ST. JAMES PARISH GOVERNMENT  
SEC13 T13S-17E, SEC18 T13S-R18E  
ST. JAMES PARISH, LOUISIANA

<b>T. BAKER SMITH</b> <b>SOLUTIONS START HERE</b> 17534 Old Jefferson Hwy, Suite C-1, Prairieville, LA 70769 (225)744-2100 tbsmith.com	
FILE: Typical Section.dwg	SHEET 6 OF 8
DRAWN BY: ADS	APPROVED BY: KCO
SCALE: N.T.S.	DATE: DEC. 29, 2014
JOB NUMBER: 2010.0869	

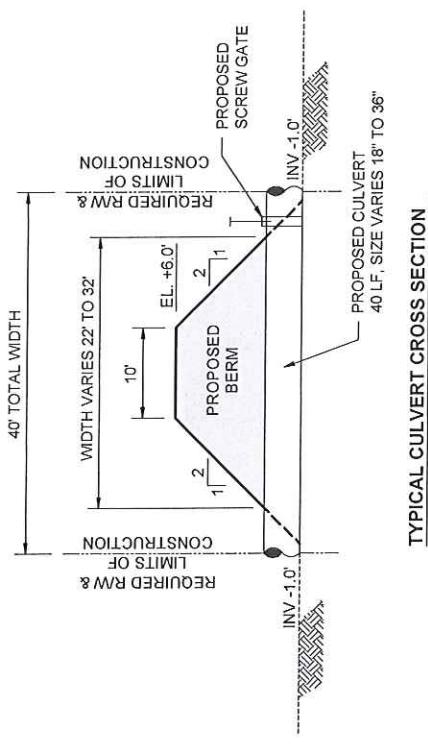

TYPICAL CULVERT CROSS SECTION



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Prairieville, LA 70769

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SHEET 7 OF 8

DRAWN BY:	ADS
APPROVED BY:	KCO
SCALE:	N.T.S.
DATE:	NOV. 18, 2014
JOB NUMBER:	2010.0869

FILE: Typical Section.dwg

**TYPICAL SECTIONS**

SOUTH VACHERIE BACKWATER FLOOD PROTECTION PROJECT		
NO.	DATE	REVISION
PROPOSED BACKWATER BERM FOR ST. JAMES PARISH GOVERNMENT SEC13 T13S-17E, SEC18 T13S-R18E ST. JAMES PARISH, LOUISIANA		

**COASTAL NOTES:**

IN ORDER TO ENSURE THE SAFETY OF ALL PARTIES, THE PERMITTEE SHALL CONTACT THE LOUISIANA ONE CALL SYSTEM (1-800-272-3020) A MINIMUM OF 48 HOURS PRIOR TO THE COMMENCEMENT OF ANY EXCAVATION (DIGGING, DREDGING, JETTING, ETC.) OR DEMOLITION ACTIVITY.

THE PERMITTEE SHALL ALSO CONTACT OTHER GOVERNMENTAL ENTITIES THAT MAY HAVE OPTED OUT OF THE ONE CALL PROGRAM . THESE GOVERNMENTAL ENTITIES MAY HAVE OPERATIONS LOCATED IN THE AREA OF THIS PROJECT.

ALL STRUCTURES WILL BE MARKED AND LIGHTED IN ACCORDANCE WITH U.S. COAST GUARD REGULATIONS.

**NOTES:**

1. IMPACTED TREES TO BE CHIPPED AND HAULED OFF TO AN APPROVED DISPOSAL SITE.
2. EQUIPMENT TO BE USED: BULLDOZER, BACKHOE, DUMP TRUCKS, AND EXCAVATOR.

**GATE OPERATIONAL PLAN:**

ST. JAMES PARISH GOVERNMENT WILL BE RESPONSIBLE FOR OPERATING AND MAINTAINING CULVERT GATES. CLOSING THE GATES SHALL BE DETERMINED BY MONITORING THE COASTWIDE REFERENCE MONITORING SYSTEM (CRMS) STATION 3136-H01 (WWW.LACOAST.GOV/CRMS) AT THE EASTERN END OF BRAZAN CANAL WHERE IT ENTERS LAC DES ALLEMANDS. ONCE THE WATER LEVEL READING EXCEEDS THE 90% WATER LEVEL (APPROXIMATELY EL +2.0' NAVD88) THE PARISH SHALL EVALUATE THE NEED TO CLOSE THE GATES BASED ON CURRENT WEATHER FORECAST AND EXPECTED IMPACTS ON WATER LEVELS IN LAC DES ALLEMANDS. IF CONDITIONS INDICATE THE WATER LEVELS WILL CONTINUE TO RISE, THE GATES WILL BE CLOSED. GATES WILL REMAIN CLOSED UNTIL WATER LEVELS IN BRAZAN CANAL ARE TRENDING DOWN AND HAVE RECEDED BELOW EL +2.0' NAVD88 OR UNTIL WATER FROM THE PROTECTED SIDE OF THE BERM CAN BE DRAINED BY GRAVITY INTO THE CANAL, WHICH EVER CONDITION COMES FIRST.

**SUMMARY OF IMPACTS**

	AREA OF EXCAVATION (AC)	VOLUME OF EXCAVATION (CY)	AREA OF FILL (AC)	VOLUME OF FILL (CY)
WETLANDS	3.17	2,998	2.08	11,299
OTHER WATERS	0	0	0.04	144
NON-WETLANDS	0	0	1.95	9,907
TOTAL	3.17	2,998	4.07	21,350

**SUMMARY OF IMPACTS:**

1. A TOTAL OF 2,998 CUBIC YARDS OF NATIVE MATERIAL WILL BE EXCAVATED AND HAULED OFF TO AN APPROVED DISPOSAL SITE.
2. APPROXIMATELY 3.17 ACRES OF WETLANDS WILL BE PERMANENTLY IMPACTED BY THIS PROJECT.
3. APPROXIMATELY 0.04 ACRES OF OTHER WATERS WILL BE PERMANENTLY IMPACTED BY THIS PROJECT.

<b>SOUTH VACHERIE BACKWATER FLOOD PROTECTION PROJECT</b> PROPOSED BACKWATER BERM FOR ST. JAMES PARISH GOVERNMENT SEC13 T13S-17E, SEC18 T13S-R18E ST. JAMES PARISH, LOUISIANA		<b>QUANTITIES &amp; NOTES</b>	
		NO.	DATE
		<b>T. BAKER SMITH</b> SOLUTIONS START HERE 17534 Old Jefferson Hwy, Suite D-1, Prairieville, LA 70769 (225)744-2100 - tbsmith.com	
		SHEET	8 OF 8
		DRAWN BY:	ADS
		APPROVED BY:	KCO
		SCALE:	N.T.S.
		DATE:	DEC. 29, 2014
		JOB NUMBER:	2010.0889
		FILE:	Notes.dwg