

JOINT PUBLIC NOTICE

October 19, 2015

United States Army
Corps of Engineers
New Orleans District
Regulatory Branch
Post Office Box 60267
New Orleans, Louisiana 70160-0267

(504) 862-2225
Brad.LaBorde@usace.army.mil
Project Manager
Brad LaBorde
Permit Application Number
MVN 2014-2481 EOO

State of Louisiana
Department of Environmental Quality
ATTN: Water Quality Certifications
Post Office Box 4313
Baton Rouge, Louisiana 70821-4313

(225) 219-3225
Project Manager
Elizabeth Hill
WQC Application Number
WQC 151014-01

Interested parties are hereby notified that a permit application has been received by the New Orleans District of the U.S. Army Corps of Engineers pursuant to: [X] Section 10 of the Rivers and Harbors Act of March 3, 1899 (30 Stat. 1151; 33 USC 403); and/or [X] Section 404 of the Clean Water Act (86 Stat. 816; 33 USC 1344).

Application has also been made to the Louisiana Department of Environmental Quality, Water Quality Certifications, for a Water Quality Certification (WQC) in accordance with statutory authority contained in LRS30:2047 A(3), and provisions of Section 401 of the Clean Water Act (P.L.95-17).

Drainage Improvements in Covington, Louisiana

NAME OF APPLICANT: Saint Tammany Parish Government, Attn: David Brunet, 21415 Koop Drive, Mandeville, Louisiana, 70471.

LOCATION OF WORK: North of Pine Oak Drive and adjacent to the Abita River, in Covington, Louisiana, Saint Tammany Parish, as shown on the enclosed drawings.

Latitude: 30.46905, Longitude: -90.06479
Hydrologic Unit Code: 08090201 – Liberty Bayou-Tchefuncta

CHARACTER OF WORK: The applicant proposes to clear, grade, excavate, and deposit fill for construction of a drainage lateral. The project will utilize both subsurface drainage and open cut ditches. Construction would include excavation of 0.1 acres of jurisdictional wetlands for the drainage conveyance and depositing 7 cubic yards of limestone with a geotextile fabric along the discharge area at the Abita River. The applicant will offset any unavoidable losses to wetland functions by purchasing the required credits from an approved compensatory mitigation bank.

The comment period for the Department of the Army Permit and the Louisiana Department of Environmental Quality WQC will close **20 days** from the date of this joint public notice. Written comments, including suggestions for modifications or objections to the proposed work, stating reasons thereof, are being solicited from anyone having interest in this permit and/or this WQC request and must be mailed so as to be received before or by the last day of the comment period. Letters concerning the Corps of Engineers permit application must reference the applicant's name and the Permit Application Number, and be mailed to the Corps of Engineers at the address above,

ATTENTION: REGULATORY BRANCH. Individuals or parties may request an extension of time in which to comment on the proposed work by writing or e-mailing the Corps of Engineers Project Manager listed above. Any request must be specific and substantively supportive of the requested extension, and received by this office prior to the end of the initial comment period. The Section Chief will review the request and the requestor will be promptly notified of the decision to grant or deny the request. If granted, the time extension will be continuous to the initial comment period and, inclusive of the initial comment period, will not exceed a total of 30 calendar days.

The application for this proposed project is on file with the Louisiana Department of Environmental Quality and may be examined during weekdays between 8:00 a.m. and 4:30 p.m. Copies may be obtained upon payment of costs of reproduction.

Corps of Engineers Permit Criteria

The decision whether to issue a permit will be based on an evaluation of the probable impacts, including cumulative impacts of the proposed activity on the public interest. That decision will reflect the national concern for both protection and utilization of important resources. The benefit which reasonably may be expected to accrue from the proposal must be balanced against its reasonably foreseeable detriments. All factors which may be relevant to the proposal will be considered including the cumulative effects thereof; among those are conservation, economics, aesthetics, general environmental concerns, wetlands, historic properties, fish and wildlife values, flood hazards, floodplain values, land use, navigation, shoreline erosion and accretion, recreation, water supply and conservation, water quality, energy needs, safety, food and fiber production, mineral needs, considerations of property ownership and, in general, the needs and welfare of the people.

The U.S. Army Corps of Engineers is soliciting comments from the public, federal, state, and local agencies and officials, Indian Tribes, and other interested parties in order to consider and evaluate the impacts of this proposed activity. Any comments received will be considered by the U.S. Army Corps of Engineers to determine whether to make, modify, condition, or deny a permit for this proposal. To make this decision, comments are used to assess impacts on endangered species, historic properties, water quality, general environmental effects, and other public interest factors listed above. Comments are used in the preparation of an Environmental Assessment and/or an Environmental Impact Statement pursuant to the National Environmental Policy Act. Comments are also used to determine the need for a public hearing and to determine the overall public interest of the proposed activity.

The New Orleans District is unaware of properties listed on the National Register of Historic Places near the proposed work. The possibility exists that the proposed work may damage or destroy presently unknown archeological, scientific, prehistorical, historical sites, or data. Issuance of this public notice solicits input from the State Archeologist and State Historic Preservation Officer regarding potential impacts to cultural resources.

Our initial finding is that the proposed work would neither affect any species listed as endangered by the U.S. Department of Commerce, nor affect any habitat designated as critical to the survival and recovery of any endangered species.

Utilizing Standard Local Operating Procedure for Endangered Species in Louisiana (SLOPES), dated October 22, 2014, between the U.S. Army Corps of Engineers, New Orleans and the U.S. Fish and Wildlife Service, Ecological Services Office, the Corps has determined that the proposed activity would have no effect on any listed species.

This notice initiates the Essential Fish Habitat (EFH) consultation requirements of the Magnuson-Stevens Fishery Conservation and Management Act. The applicant's proposal would result in the destruction or alteration of **N/A** acres of EFH utilized by various life stages of red drum and penaeid shrimp. Our initial determination is that the proposed action would not have a substantial adverse impact on EFH or federally managed fisheries in the Gulf of Mexico. Our final determination relative to project impacts and the need for mitigation measures is subject to review by and coordination with the National Marine Fisheries Service.

If the proposed work involves deposits of dredged or fill material into navigable waters, the evaluation of the probable impacts will include the application of guidelines established by the Administrator of the Environmental Protection Agency. Also, a certification that the proposed activity will not violate applicable water quality standards will be required from the Department of Environmental Quality, Water Quality Certifications, before a permit is issued.

Any person may request, in writing, within the comment period specified in this notice, that a public hearing be held to consider this application. Requests for public hearings shall state, with particularity, the reasons for holding a public hearing.


You are requested to communicate the information contained in this notice to any other parties whom you deem likely to have interest in the matter.

Michael V. Farabee
Chief, Eastern Evaluation Section

Enclosure

MVN-2014-2481-EOO

St. Tammany Parish Govt.
Pine Oak Dr. drainage improvements

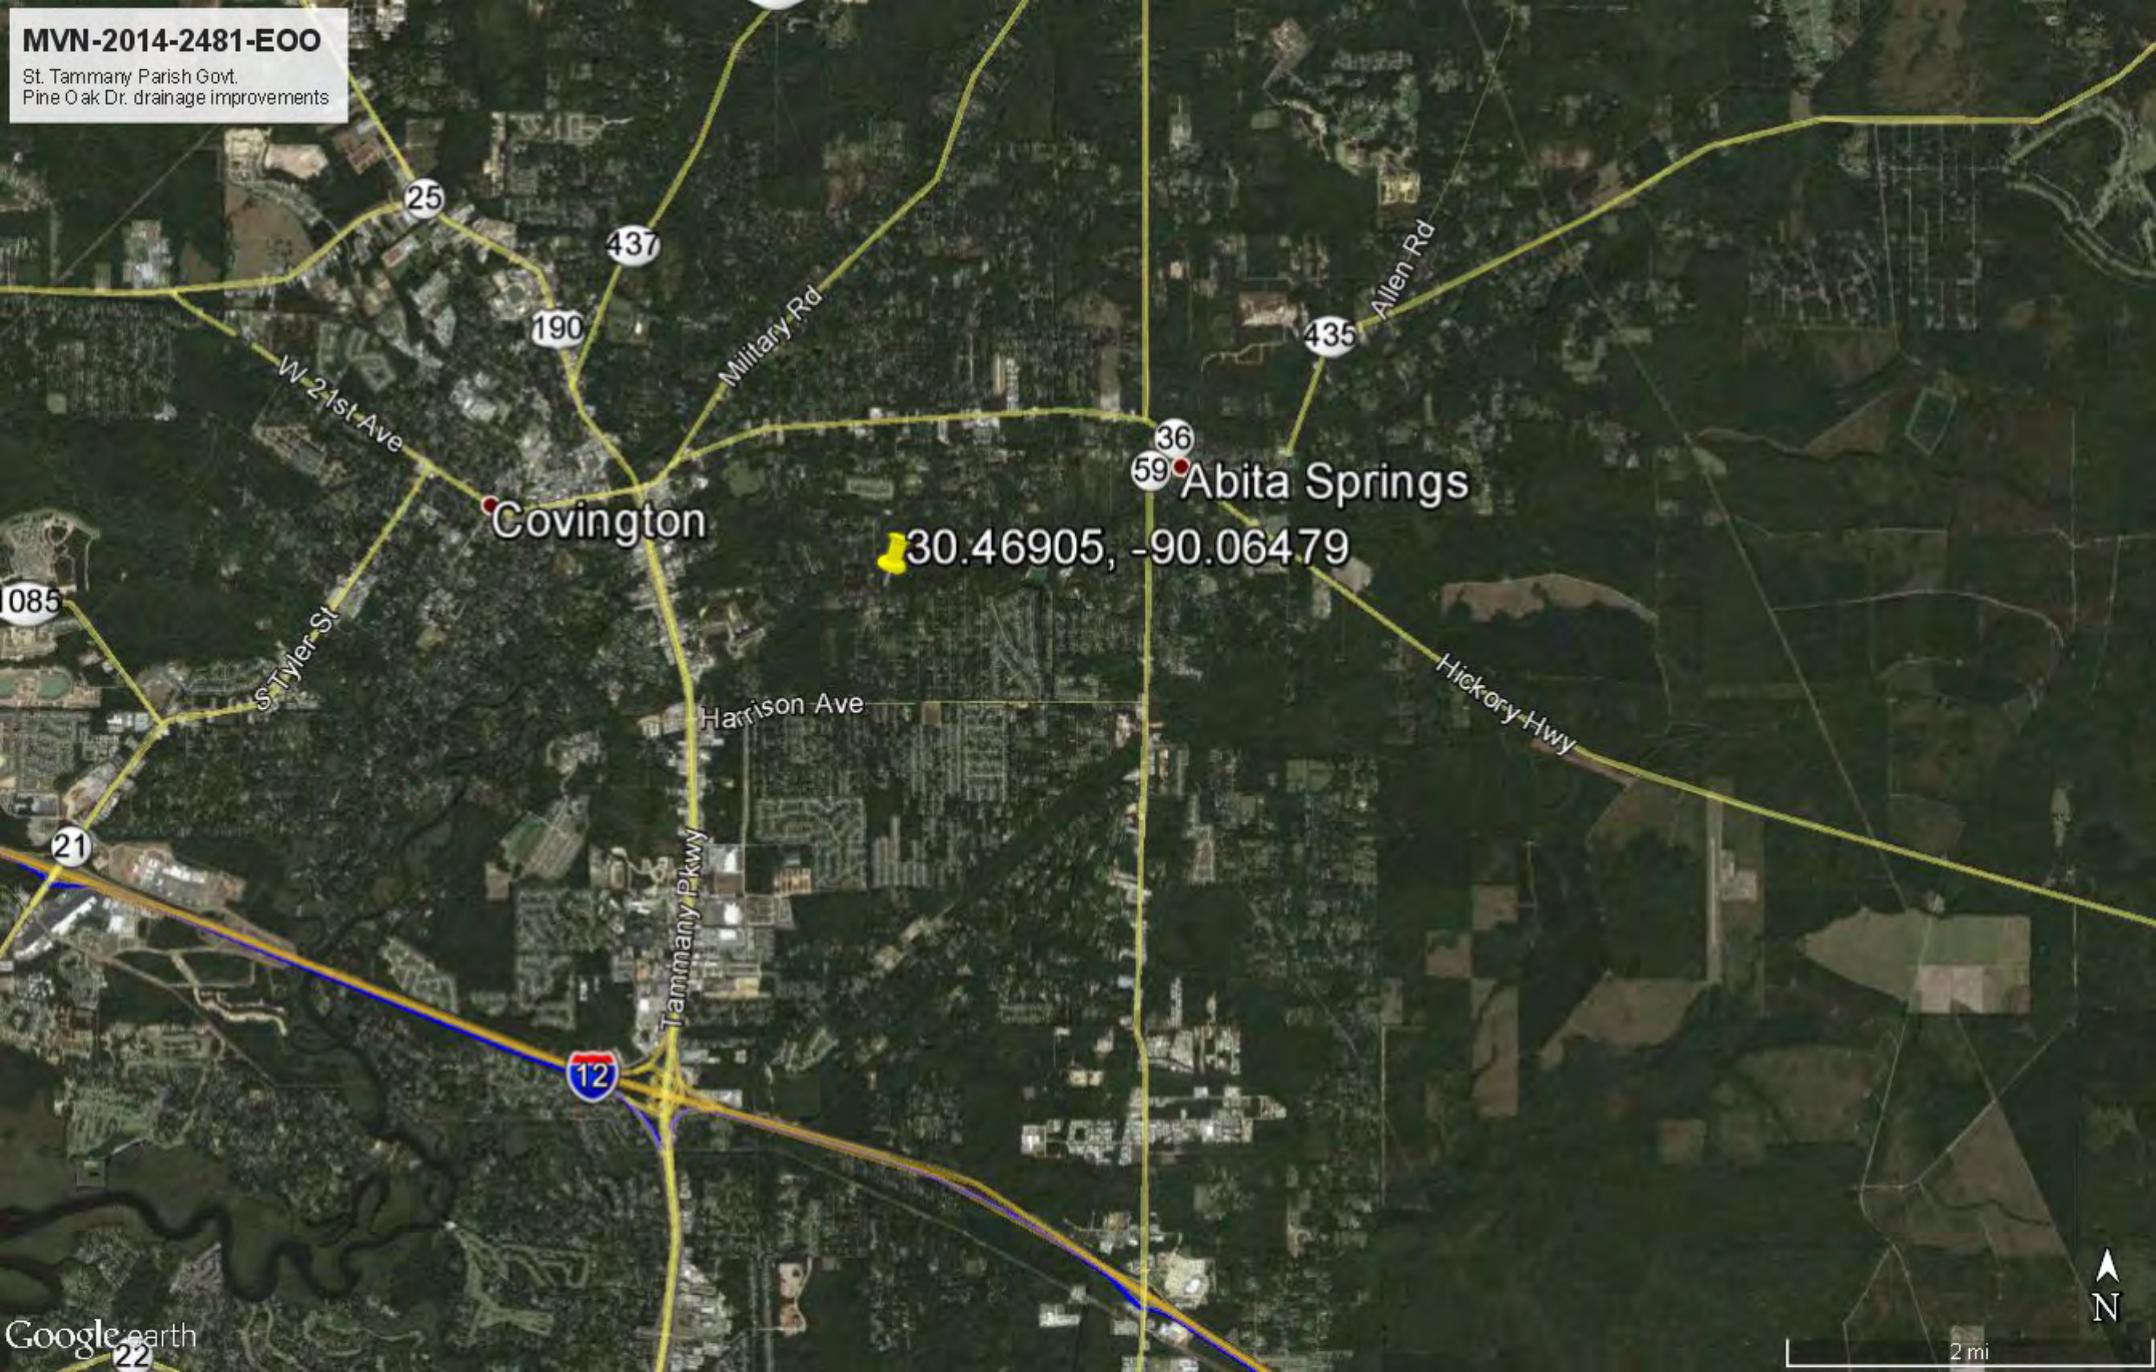

30.46905, -90.06479


Covington

Abita Springs



MVN-2014-2481-EOO

St. Tammany Parish Govt.
Pine Oak Dr. drainage improvements

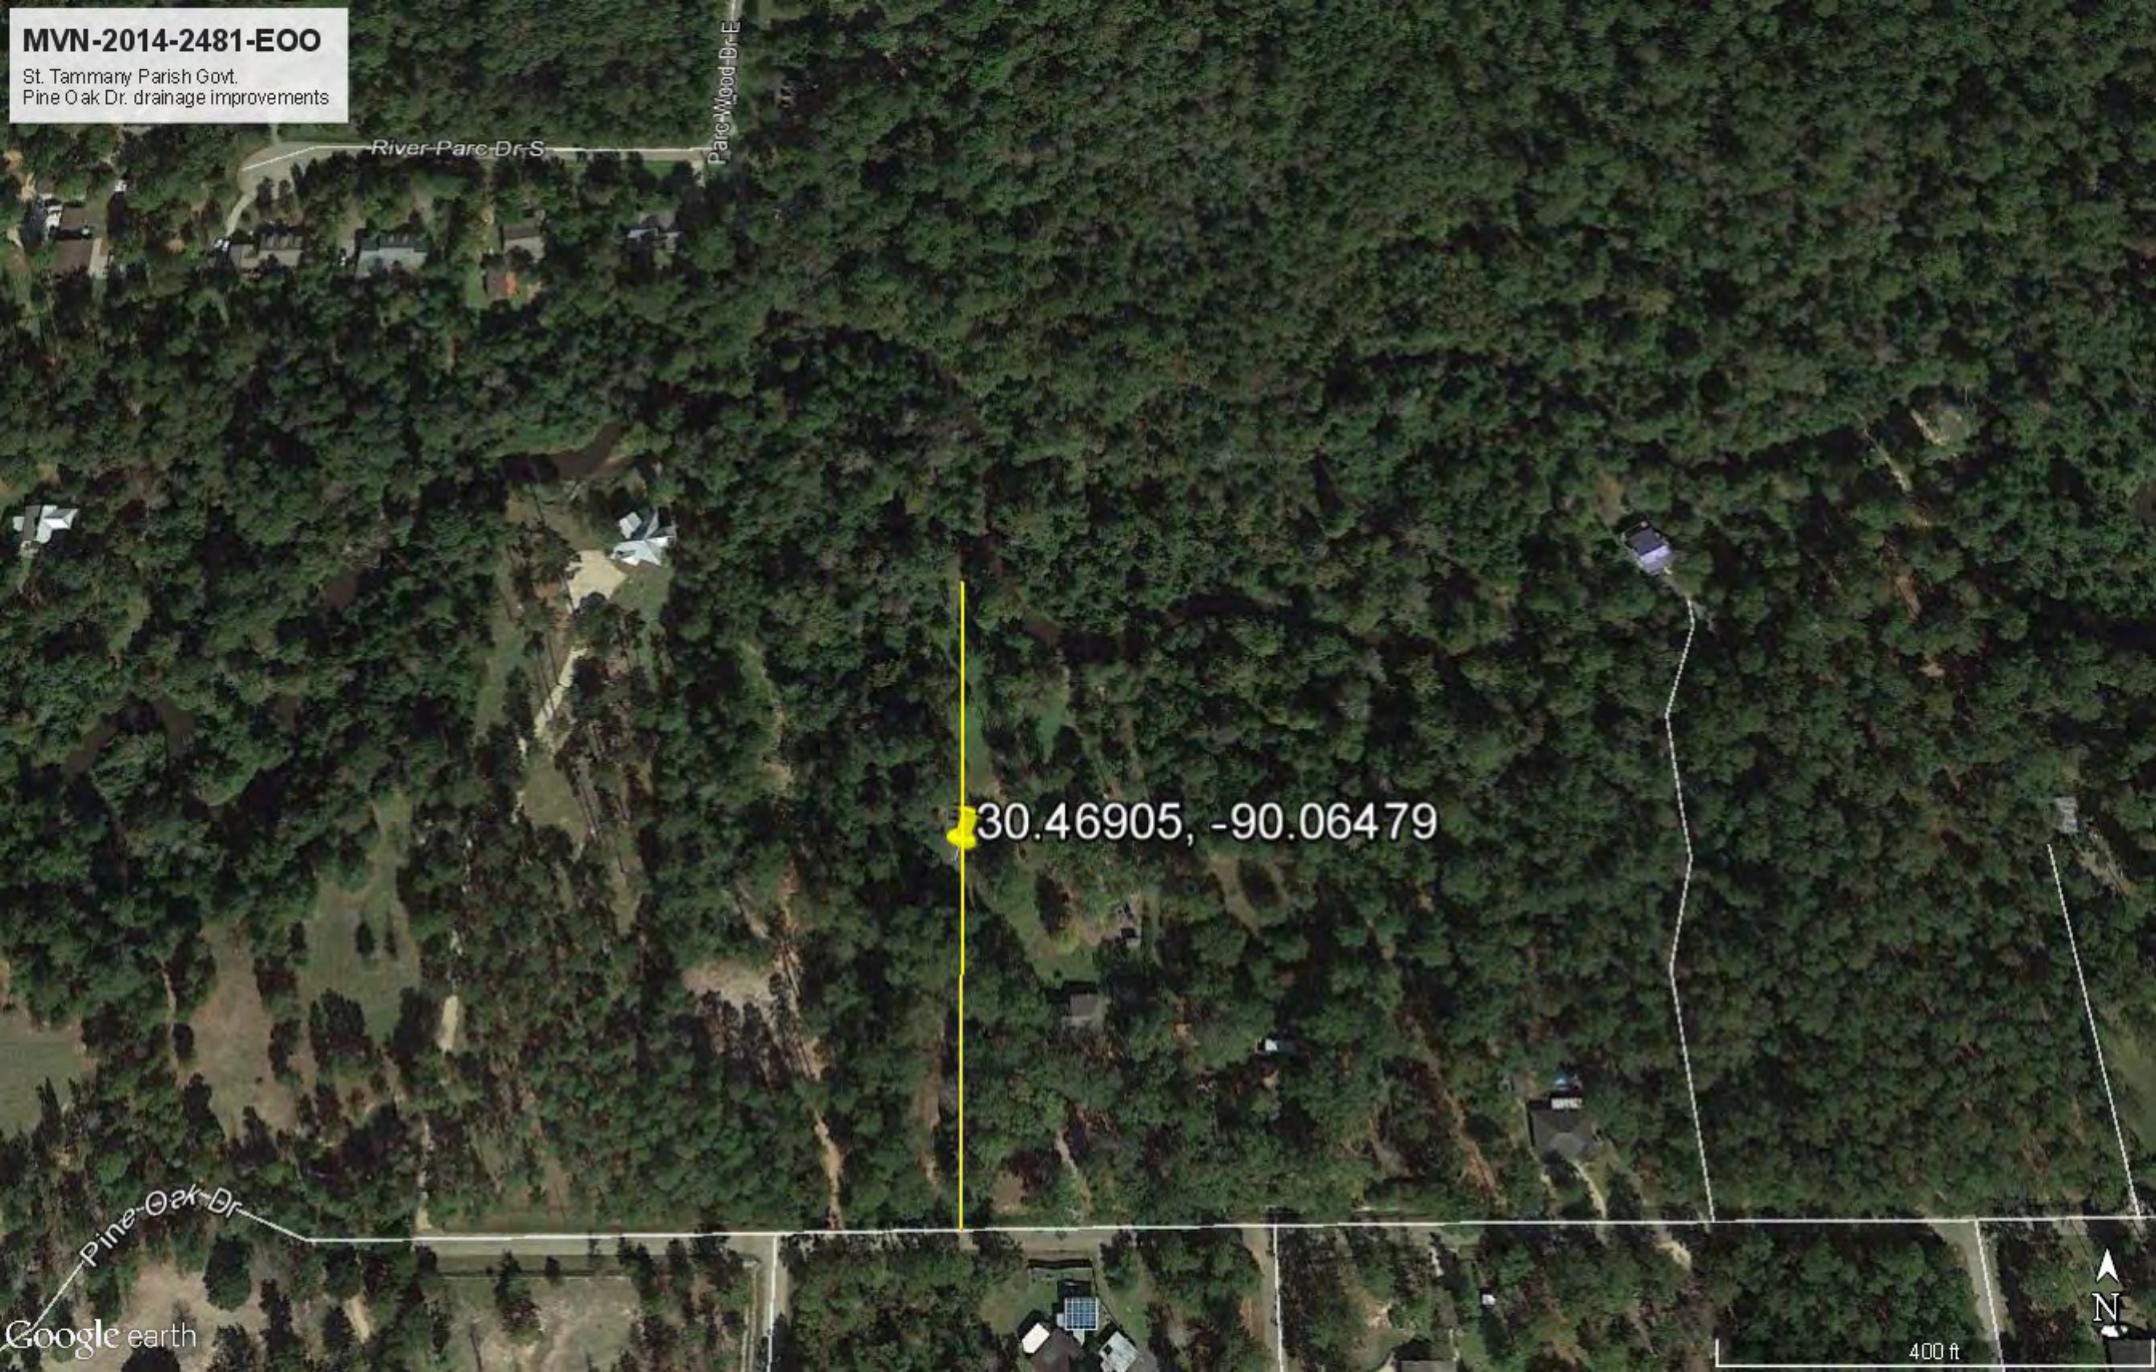

River-Park-Dr-S

Pine-Wood-Dr-E

30.46905, -90.06479

Pine-Oak-Dr


Google earth

400 ft



MVN-2014-2481-EOO



St. Tammany Parish Govt.
Pine Oak Dr. drainage improvements

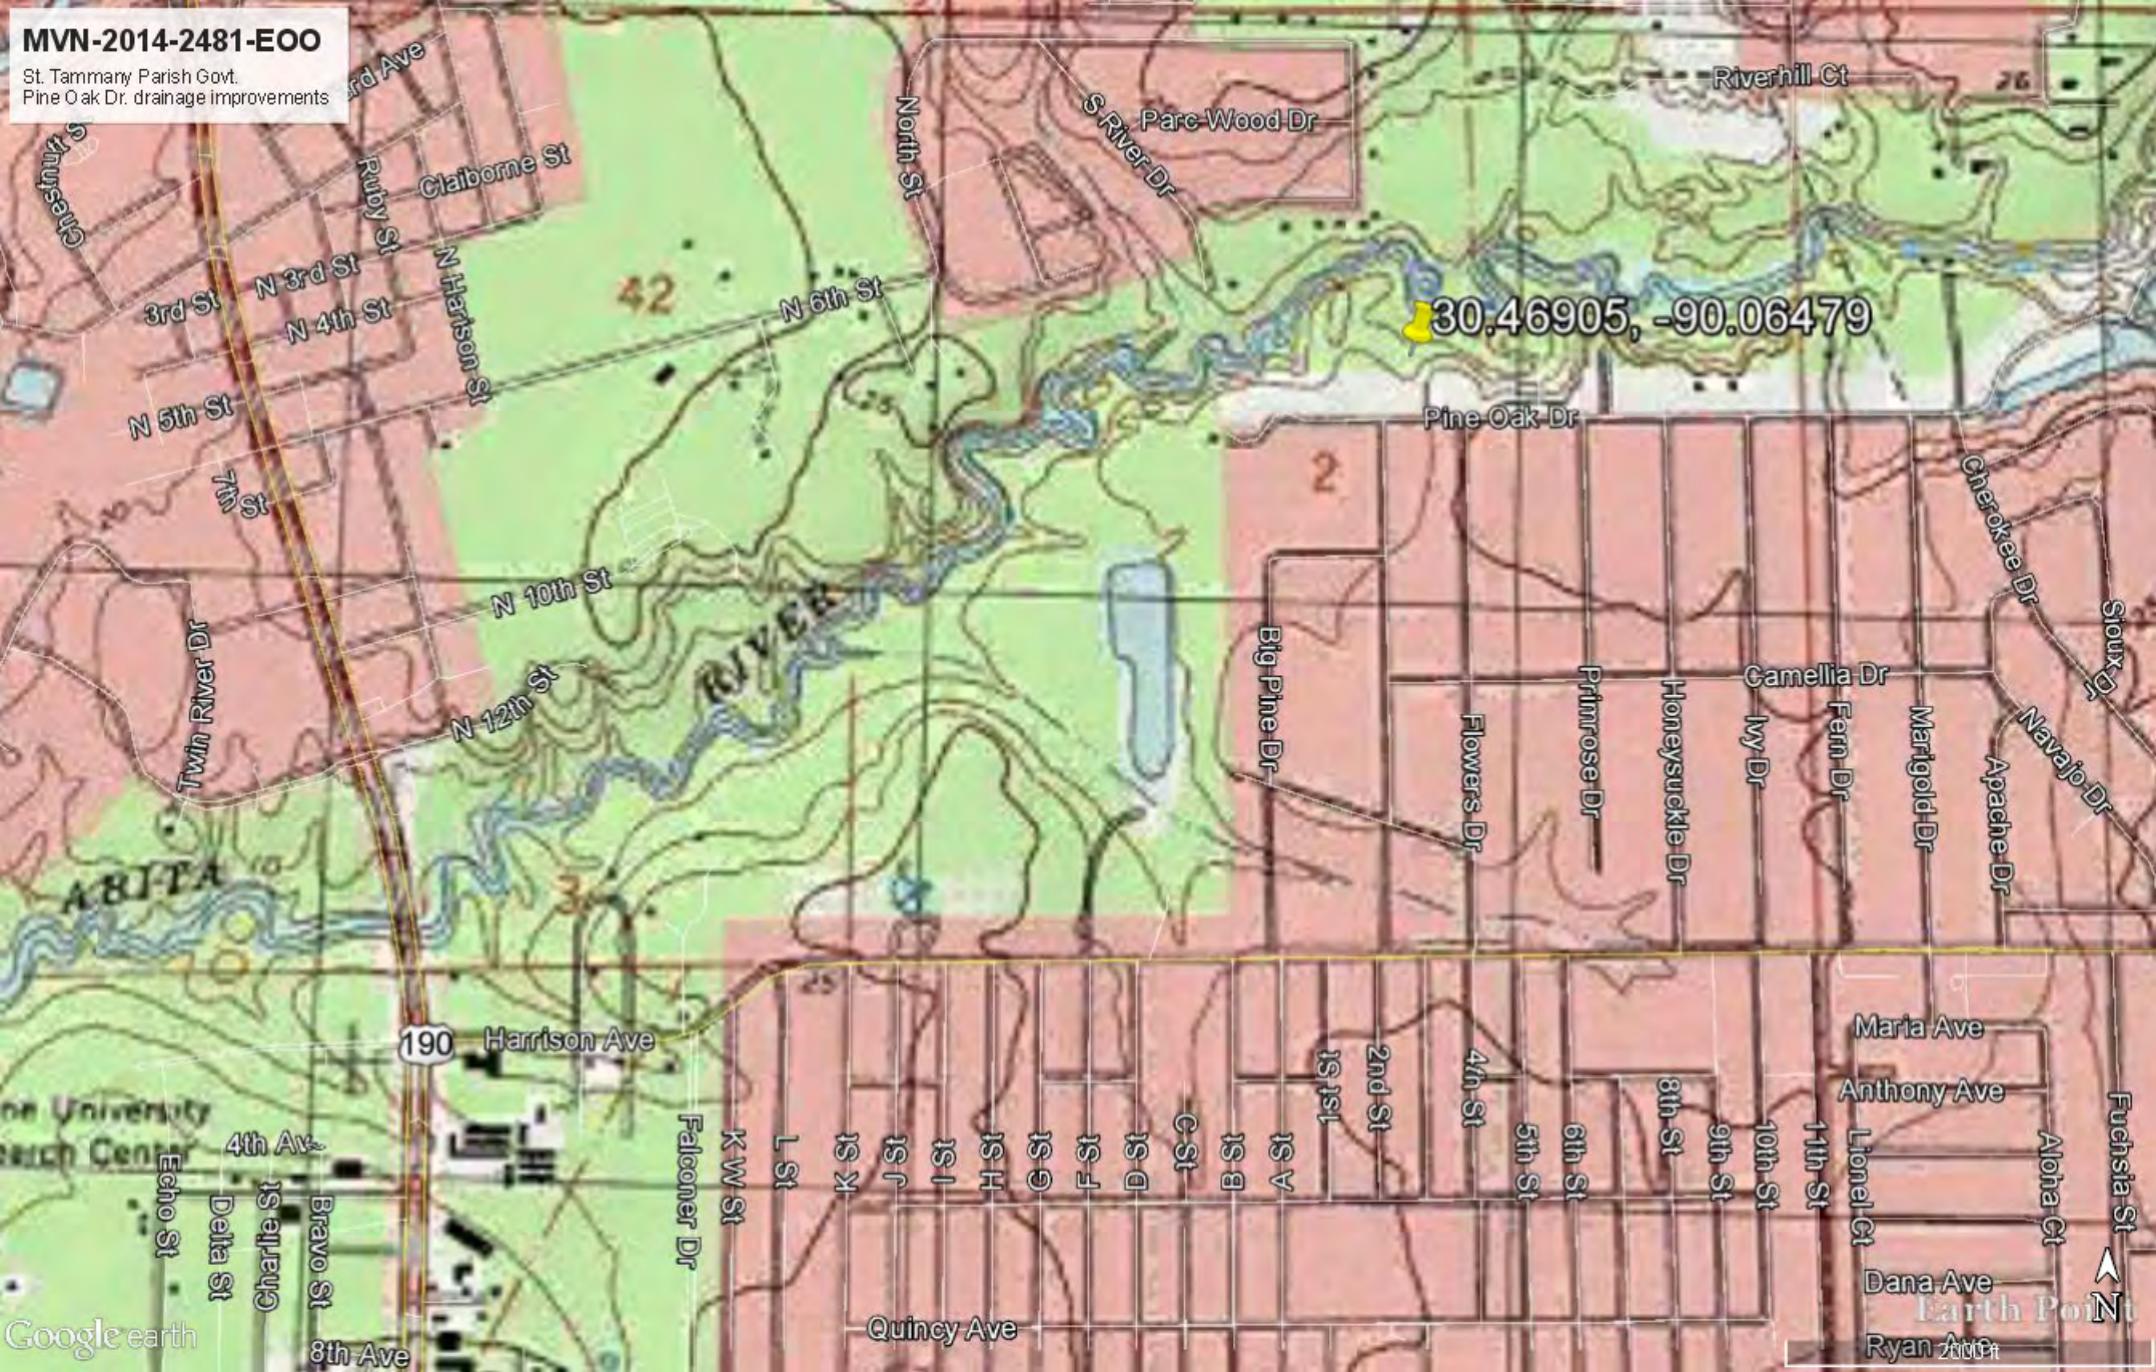

30.46905, -90.06479



Topographical Survey of
 A 30' SERVITUDE SITUATED IN
 LOT 22 * SINGING RIVER ESTATES * PHASE 1
 ST. TAMMANY PARISH, LOUISIANA
 FOR
 ST. TAMMANY PARISH GOVERNMENT

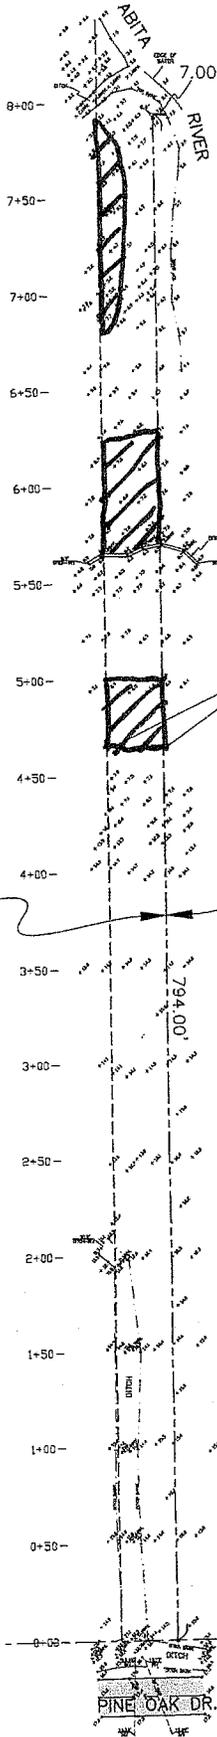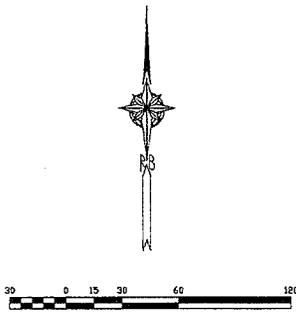

30' DRAINAGE
 SERVITUDE
 (PER RECORDED PLAT)

Wetlands

ALL DIMENSIONS AND RECORDS SHOWN ON THIS DRAWING ARE BASED ON THE DATA PROVIDED BY THE CLIENT AND THE SURVEYOR HAS NOT CONDUCTED A FIELD CHECK OF THE SAME. THE SURVEYOR HAS NOT CONDUCTED A FIELD CHECK OF THE SAME. THE SURVEYOR HAS NOT CONDUCTED A FIELD CHECK OF THE SAME.

Randall W. Brown, P.L.S.
 Professional Land Surveyor
 LA Registration No. 30348

NOTE:
 DIMENSIONS SHOWN HEREON ARE
 REFERENCED TO NAVD83 (2011 DATUM)

REF: Survey by Gilbert, Kiley & Coulter, P.C.
 Date: 9-27-1994
 Plat/Record No: 927312
 REF: Singing River Estates, Phase 1 plat
 Map File No: 425A
 Date: 8-20-1974

NO OTHER DATA EXCEPT
 AS NOTED OTHERWISE

| | | |
|-------|--------------------|----------------------|
| SHEET | DRAWN BY: RWB | SCALE: 1" = 30' ± |
| | CHECKED BY: RWB | SURVEY No. 131503 |
| | DATE: 1-20-2014 | |


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| REVISED DATE: |
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30' SERVITUDE
 LOT 22 * SINGING RIVER ESTATES * PHASE 1
 ST. TAMMANY PARISH, LOUISIANA

RANDALL W. BROWN & ASSOCIATES, INC.
 PROFESSIONAL LAND SURVEYORS * PLANNERS * CONSULTANTS
 220 W. CAUSEWAY APPROACH, MANDEVILLE, LA 70448
 (985) 824-5368 * FAX(985) 824-5309




LOT 22

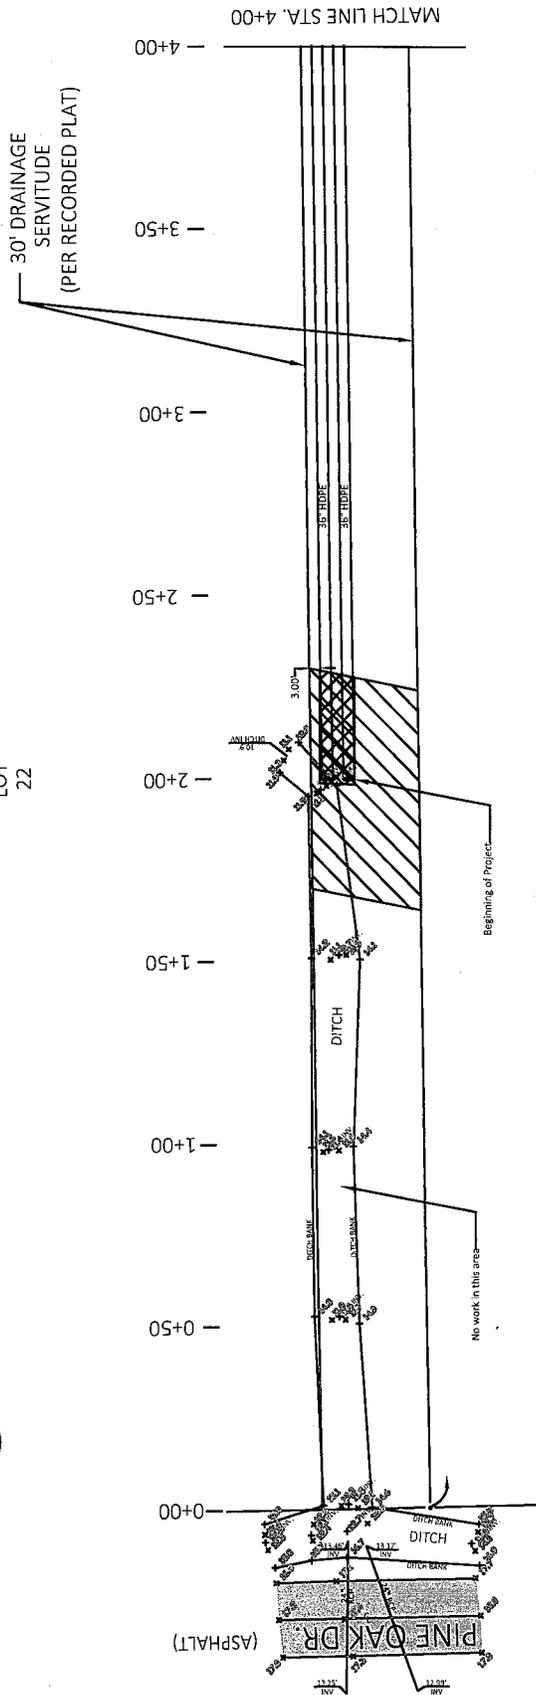


Wetlands Not Impacted

Wetlands Impacted (Limits of Construction)


LOT 21

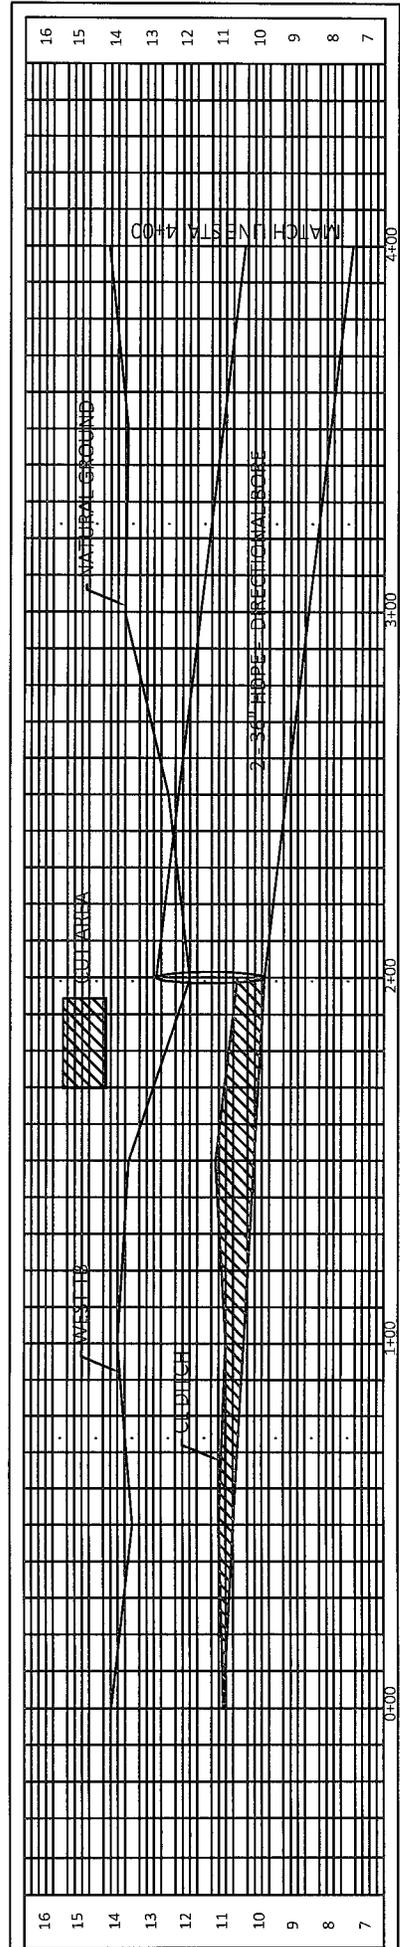

30' DRAINAGE
SERVITUDE
(PER RECORDED PLAT)

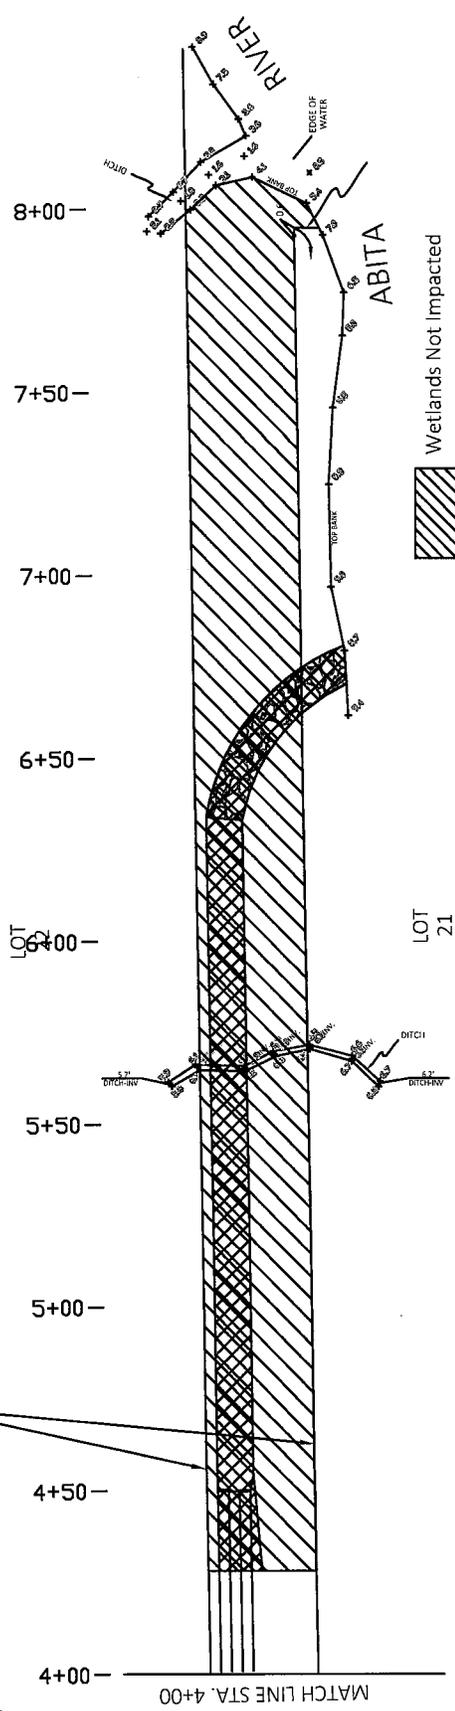

Wetlands Not Impacted
Wetlands Impacted (Limits of Construction)

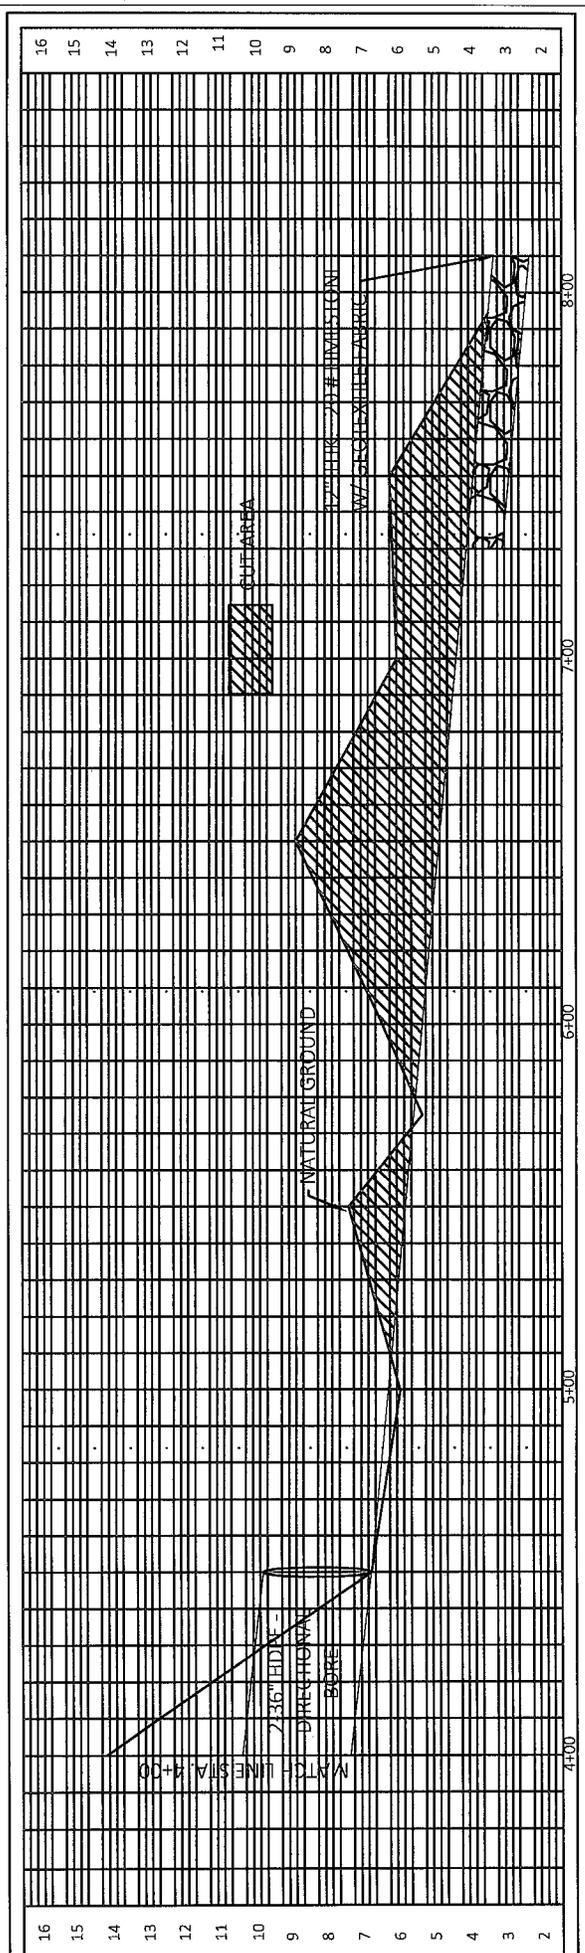

LOT 21

MATCH LINE STA. 4+00




MATCH LINE STA. 4+00

LOT 21

NATURAL GROUND

CUT AREA

WETLANDS NOT IMPACTED
WETLANDS IMPACTED (LIMITS OF CONSTRUCTION)

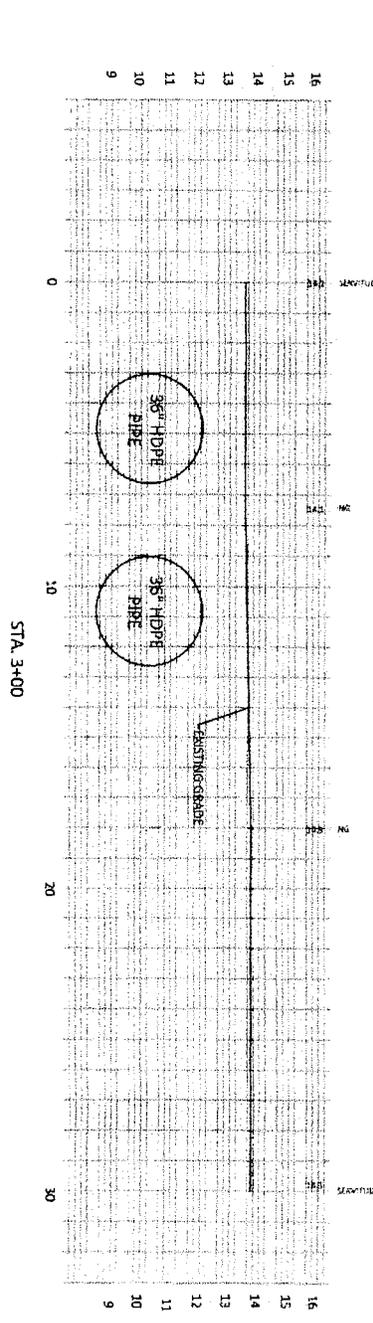
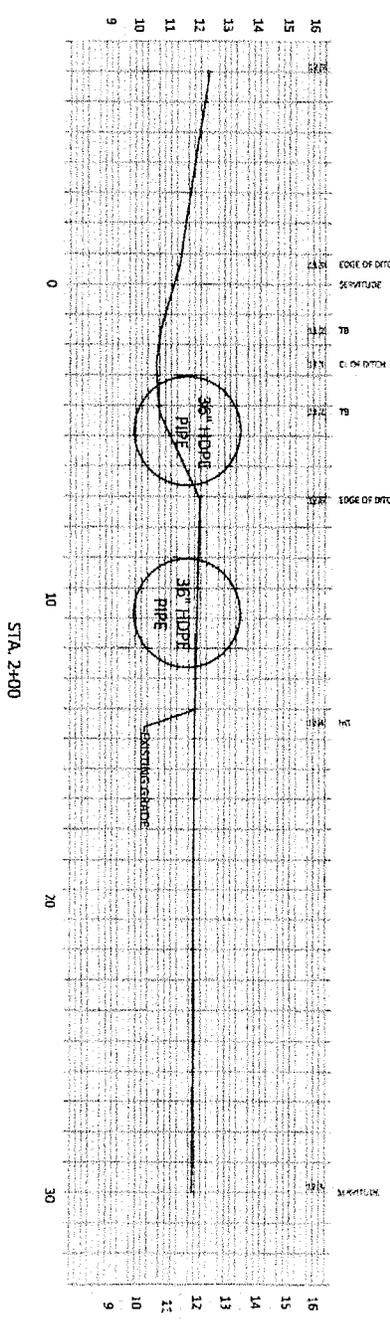
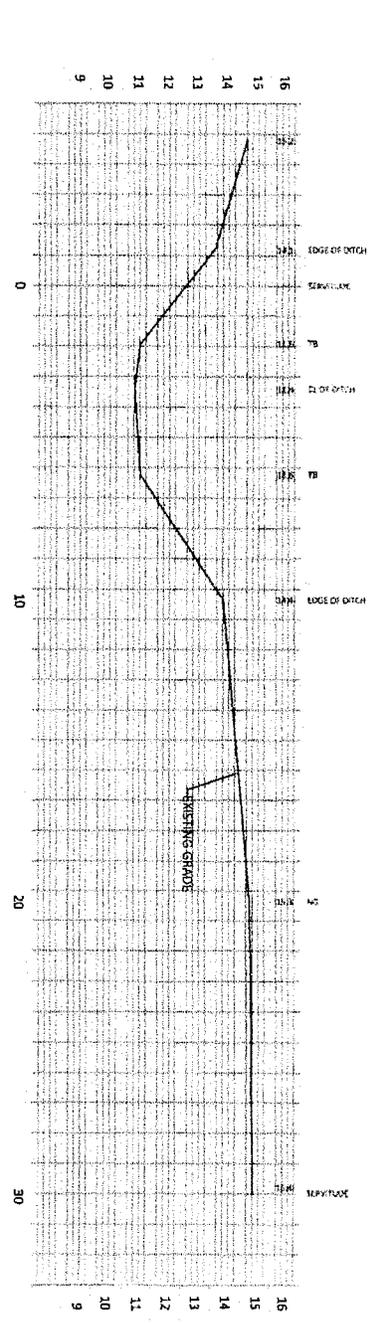


SINGING RIVERS
PLAN AND PROFILE

| NO. | DATE | REVISION |
|-----|------|----------|
| | | |
| | | |


 State of Tennessee
 Registered Professional Engineer
 No. 107675 Exp. 12/31/2018
 Home: 615-898-5207 Fax: 615-898-4444
 Cell: 615-898-5110

01.23.14
 1" = 20'
 3

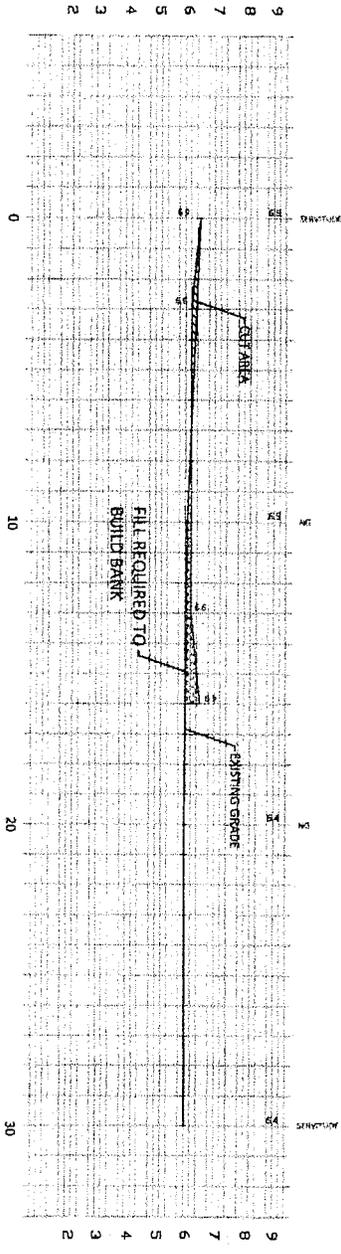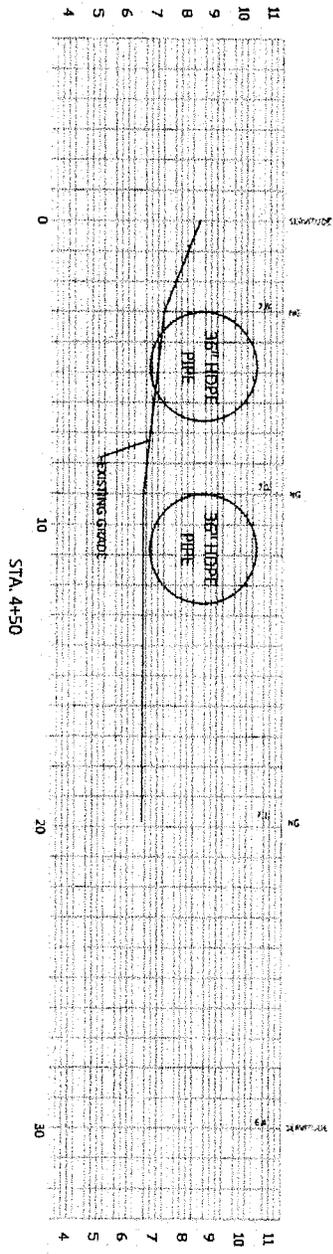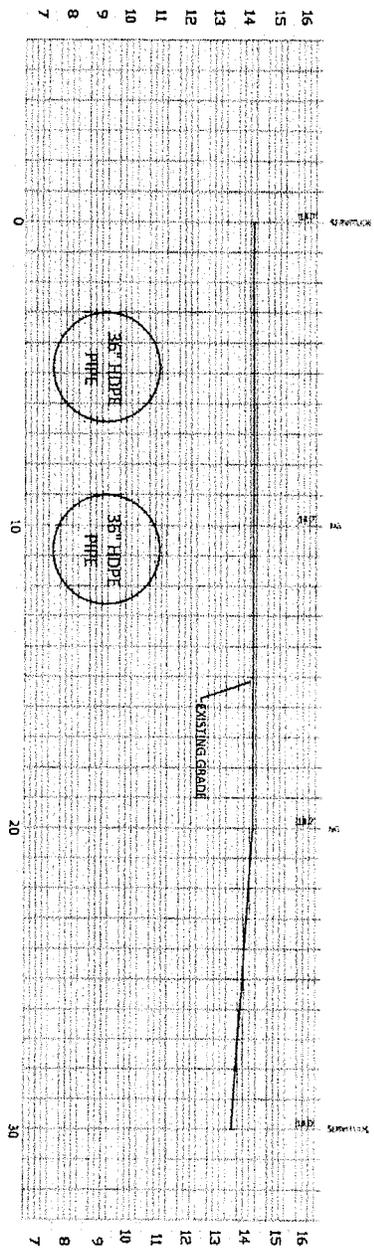


SINGING RIVERS
PLAN AND PROFILE


| NO. | DATE | REVISION |
|-----|------|----------|
| | | |
| | | |
| | | |

Professional Engineer
State of California
No. 100100000
Exp. 12/31/2014

Project No. 01-23-14
Sheet No. 4
Scale 1" = 20'

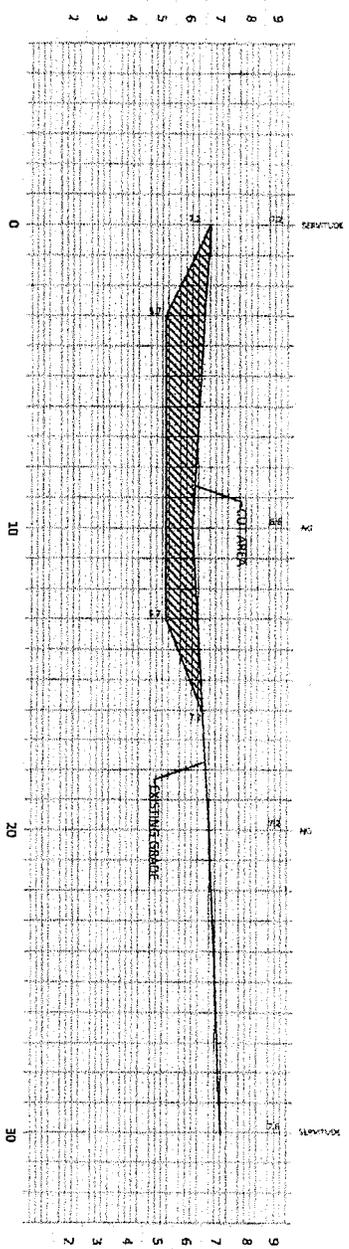

STA. 6+00

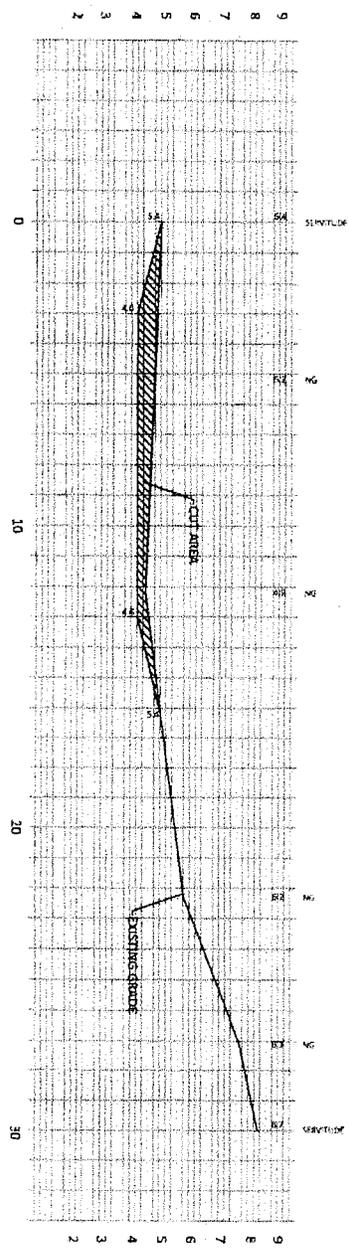

STA. 7+00

| | |
|-------------|----------|
| Project No. | 5 |
| Date | 01-23-14 |
| Scale | 1" = 20' |
| Drawn by | |




3130 West 10th Street, Suite 100
 Oklahoma City, Oklahoma 73104
 Phone: (405) 442-2100 Fax: (405) 442-2101
 www.ec-engineers.com

| No. | Date | Description |
|-----|------|-------------|
| | | |
| | | |
| | | |

**SINGING RIVERS
 PLAN AND PROFILE**

SITE

Soil Map—St. Tammany Parish, Louisiana

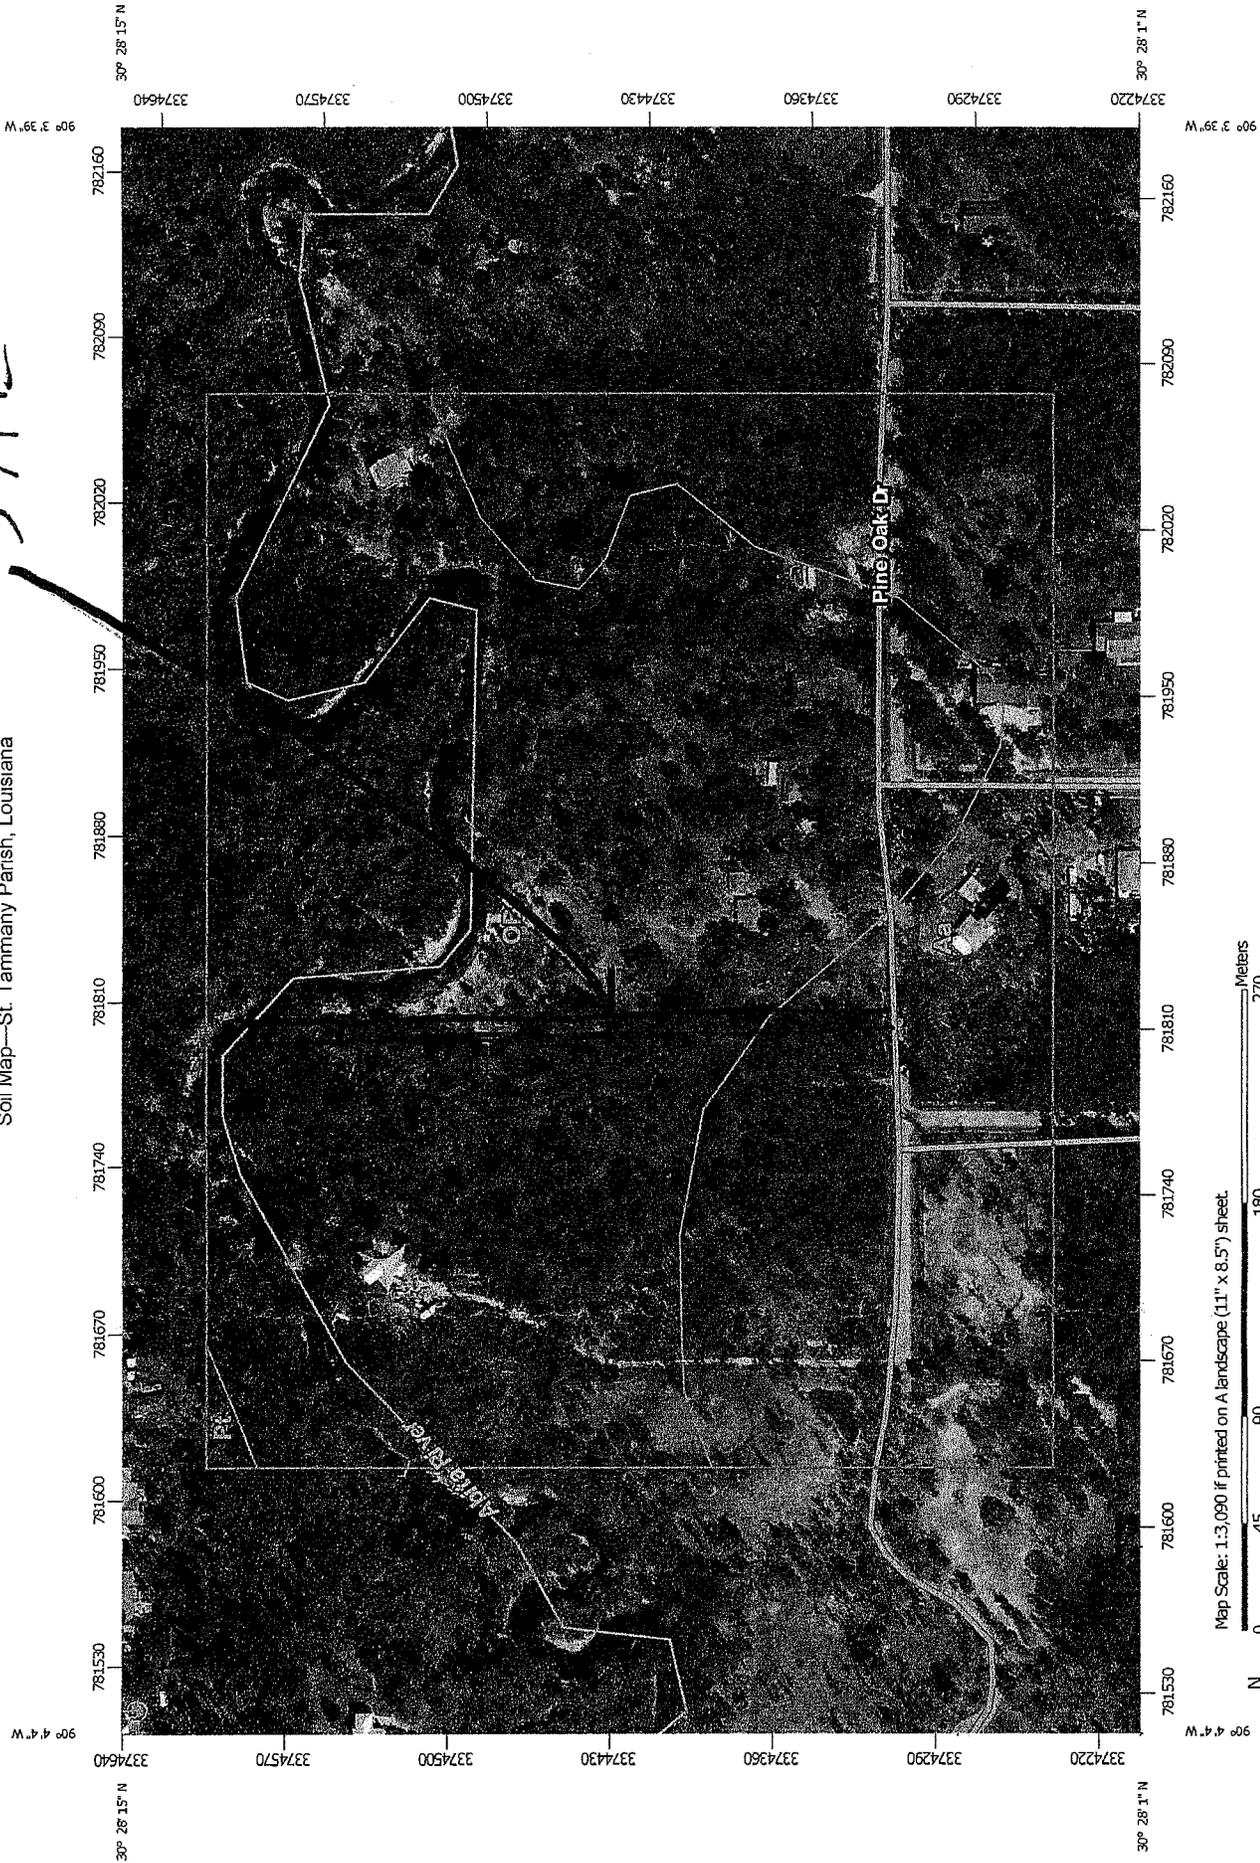

Map Scale: 1:3,090 if printed on A landscape (11" x 8.5") sheet.

Map projection: Web Mercator Corner coordinates: WGS84 Edge tics: UTM Zone 15N WGS84