



DEPARTMENT OF THE ARMY  
NEW ORLEANS DISTRICT, CORPS OF ENGINEERS  
P.O. BOX 60267  
NEW ORLEANS, LOUISIANA 70160-0267

July 27, 2015

REPLY TO  
ATTENTION OF

Operations Division  
Eastern Evaluation Section

Project Manager  
Stephanie Castaing  
[Stephanie.L.Castaing@usace.army.mil](mailto:Stephanie.L.Castaing@usace.army.mil)  
(504) 862-1564

SUBJECT: MVN 2015-1157-EPP

**PUBLIC NOTICE**

Interested parties are hereby notified that an application has been received by the District engineer for a Department of the Army permit to authorize the following pursuant to (X) Section 10 of the Rivers and Harbors Act of March 3, 1899 (30 Stat. 1151; 33 USC 403); and/or ( ) Section 404 of the Clean Water Act (86 Stat. 816; 33 USC 1344).

**Install and maintain mooring monopiles, in the Mississippi River,  
in Jefferson Parish, Louisiana**

**NAME OF APPLICANT:** Cargill, % Lanier & Associates, Attn: Allison Gaines, 4101 Magazine Street, New Orleans, Louisiana 70115.

**LOCATION OF WORK:** Located on the right descending bank of the Mississippi River, at about mile 103 above Head of Passes, at 933 River Road, in Jefferson Parish, Louisiana, as shown on the enclosed drawings.

Latitude: 29.931469/Longitude: -90.142864, Hydrologic Unit Code 08090100 – Lower Mississippi-New Orleans

**CHARACTER OF WORK:** Install and maintain 6 barge dolphin monopiles. No dredging and/or fill activities are proposed. The applicant maintains that no jurisdictional wetlands would be directly affected by this action, thus no compensatory mitigation is anticipated.

The comment period will close **30 days** from the date of this public notice advertisement. Written comments, including suggestions for modifications or objections to the proposed work, stating reasons therefore, are being solicited from anyone having interest in this permit request. Letters must reference the applicant's name and the subject number, be addressed and mailed to the above address, ATTENTION: REGULATORY BRANCH.

### **Corps of Engineers Permit Criteria**

The decision whether to issue a permit will be based on an evaluation of the probable impacts, including cumulative impacts of the proposed activity on the public interest. That decision will reflect the national concern for both protection and utilization of important resources. The benefit which reasonably may be expected to accrue from the proposal must be balanced against its reasonably foreseeable detriments. All factors which may be relevant to the proposal will be considered including the cumulative effects thereof; among those are conservation, economics, aesthetics, general environmental concerns, wetlands, historic properties, fish and wildlife values, flood hazards, floodplain values, land use, navigation, shoreline erosion and accretion, recreation, water supply and conservation, water quality, energy needs, safety, food and fiber production, mineral needs, considerations of property ownership and, in general, the needs and welfare of the people.

The U.S. Army Corps of Engineers is soliciting comments from the public, federal, state, and local agencies and officials, Indian Tribes, and other interested parties in order to consider and evaluate the impacts of this proposed activity. Any comments received will be considered by the U.S. Army Corps of Engineers to determine whether to make, modify, condition, or deny a permit for this proposal. To make this decision, comments are used to assess impacts on endangered species, historic properties, water quality, general environmental effects, and other public interest factors listed above. Comments are used in the preparation of an Environmental Assessment and/or an Environmental Impact Statement pursuant to the National Environmental Policy Act. Comments are also used to determine the need for a public hearing and to determine the overall public interest of the proposed activity.

The New Orleans District is unaware of properties listed on the National Register of Historic Places near the proposed work. The possibility exists that the proposed work may damage or destroy presently unknown archeological, scientific, prehistorical, historical sites, or data. Issuance of this public notice solicits input from the State Archeologist and State Historic Preservation Officer regarding potential impacts to cultural resources.

The New Orleans District has determined that the proposed project is located in waters known to be utilized by the pallid sturgeon (*Scaphirhynchus albus*) and determined that the proposed activity is not likely to adversely affect the species based on the Standard Local Operating Procedure for Endangered Species of Louisiana (SLOPES), dated October 22, 2014, between the U.S. Army Corps of Engineers and U.S. Fish and Wildlife Service, Ecological Services Office.

Our initial finding is that the proposed work would not affect any species, nor affect any habitat designated as critical to the survival and recovery of such species, listed as endangered by the U.S. Department of Commerce

This notice initiates the Essential Fish Habitat (EFH) consultation requirements of the Magnuson-Stevens Fishery Conservation and Management Act. The applicant's proposal would result in the destruction or alteration of up to N/A acres of EFH utilized by various life stages of red drum and penaeid shrimp. Our initial determination is that the proposed action would not have a substantial adverse impact on EFH or federally managed fisheries in the Gulf of Mexico. Our final determination relative to project impacts and the need for mitigation measures is subject to review by and coordination with the National Marine Fisheries Service.

If the proposed work involves deposits of dredged or fill material into navigable waters, the evaluation of the probable impacts will include the application of guidelines established by the Administrator of the Environmental Protection Agency. Also, a certification that the proposed activity will not violate water quality standards will be required from the Department of Environmental Quality, Water Quality Certifications Section before a permit is issued.


Any person may request, in writing, within the comment period specified in this notice, that a public hearing be held to consider this application. Requests for public hearings shall state, with particularity, the reasons for holding a public hearing.

The applicant has certified that the proposed activity described in the application complies with and will be conducted in a manner that is consistent with the Louisiana Coastal Resources Program. The Department of the Army permit will not be issued unless the applicant received approval or a waiver of the Coastal Use Permit by the Department of Natural Resources.

You are requested to communicate the information contained in this notice to any other parties whom you deem likely to have interest in the matter.

Michael V. Farabee  
Chief, Eastern Evaluation Section

Enclosures

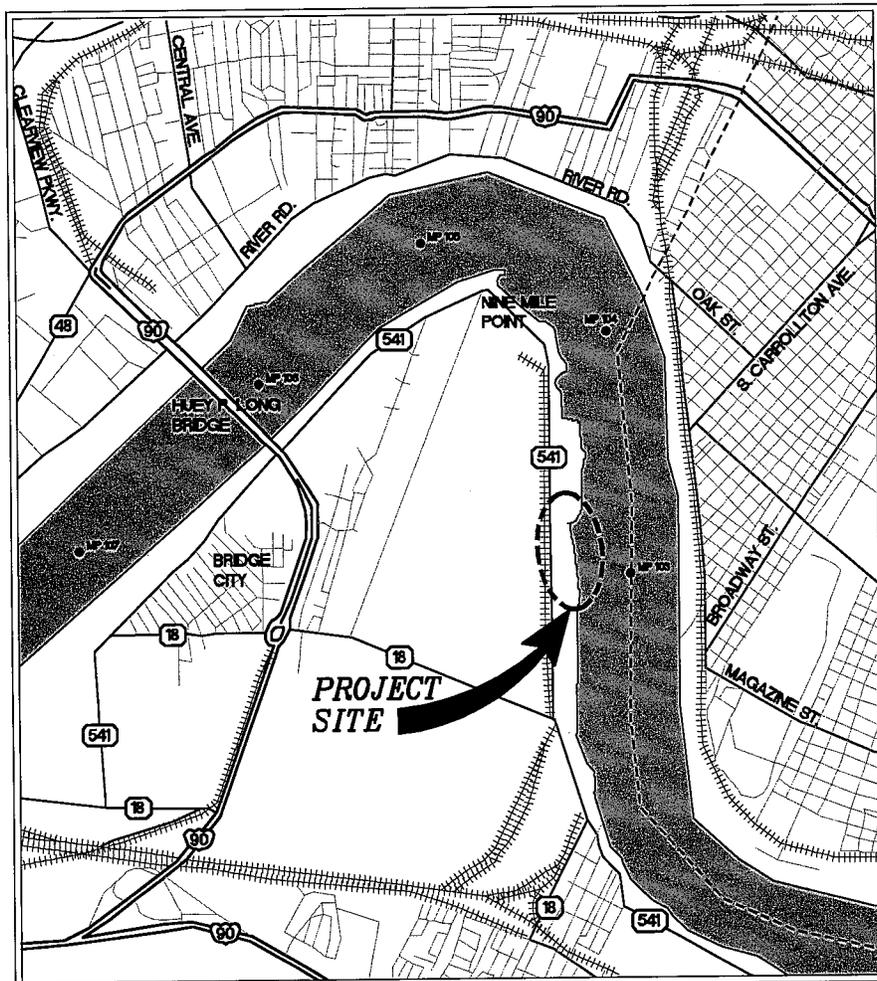

LAT: 29° 56' 20.8"  
 LONG: 90° 08' 31.7"

**VICINITY MAP**  
 N.T.S.



VICINITY

**AREA MAP**

**GENERAL NOTES**

1. AS-BUILT DRAWINGS WILL BE SUBMITTED WITHIN 30 DAYS OF COMPLETION OF THIS PROJECT TO THE LOUISIANA DEPARTMENT OF NATURAL RESOURCES, OFFICE OF CONSERVATION, PIPELINE DIVISION P.O. BOX 94275 BATON ROUGE, LA 70804, AND TO THE LOUISIANA DEPARTMENT OF NATURAL RESOURCES COASTAL MANAGEMENT DIVISION, P.O. BOX 44487, BATON ROUGE, LA 70804.
2. ALL STRUCTURES, FACILITIES, WELL AND PIPELINES/FLOWLINES OCCURRING IN OPEN WATER AREAS OR IN OILFIELD CANALS OR SLIPS SHALL BE REMOVED WITHIN 120 DAYS OF ABANDONMENT OR THE FACILITIES FOR THE HEREIN PERMITTED USE UNLESS PRIOR WRITTEN APPROVAL TO LEAVE SUCH STRUCTURES IN PLACE IS RECEIVED FROM THE COASTAL MANAGEMENT DIVISION. THIS CONDITION DOES NOT PRECLUDE THE NECESSITY FOR REVISION THE CURRENT PERMIT OR OBTAINING A SEPARATE COASTAL USE PERMIT, SHOULD ONE BE REQUIRED.
3. STRUCTURES MUST ALSO BE MARKED/LIGHTED IN ACCORDANCE WITH U.S. COAST GUARD REGULATIONS.
4. IN ORDER TO ENSURE THE SAFETY OF ALL PARTIES, THE PERMITTED SHALL CONTACT THE LOUISIANA ONE CALL SYSTEM (1-800-272-3020) A MINIMUM OF 48 HOURS PRIOR TO THE COMMENCEMENT OF ANY EXCAVATION (DIGGING, DREDGING, JETTING, ETC.) OR DEMOLITION ACTIVITY.


9452-P1

**LANIER & ASSOCIATES**  
 CONSULTING ENGINEERS  
 INCORPORATED  
 NEW ORLEANS, LA    BEAUMONT, TX

**CARGILL**  
 WESTWEGO    LOUISIANA

**2015 PROJECTS**  
**TOWER 6 REPAIRS & PROPOSED NEW BARGE FLEETING**  
**AREA MAP, VICINITY MAP & GENERAL NOTES**

DATE	FEB. 2015
DESIGN	AKG
DRAWN	WGL
CHECK	BNF
CONTRACT	9452
SHEET No.	
	1 of 7

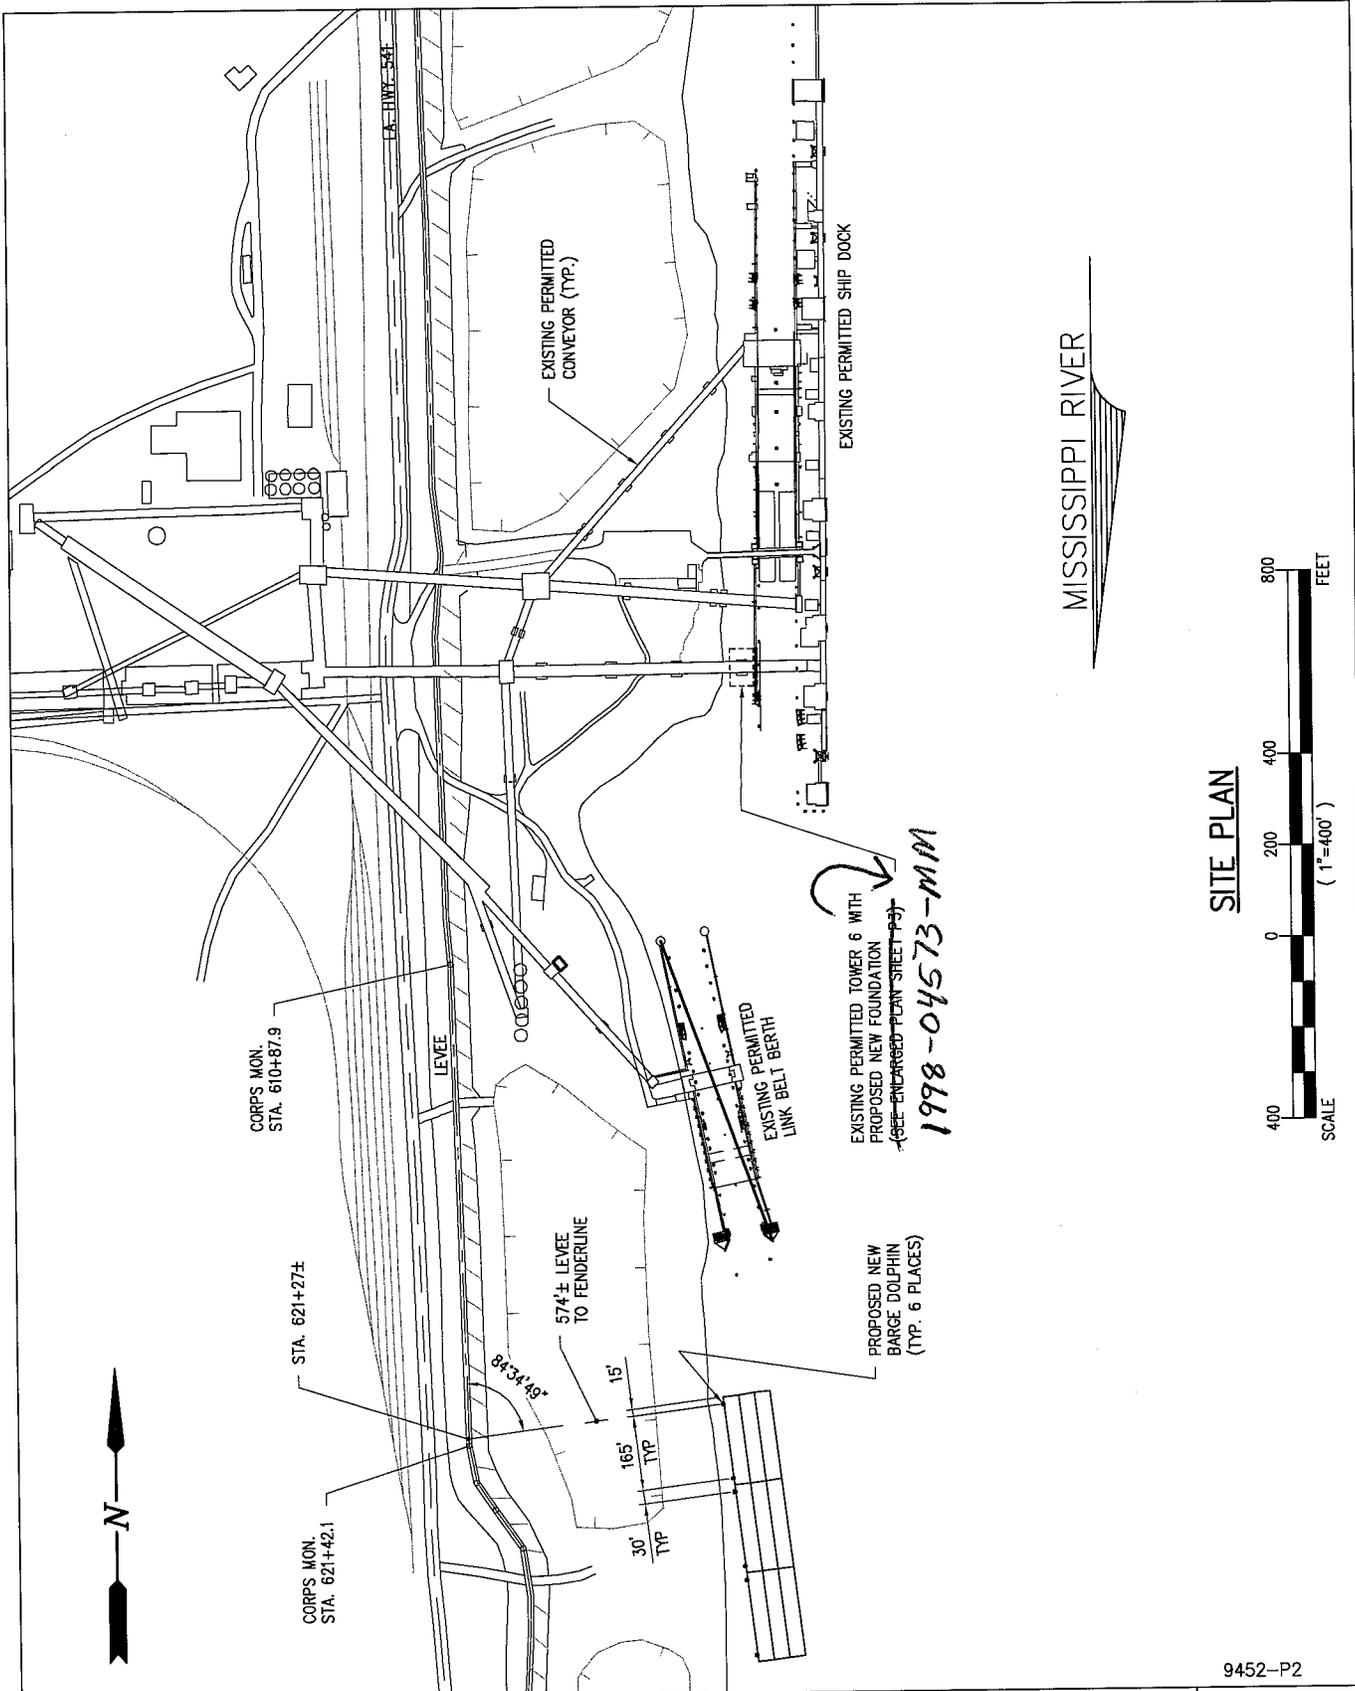

**LANIER & ASSOCIATES**  
 CONSULTING ENGINEERS  
 INCORPORATED  
 NEW ORLEANS, LA · BEAUMONT, TX


**WESTWEGO CARGILL LOUISIANA**

**2015 PROJECTS**  
**TOWER 6 REPAIRS & PROPOSED NEW BARGE FLEETING**  
**EXISTING SITE PLAN**


9452-P2

DATE	FEB. 2015
DESIGN	AKG
DRAWN	TPM
CHECK	BNF
CONTRACT	9452
SHEET No.	
2 OF 7	

2094

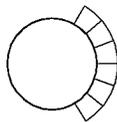


PLAN

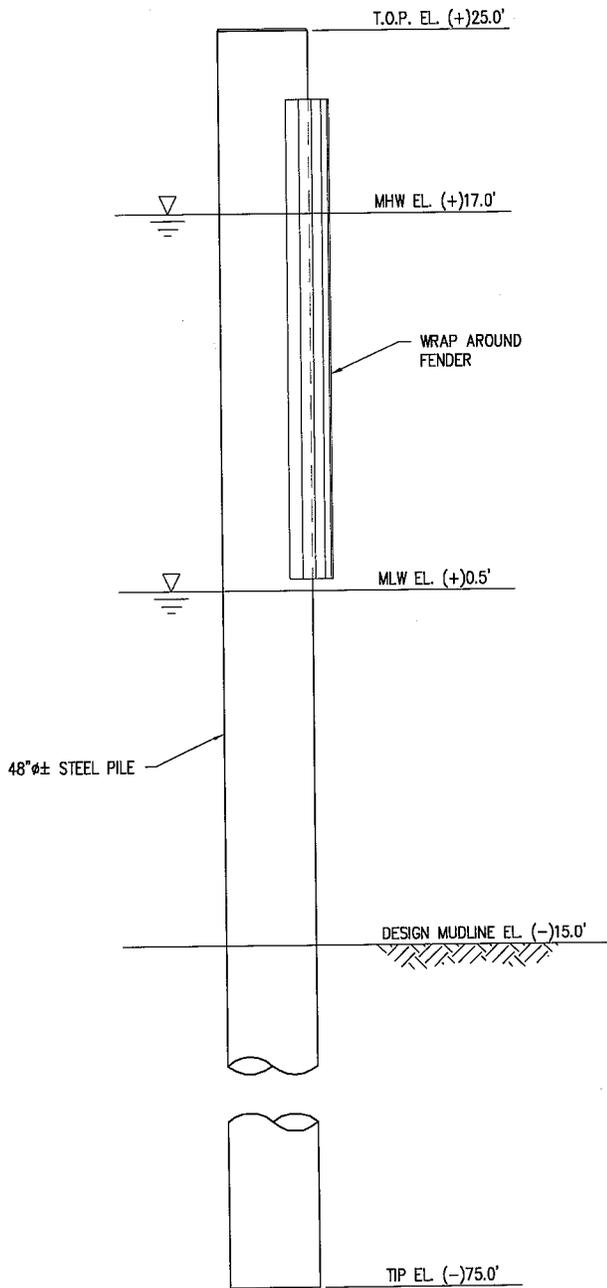

**PROPOSED NEW BARGE DOLPHIN ELEVATION**

SCALE: 1/8"=1'-0" TOTAL (6) REQUIRED

9452-P6

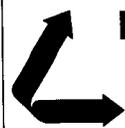

**LANIER & ASSOCIATES**  
CONSULTING ENGINEERS  
INCORPORATED

NEW ORLEANS, LA · BEAUMONT, TX

WESTWEGO

**CARGILL**


LOUISIANA

**2015 PROJECTS**  
**TOWER 6 REPAIRS & PROPOSED NEW BARGE FLEETING**  
**PROPOSED NEW BARGE DOLPHIN**

DATE JUN. 2015  
DESIGN AKG  
DRAWN WGI  
CHECK BNF  
CONTRACT 9452  
SHEET No.

~~6~~ OF ~~7~~

3 of 4

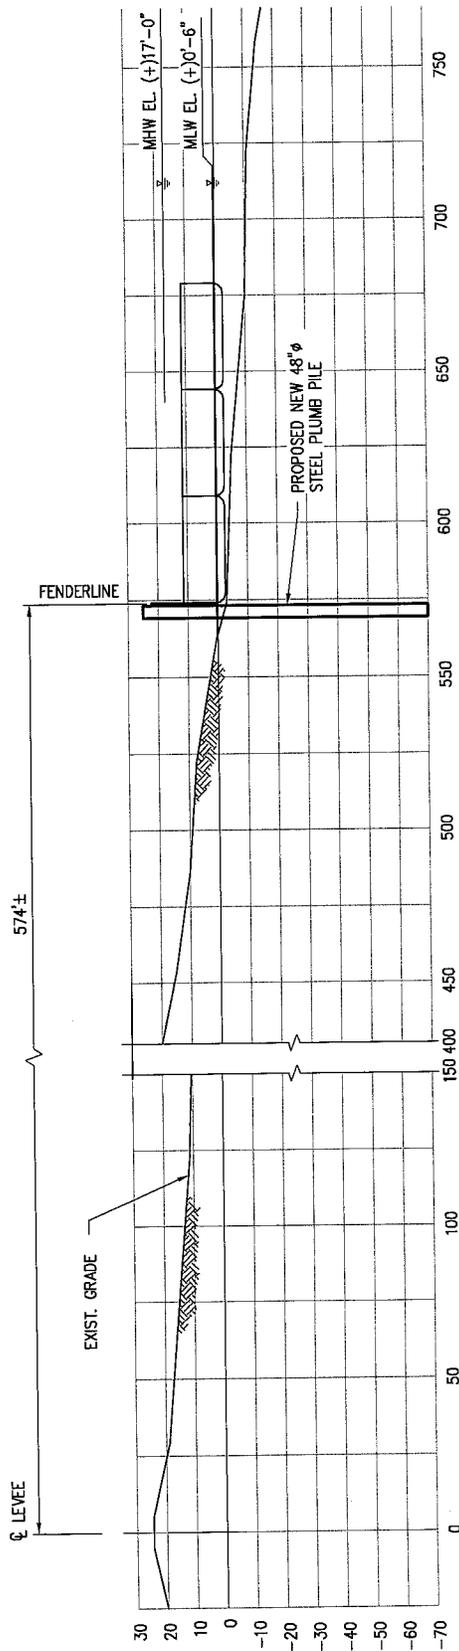


**CROSS SECTION AT STA. 621+27±**

SCALE: 1"=60'



9452-P7

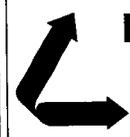

**LANIER & ASSOCIATES**  
 CONSULTING ENGINEERS  
 INCORPORATED  
 NEW ORLEANS, LA · BEAUMONT, TX

**WESTWEGO CARGILL LOUISIANA**

**2015 PROJECTS**  
**TOWER 6 REPAIRS & PROPOSED NEW BARGE FLEETING**  
**CROSS SECTION**

DATE JUN. 2015  
 DESIGN AKG  
 DRAWN WGI  
 CHECK BNF  
 CONTRACT 9452  
 SHEET No. 7 OF 7

4 of 4