## JOINT PUBLIC NOTICE

### **April 6, 2020**

United States Army Corps of Engineers New Orleans District Regulatory Branch 7400 Leake Avenue New Orleans, Louisiana 70118

(504) 862-2259 Project Manager Scott N. Kennedy scott.n.kennedy@usace.army.mil Permit Application Number MVN 2013-00550 EMM State of Louisiana Department of Environmental Quality Attn: Water Quality Certifications Post Office Box 4313 Baton Rouge, Louisiana 70821-4313

(225) 219-3225 Project Manager Elizabeth Hill WQC Application Number WQC 200310-03

Interested parties are hereby notified that a permit application has been received by the New Orleans District of the U.S. Army Corps of Engineers pursuant to: [X] Section 10 of the Rivers and Harbors Act of March 3, 1899 (30 Stat. 1151; 33 USC 403); and/or [X] Section 404 of the Clean Water Act (86 Stat. 816; 33 USC 1344).

Application has also been made to the Louisiana Department of Environmental Quality, Water Quality Certifications, for a Water Quality Certification (WQC) in accordance with statutory authority contained in LRS 30:2074 A(3) and provisions of Section 401 of the Clean Water Act.

# CONSTRUCT AN OIL TERMINAL ALONG THE RIGHT DESCENDING BANK OF THE MISSISSIPPI RIVER IN PLAQUEMINES PARISH

<u>NAME OF APPLICANT</u>: NOLA Oil Terminal, LLC, c/o Providence Engineering & Environ, Paul Clifton, 1201 Main Street, Baton Rouge, Louisiana 70802.

**LOCATION OF WORK**: Section 1, Township 17 South, Range 24 East, along the RDB of the Mississippi River at approximately mile marker 60 AHP, near Myrtle Grove, Louisiana, in Plaquemines Parish, as shown on the attached drawings.

HUC: 08090100: Lower Mississippi River – New Orleans

Latitude: 29.63452 Longitude: -89.94105

<u>CHARACTER OF WORK</u>: Construct and maintain an oil terminal, near Myrtle Grove, Louisiana. The oil terminal consists of 2 ship docks and 2 barge docks with all necessary infrastructure. Approximately 0.1 acres of wetlands were previously mitigated for at an approved mitigation bank. This permit, MVN 2013-00550 EQ, was previously issued in October 2013.

The comment period for the Department of the Army Permit and the Louisiana Department of Environmental Quality WQC will close <u>30 days</u> from the date of this joint public notice. Written comments, including suggestions for modifications or objections to the proposed work, stating reasons thereof, are being solicited from anyone having interest in this permit and/or this WQC request and must be mailed so as to be received before or by the last day of the comment period. Letters concerning the Corps of Engineers permit application must reference the applicant's name and the Permit Application Number, and be mailed to the Corps of Engineers at the address above, <u>ATTENTION:</u>
REGULATORY BRANCH.

Similar letters concerning the Water Quality Certification must reference the applicant's name and the WQC Application number and be mailed to the Louisiana Department of Environmental Quality at the address above.

The application for this proposed project is on file with the Louisiana Department of Environmental Quality and may be examined weekdays between 8:00 a.m. and 4:30 p.m. Copies may be obtained upon payment of costs of reproduction.

#### **Corps of Engineers Permit Criteria**

The decision whether to issue a permit will be based on an evaluation of the probable impacts, including cumulative impacts of the proposed activity on the public interest. That decision will reflect the national concern for both protection and utilization of important resources. The benefit which reasonably may be expected to accrue from the proposal must be balanced against its reasonably foreseeable detriments. All factors which may be relevant to the proposal will be considered including the cumulative effects thereof; among those are conservation, economics, aesthetics, general environmental concerns, wetlands, historic properties, fish and wildlife values, flood hazards, floodplain values, land use, navigation, shoreline erosion and accretion, recreation, water supply and conservation, water quality, energy needs, safety, food and fiber production, mineral needs, considerations of property ownership and, in general, the needs and welfare of the people.

The U.S. Army Corps of Engineers is soliciting comments from the public, federal, state, and local agencies and officials, Indian Tribes, and other interested parties in order to consider and evaluate the impacts of this proposed activity. Any comments received will be considered by the U.S. Army Corps of Engineers to determine whether to make, modify, condition, or deny a permit for this proposal. To make this decision, comments are used to assess impacts on endangered species, historic properties, water quality, general environmental effects, and other public interest factors listed above. Comments are used in the preparation of an Environmental Assessment and/or an Environmental Impact Statement pursuant to the National Environmental Policy Act. Comments are also used to determine the need for a public hearing and to determine the overall public interest of the proposed activity.

The New Orleans District is unaware of properties listed on the National Register of Historic Places near the proposed work. The possibility exists that the proposed work may damage or destroy presently unknown archeological, scientific, prehistorical, historical sites, or data. Issuance of the public notice solicits input from the State Archeologist and State Historic Preservation Office regarding potential impacts to cultural resources.

The New Orleans District has determined that the proposed work would neither affect any species or critical habitat listed as endangered by the U.S. Department of Commerce.

Utilizing Standard Local Operating Procedure for Endangered Species in Louisiana (SLOPES), dated October 22, 2014, between the U.S. Army Corps of Engineers, New Orleans and U.S. Fish and Wildlife Service, Ecological Services Office, the Corps has determined that the proposed activity would have no effect on any listed species.

This notice initiates the Essential Fish Habitat (EFH) consultation requirements of the Magnuson-Stevens Fishery Conservation and Management Act. The applicant's proposal would result in the destruction or alteration of up to <u>n/a</u> acres of EFH utilized by various life stages of red drum and penaeid shrimp. Our initial determination is that the proposed action would not have a substantial adverse impact on EFH or federally managed fisheries in the Gulf of Mexico. Our final determination relative to project impacts and the need for mitigation measures is subject to review by and coordination with the National Marine Fisheries Service.

If the proposed work involves deposits of dredged or fill material into navigable waters, the evaluation of the probable impacts will include the application of guidelines established by the Administrator of the Environmental Protection Agency. Also, a certification that the proposed activity will not violate water quality standards will be required from the Department of Environmental Quality, Water Quality Certifications, before a permit is issued.


Any person may request, in writing, within the comment period specified in this notice, that a public hearing be held to consider this application. Requests for public hearings shall state, with particularity, the reasons for holding a public hearing.


The applicant has certified that the proposed activity described in the application complies with and will be conducted in a manner that is consistent with the Louisiana Coastal Resources Program. The Department of the Army permit will not be issued unless the applicant received approval or a waiver of the Coastal Use Permit by the Department of Natural Resources.


You are requested to communicate the information contained in this notice to any other parties whom you deem likely to have interest in the matter.

Michael Farabee Chief, Eastern Evaluation Section

Enclosures

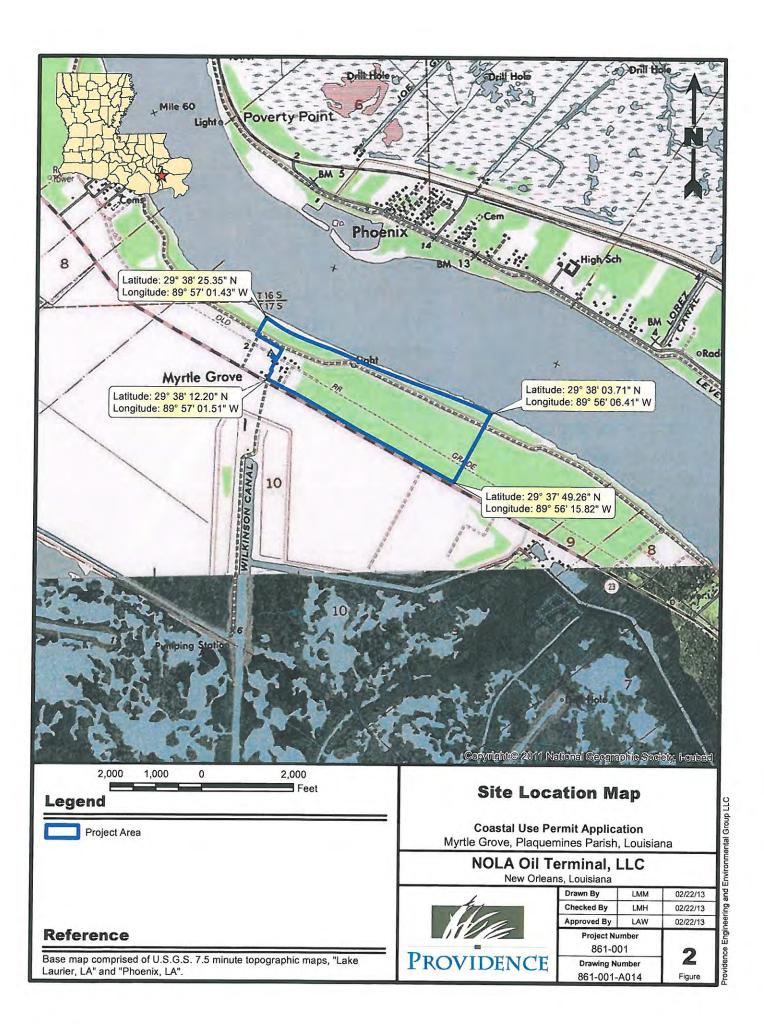

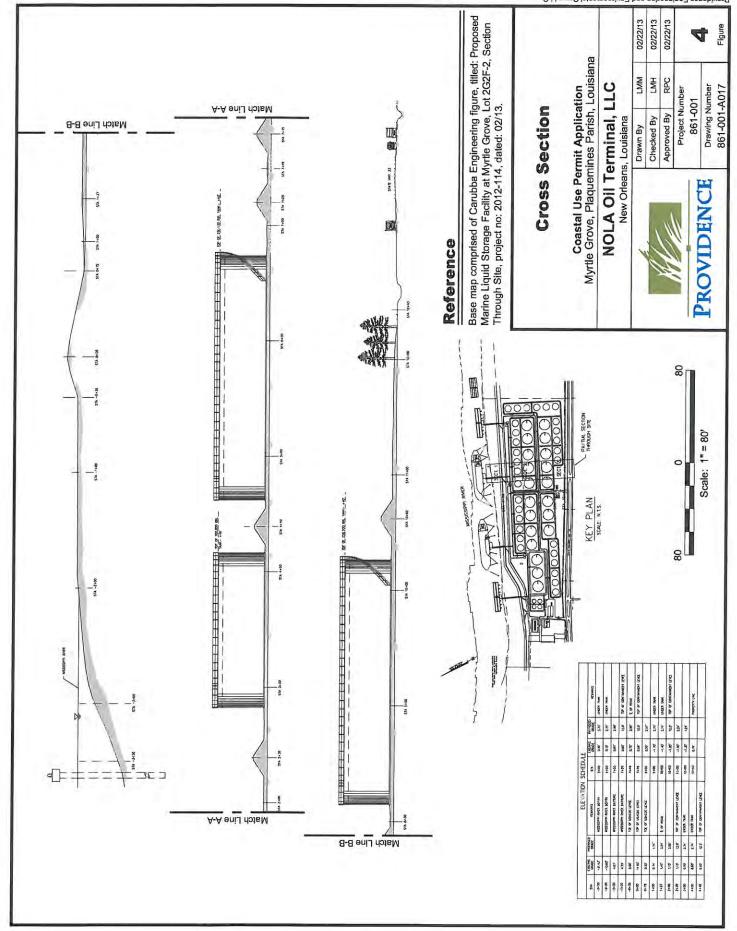

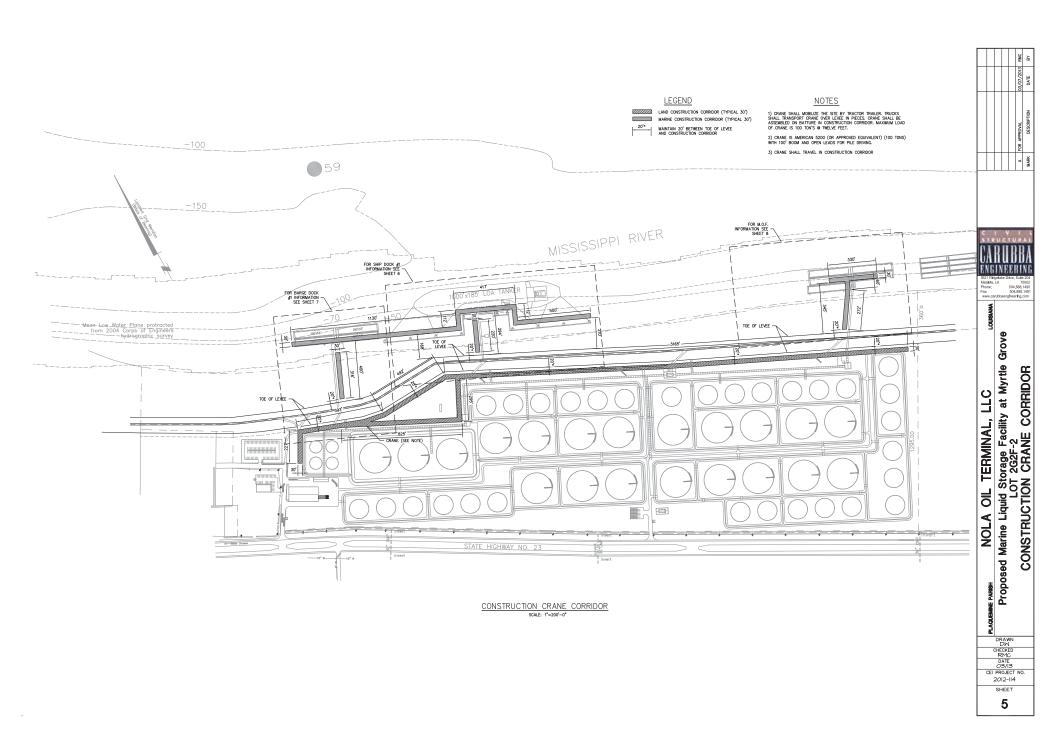




### LEGEND

MARINE CONSTRUCTION CORRIDOR (TYPICAL 30')



MAINTAIN 20' BETWEEN TOE OF LEVEE AND CONSTRUCTION CORRIDOR

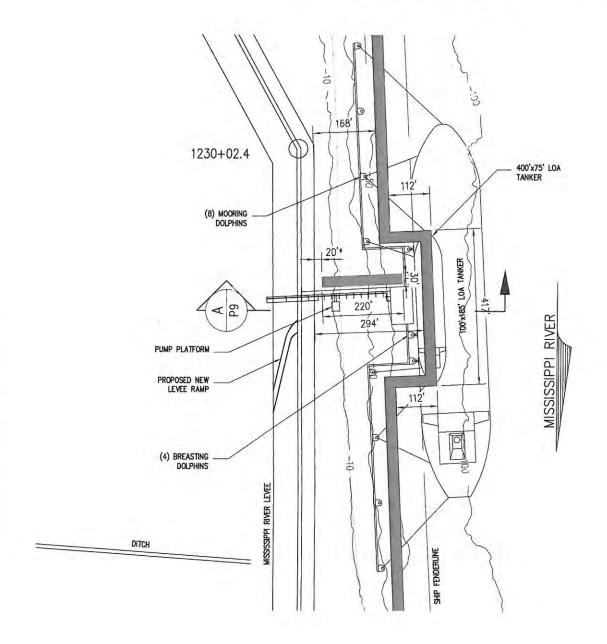

PROPOSED SHIP DOCK #1 - PHASE 1 scale: 1" = 20'



3621 Ridgelake Drive, Suite 204

Metairie, LA 70002

Phone: 504.888.1490 Fax: 504.888.1491

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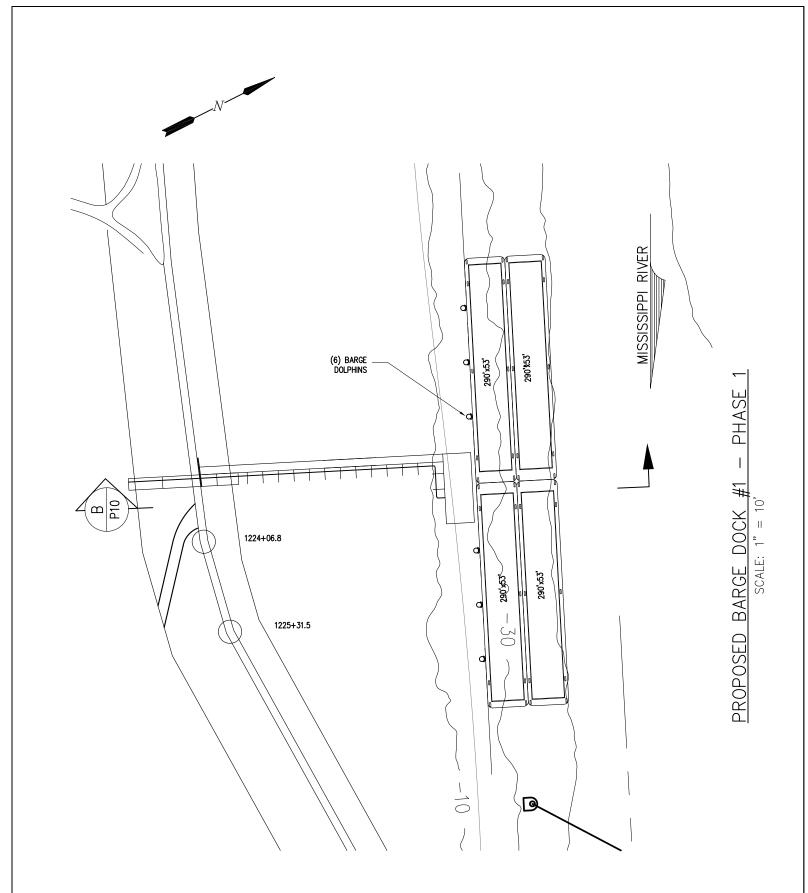
NOLA OIL TANK TERMINAL

MYRTLE GROVE

LOUISIANA

MARINE SITE PLAN
ENLARGED SITE PLAN-PHASE 1
PROPOSED SHIP DOCK #1

DATE	OCT. 12
DESIGN	ARF
DRAWN	JP
CHECK	NPL
JOB #	2012-114
SHEET N	0.





Phone: 504.888.1490 Fax: 504.888.1491


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### NOLA OIL TANK FARM

MYRTLE GROVE LOUISIANA

MARINE SITE PLAN
ENLARGED SITE PLAN-PHASE 1
PROPOSED BARGE DOCK #1

	DATE MA	Y 16, 2013
	DESIGN	RMC
	DRAWN	DW
1	CHECK _	RMC
	JOB # _2	012-114
	SHEET No.	_



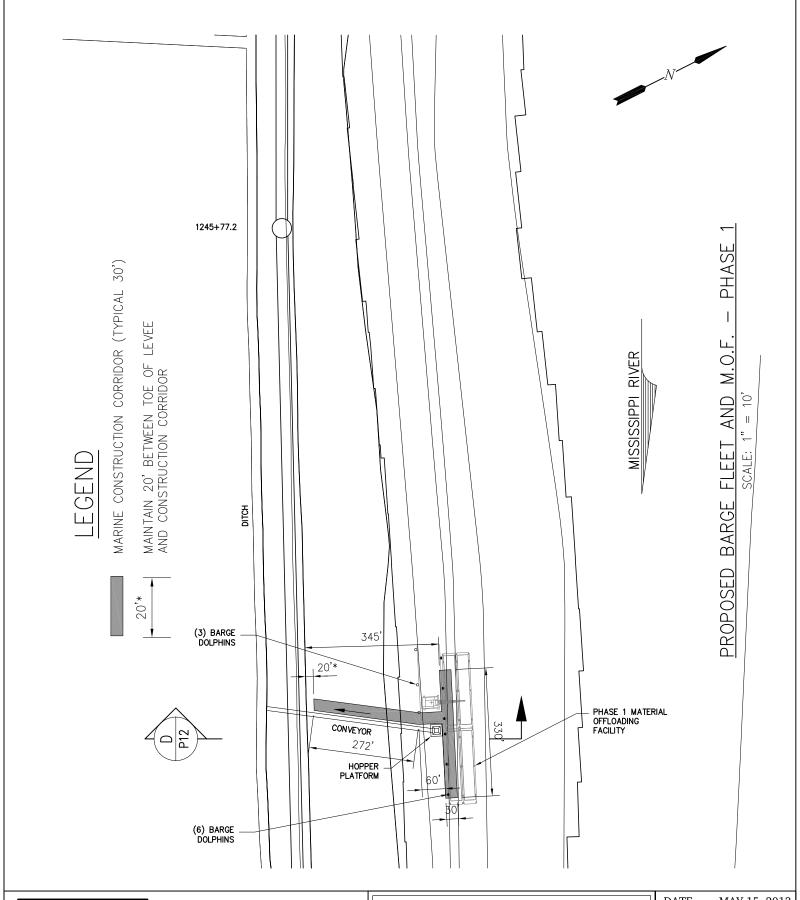

Phone: 504.888.1490 Fax: 504.888.1491


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### NOLA OIL TANK TERMINAL

MYRTLE GROVE LOUISIANA

MARINE SITE PLAN ENLARGED SITE PLAN-PHASE 1 PROPOSED BARGE FLEET + M.O.F.

DATE	MAY 15, 2	2013
DESIGN	ARF	_
DRAWN	JP	
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JOB #	2012-114	
SHEET N	lo.	



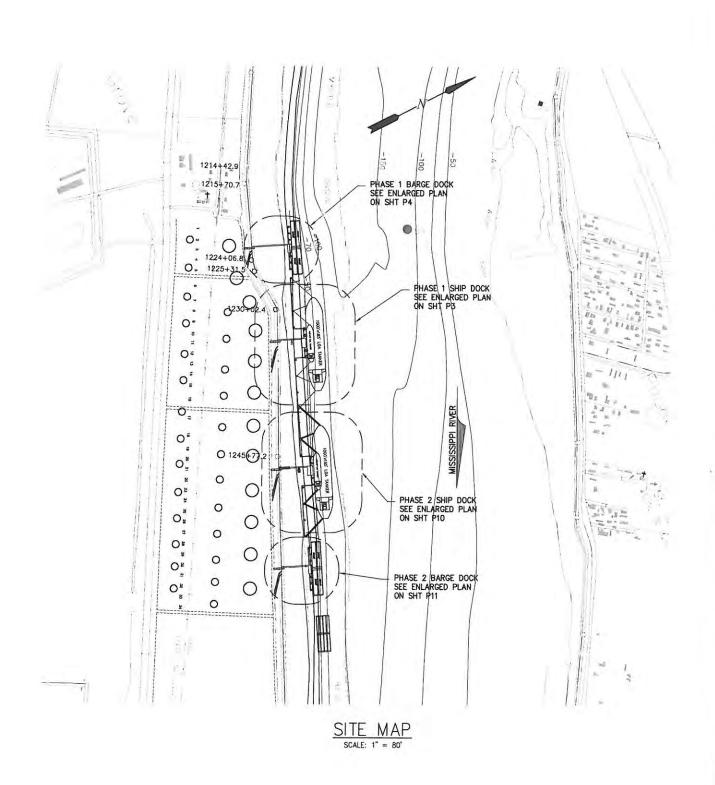

Phone:

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Fax: 504.888.1493 www.carubbaengineering.com

#### NOLA OIL TANK TERMINAL

MYRTLE GROVE

LOUISIANA

MARINE SITE PLAN
PROPOSED NEW LIQUID TERMINAL
PHASE 2


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JOB #	2012-114
SHEET N	0.

## LEGEND

MARINE CONSTRUCTION CORRIDOR (TYPICAL 30')

MAINTAIN 20' BETWEEN TOE OF LEVEE AND CONSTRUCTION CORRIDOR



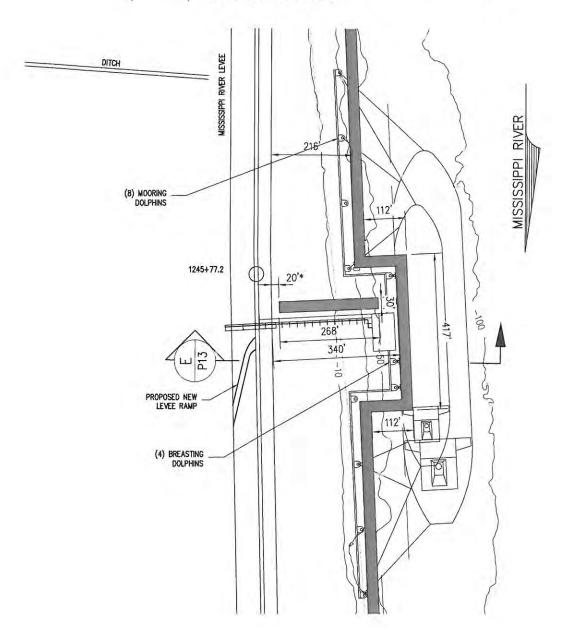

PROPOSED SHIP DOCK #2 - PHASE 2



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#### NOLA OIL TANK TERMINAL

MYRTLE GROVE

LOUISIANA

MARINE SITE PLAN
ENLARGED SITE PLAN-PHASE 2
PROPOSED SHIP DOCK #2


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## LEGEND

MARINE CONSTRUCTION CORRIDOR (TYPICAL 30')

20'\*

MAINTAIN 20' BETWEEN TOE OF LEVEE AND CONSTRUCTION CORRIDOR



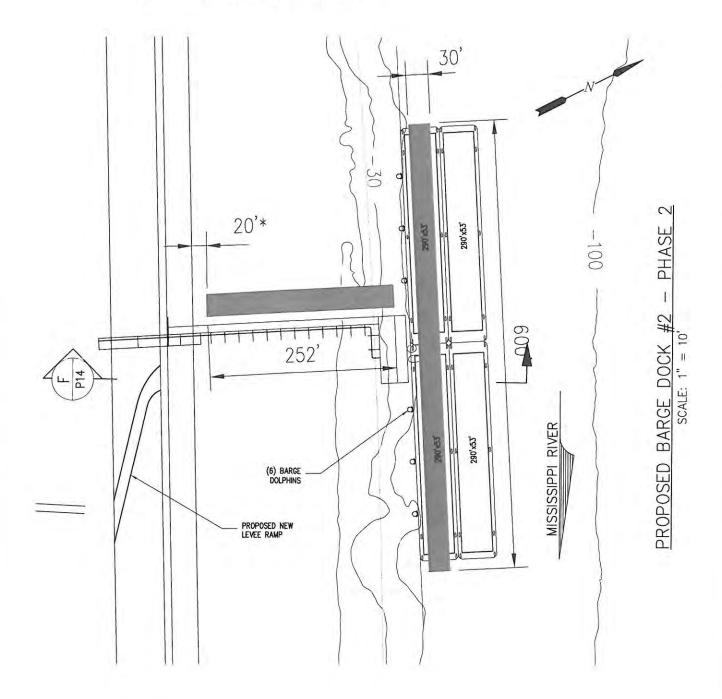

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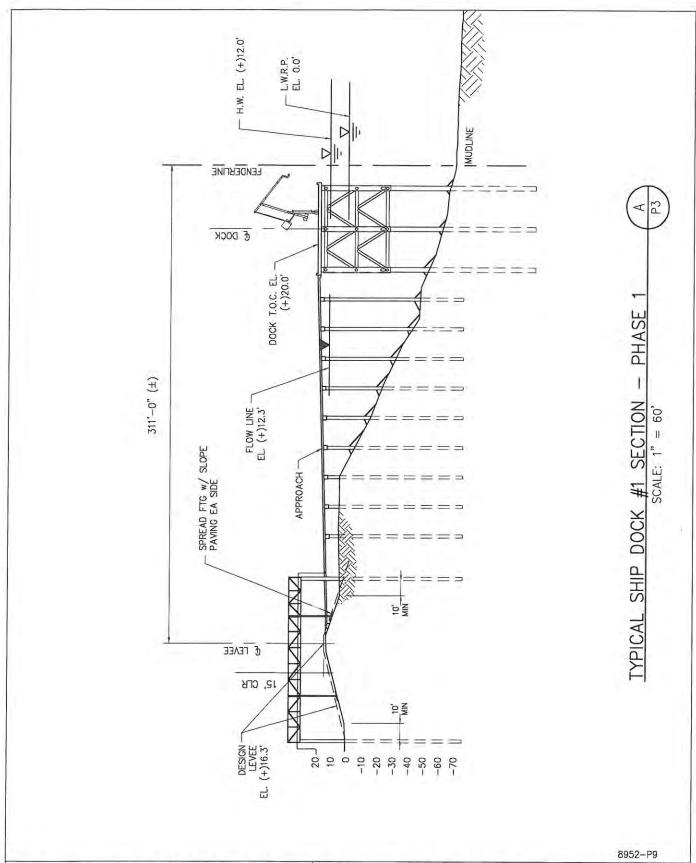
#### NOLA OIL TANK TERMINAL

MYRTLE GROVE

LOUISIANA

MARINE SITE PLAN ENLARGED SITE PLAN-PHASE 2 PROPOSED BARGE DOCK #2

DATE	OCT. 12
DESIGN	ARF
DRAWN	JP
CHECK	NPL
JOB #	2012-114
SHEET N	0.
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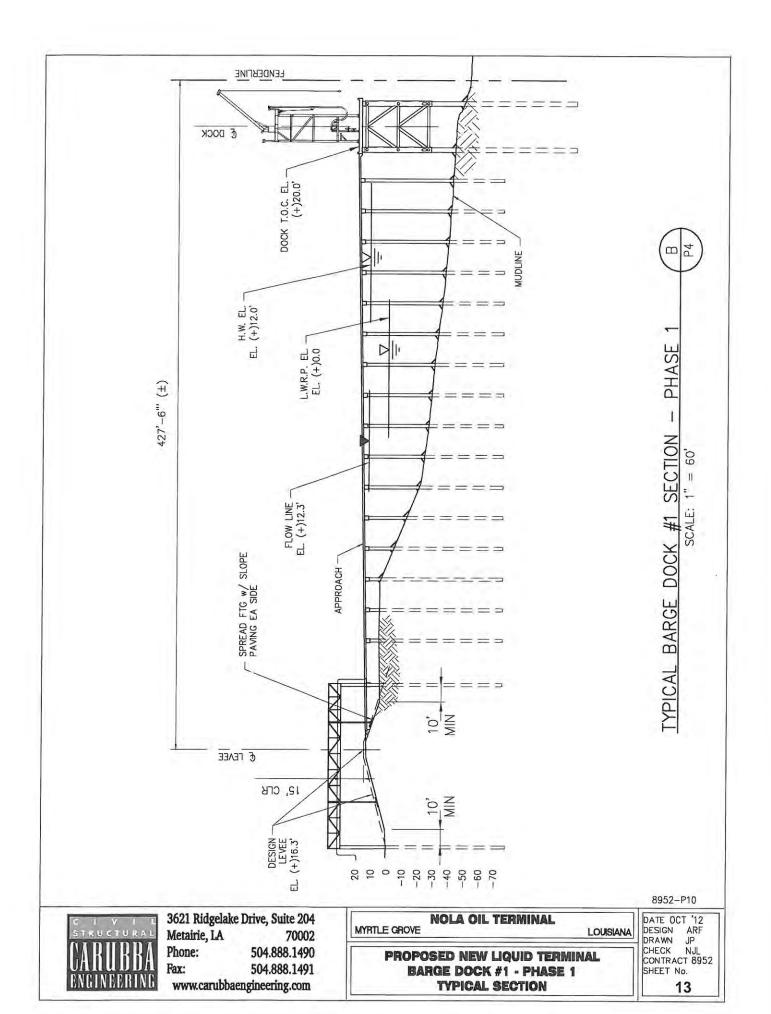
MYRTLE GROVE


**NOLA OIL TERMINAL** 

LOUISIANA

DATE OCT '12
DESIGN ARF
DRAWN JP
CHECK NJL
CONTRACT 8952
SHEET No.

PROPOSED NEW LIQUID TERMINAL SHIP DOCK #1 - PHASE 1 TYPICAL SECTION



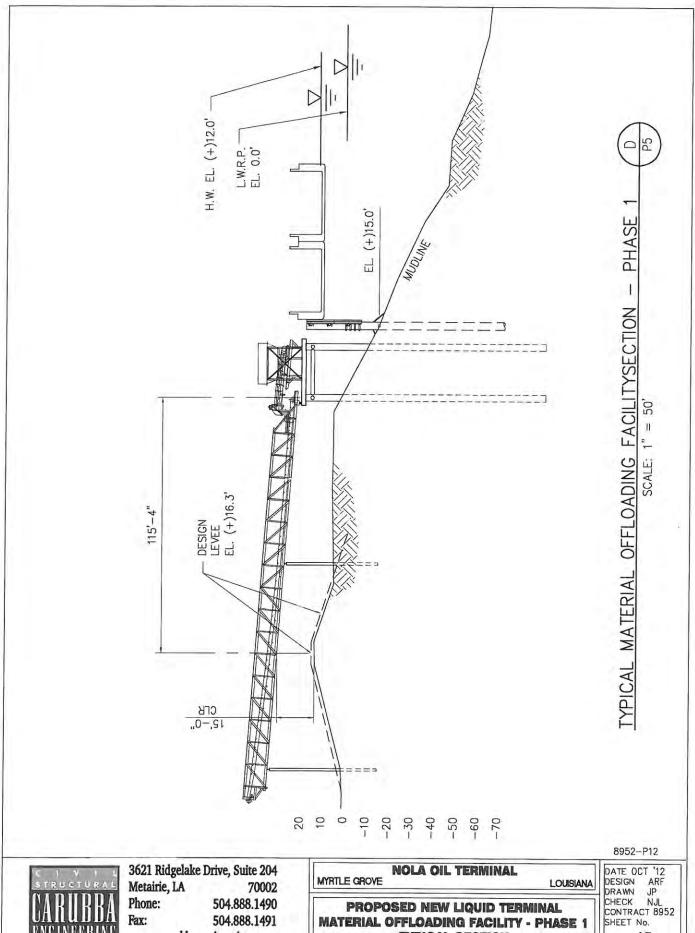




504.888.1490 Phone:

504.888.1491 Fax:

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15

PROPOSED NEW LIQUID TERMINAL MATERIAL OFFLOADING FACILITY - PHASE 1 TYPICAL SECTION



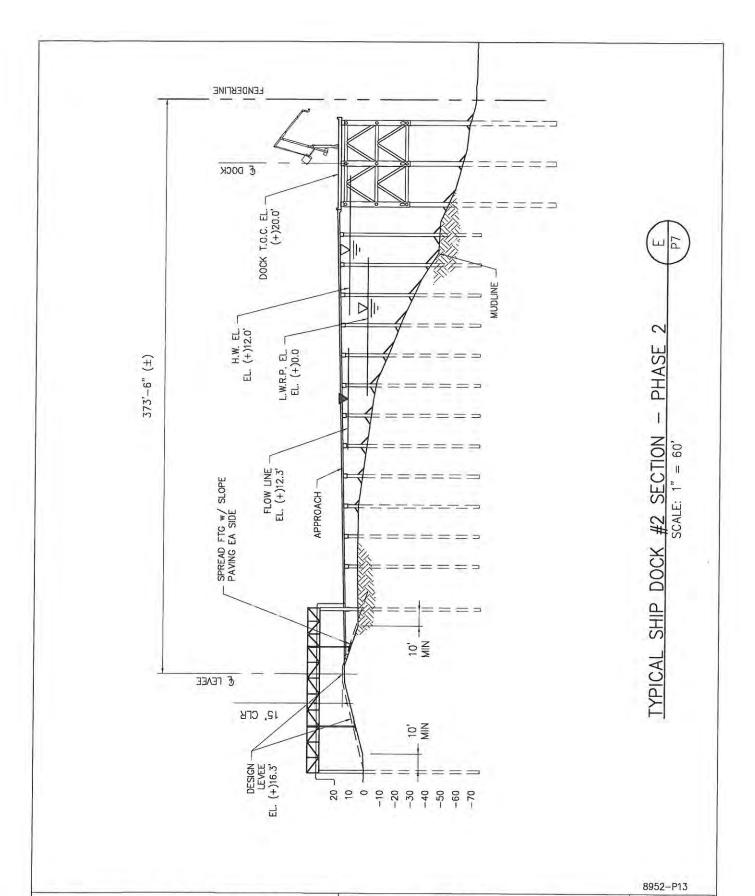

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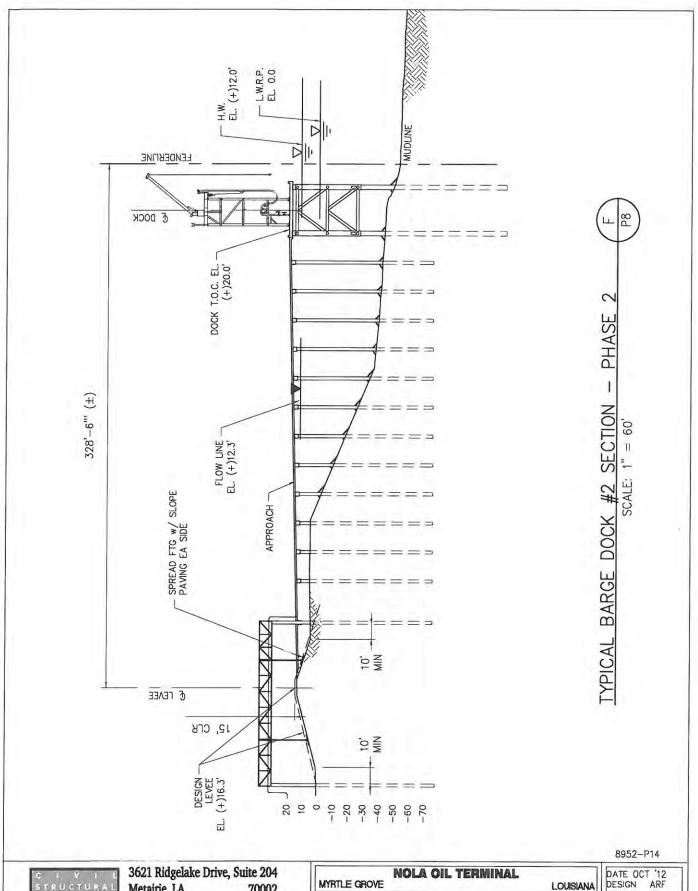
#### **NOLA OIL TERMINAL** MYRTLE CROVE

LOUISIANA

DATE OCT '12 DESIGN ARF DRAWN JP CHECK NJL CONTRACT 8952 SHEET No.

16

PROPOSED NEW LIQUID TERMINAL SHIP DOCK #2 - PHASE 2 TYPICAL SECTION





Metairie, LA 70002


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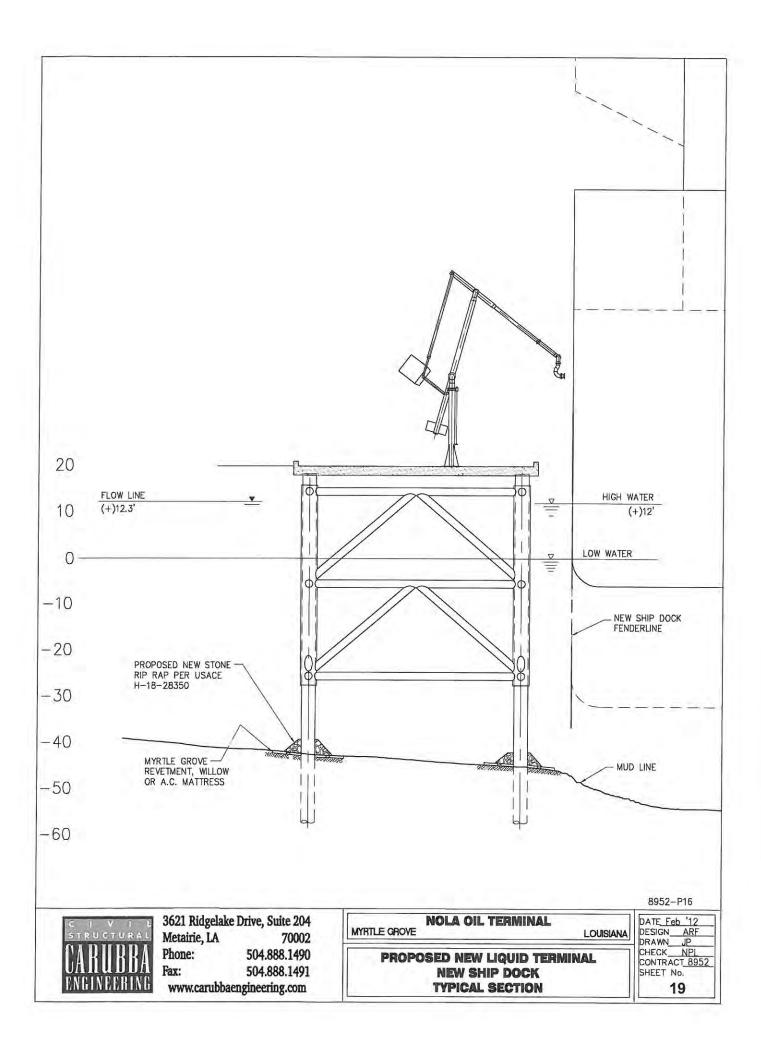
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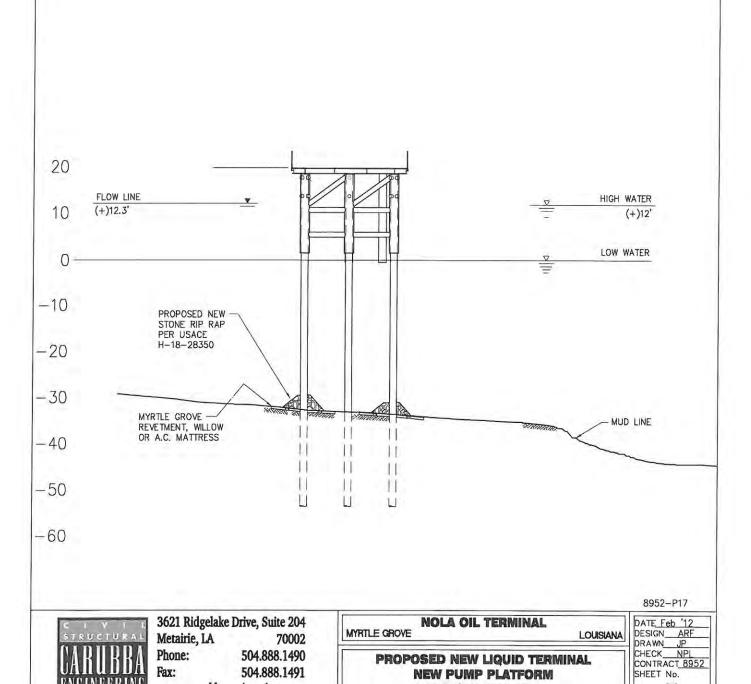
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CONTRACT 8952
SHEET No.

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PROPOSED NEW LIQUID TERMINAL BARGE DOCK #2 - PHASE 2 TYPICAL SECTION





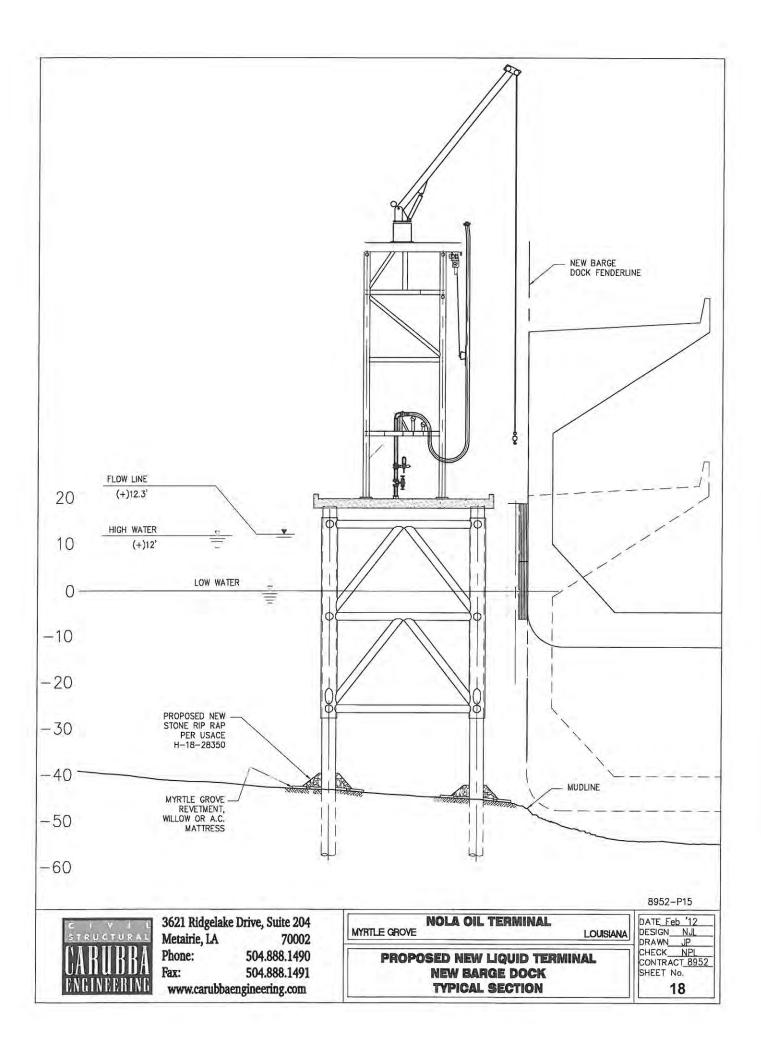

Fax:


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PROPOSED NEW LIQUID TERMINAL

**NEW PUMP PLATFORM** 

TYPICAL SECTION



PROPOSED NEW **BREASTING DOLPHIN** 

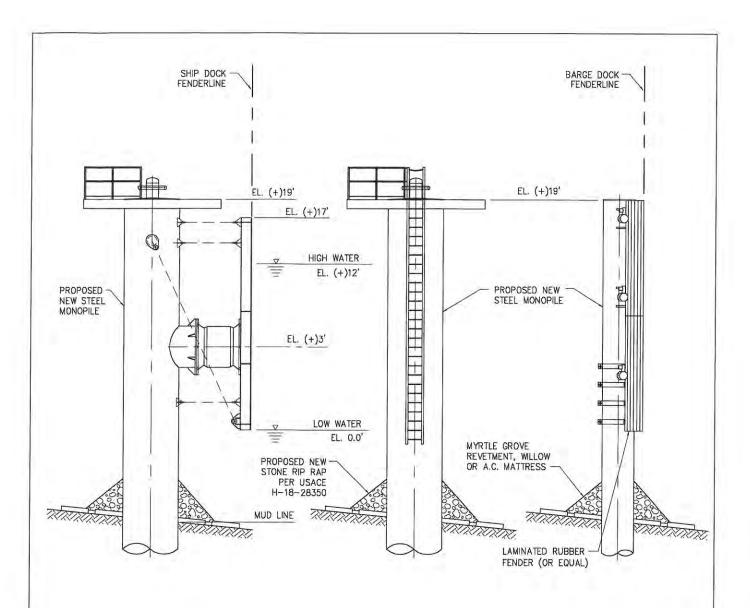SCALE: N.T.S.

PROPOSED NEW MOORING DOLPHIN

SCALE: N.T.S.

PROPOSED NEW BARGE DOLPHIN

SCALE: N.T.S.



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MYRTLE GROVE


**NOLA OIL TERMINAL** 

LOUISIANA

DATE Feb '12 DESIGN NJL DRAWN JP CHECK NJL CONTRACT 8952 SHEET No. 21

8952-P18

PROPOSED NEW LIQUID TERMINAL **NEW DOCK DOLPHINS** 

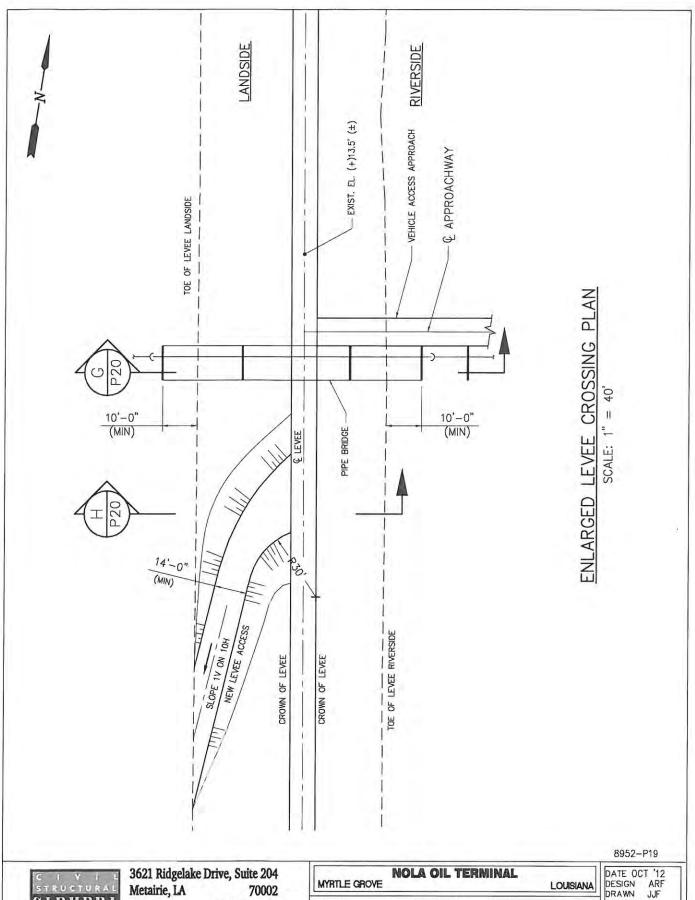



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DATE OCT '12
DESIGN ARF
DRAWN JJF
CHECK NJL
CONTRACT 8952
SHEET No. PROPOSED NEW LEVEE CROSSING

LEVEE CROSSING PLAN



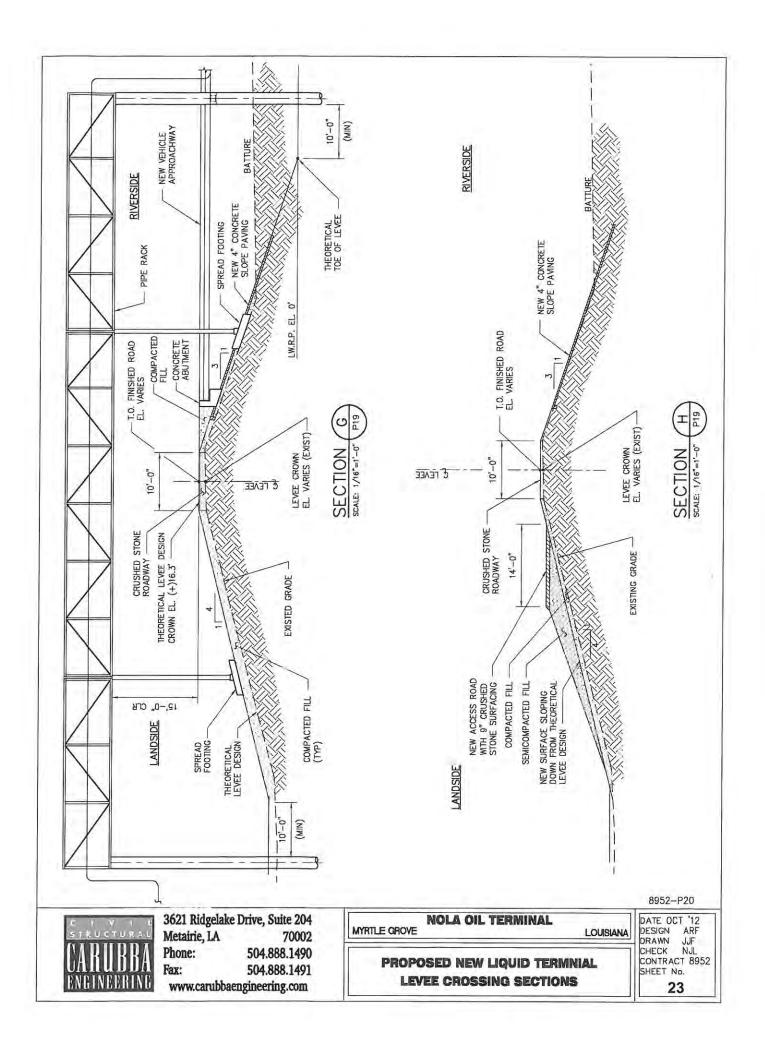

DEPTH OF WATER IN FEET AT POINT OF PENETRATION AT TIME OF STONE PLACEMENT	DIMENSIONS IN FEET FOR PROTECTION AREA REQUIRED							
	PILE		CAISSON		SPUD PILE W/ ANCHOR CHAIN & BUOY		PILE CLUSTER	
	X	Y	X	Y	X	Y	X	Y
1 TO 10	3	1 1/2	5	2			3	1
11 TO 40	5	2	8	3	7	3	6	2
41 TO 60	8	3	12	4	12	4	10	3
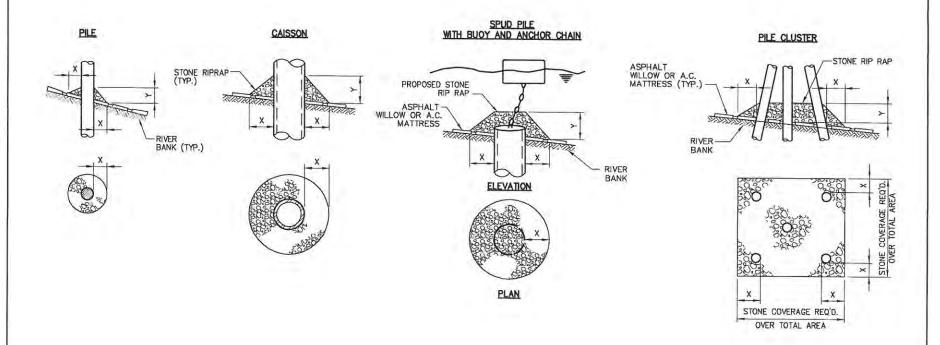
#### NOTES:

- 1. SIZE OF RIPRAP TO VARY BETWEEN 6 POUNDS AND 125 POUNDS WITH 40% TO 60% OF THE STONE WITHIN THE RANGE OF 25 POUNDS TO 75 POUNDS.
- 2. WHEN PENETRATING UPPER BANK PAVING IN A REVETMENT AREA WITH PILES, CAISSONS AND/OR PILE CLUSTERS, A 10 INCH THICKNESS OF RIPRAP STONE SHALL BE PLACED OVER ALL AREAS WHERE BANK PAVING IS DISTURBED BY DRIVING OPERATIONS.
- 3. WHEN USING ANCHOR CHAIN AND BUOY SYSTEM ANCHOR CHAIN MUST BE ATTACHED AT TOP OF PILE TO MINIMIZE REVETMENT DAMAGE.



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REPAIR PROCEDURES REQUIRED WHEN PENETRATING REVETMENTS WITH PILES, CAISSONS AND/OR PILE CLUSTERS

U.S ARMY ENGINEERS DISTRICT, NEW ORLEANS CORPS OF ENGINEERS

DEC. 1987

FILE NO. H-18-28350

